FLOOR PLAN NOTES:

- BUILDER OR CONTRACTOR TO COMPLY WITH ALL THE CUREENT IRC CODES REQUIRED BY THE LOCAL JURISDICTION. REFER TO LOCAL JURISDICTIONAL CODE FOR VARIOUS PROVISIONS WHICH OVERRIDE OR SUPPLEMENT THE IRC.

- DO NOT SCALE DRAWINGS. WRITTEN DIMENSIONS TAKE PRECEDENCE. BUILDER/ CONTRACTOR TO VERIFY AND BE RESPONSIBLE FOR ALL DIMENSIONS AND CONDITIONS ON THE JOB AND NOTIFY OF ANY VARIATIONS FROM THE DIMENSIONS OR CONDITIONS

SHOWN ON THE DRAWINGS PRESENTED HEREIN. - ALL WRITTEN NOTES ON THESE DRAWINGS SHALL TAKE PRECEDENCE OVER THE MINIMUM STANDARD

- ALL ANGLES TO BE 45 DEGREES U.O.N. - ALL EGRESS WINDOW SILLS TO BE A MAXIMUM OF 44" ABOVE FINISHED FLOOR. MINIMUM WINDOW OPENINGS ARE 24" HIGH, 20" WIDE AND MIN. 5.7 SQ.FT. NET CLEAR OPENING. WHERE DOORS ARE USED AS EGRESS, PROVIDE LOCKING HARDWARE THAT DOES NOT REQUIRE A KEY TO OPEN FROM THE INSIDE. ALL WINDOW HEAD HEIGHTS TAKEN FROM IMMEDIATE INTERIOR FLOOR LEVEL. HEAD HEIGHTS IN STAIRWELLS TAKEN FROM FIRST FLOOR LEVEL (AT THE STAIRWELL). - STAIRWAYS SHALL COMPLY WITH IRC STANDARDS

WITH IRC STANDARDS FOR HEIGHT, LOAD DESIGN, GRIPPING SURFACE AND DIAMETER - ALL RAILING (WOOD, METAL OR PRECAST) TO HAVE 4" MAXIMUM SPACING BETWEEN BALUSTERS (SPINDLES) AND TO CONFORM WITH IRC

- ALL GUARDRAIL AND HANDRAIL SHALL COMPLY

a. INTERIOR GUARDS SHALL NOT BE CONSTRUCTED WITH HORIZONTAL RAILS OR OTHER ORNAMENTAL PATTERN THAT RESULTS IN A LADDER EFFECT

b. EXTERIOR GUARDS TO HAVE RAILING NO LOWER THAN 42" FROM FINISHED FLOOR, WITH NO LESS THAN 36" DISTANCE FROM TOP OF GUARD TO BOTTOM OF LOWEST RUNNER. MAXIMUM UNSUPPORTED SPAN OF LOWEST RUNNER SHALL BE 6'-0".

- ALL BRICK OR PREFAB FIREPLACES TO BE BUILT AND INSTALLED PER IRC. A COPY OF THE MANUFACTURER INSTALLATION MANUAL WILL BE AVAILABLE ON SITE FOR INSPECTOR REVIEW.

- LOCATE GAS WATER HEATER IN ATTIC ABV. LOAD BEARING PARTITION IN PAN WITH RELIEF DRAIN LINE TO OUTSIDE, INSTALLATION MUST COMPLY WITH MANUF. INSTRUCT. AND ALL APPLICABLE CODES. - PROVIDE SPARK ARRESTORS AT CHIMNEY. MESH TO HAVE MAXIMUM GAP OF 1/2", MINIMUM GAP OF 3/8" AND TO COMPLY WITH IRC.

- PROVIDE 24" WIDE PLYWOOD WALKWAY TO ACCESS ALL MECHANICAL EQUIPMENT LOCATED IN ATTIC. MAXIMUM DISTANCE FROM ATTIC ACCESS TO EQUIPMENT SHALL NOT EXCEED 20'-0". PROVIDE A 30" WIDE SERVICE PLATFORM AT SERVICE SIDE OF ALL EQUIPMENT IN ATTIC.

- PROVIDE ATTIC ACCESS WITH A MINIMUM CLEAR OPENING OF 22" X 30". PROVIDE MINIMUM HEAD CLEARANCE OF 30". WHERE SERVICING MECHANICAL EQUIPMENT, THE MINIMUM SIZE OF A PULL DOWN STAIR IS 30"x54", AND TO HAVE A MINIMUM LOAD CAPACITY OF 350 LBS. - ALL CLG. HTS. AND HD. HTS. TAKEN FROM WHERE THE

- SAFETY GLASS AT FRENCH DOORS - LOCATE H.V.A.C. EQUIPMENT IN ATTIC. - ALL MECHANICAL EQUIPMENT EXHAUST MUST TERMINATE ON THE EXTERIOR OF THE STRUCTURE.

BATH NOTES:

NOTE IS LOCATED ON PLAN.


- TILE FLOORS (AT WET AREAS) - ANY GLASS AT TUBS AND SHOWERS SHALL BE TEMPERED SAFETY GLASS AND MUST COMPLY WITH R308 (IRC 2009)


- SHOWER STALLS AND TUB (WITH SHOWER HEADS) WALLS. TO BE FINISHED WITH NON ABSORBENT SURFACE TO A HT. OF NOT LESS THAN 72" ABV. DRAIN INLET OVER CONCRETE BACKERBOARD - ALL PLUMBING FIXTURES SHALL BE SPACED PER R307.2 (IRC 2009)

- BUILDER TO VERIFY ROUGH OPENING OF TUB WITH MANUFACTURER PRIOR TO CONSTRUCTION TYPICAL - PROVIDE PLUMBING ACCESS PANEL AT ALL BATHTUBS BY IRC 2000 SECT. P2704.1.

SQ. FOOTAGE				
	FRAME	MAS.		
1st FLOOR	1689	1696		
2nd FLOOR	259	259		
TOTAL	1948	1955		
GARAGE	455	469		
FRONT PORCH	31	31		
COVERED PATIO	114	114		
TOTAL SLAB	2289	2310		
TOTAL COVER	2548	2569		

PRESTON GRANT DESIGN IS A PROFESSIONAL BUILDING DESIGN FIRM. WE ARE NOT QUALIFIED TO NOR LICENSED TO DESIGN STRUCTURAL FRAMING OR FOUNDATIONS. A LICENSED PROFESSIONAL ENGINEER SHOULD BE CONSULTED REGARDING THE FRAMING AND FOUNDATION DESIGN OF THE PROPOSED STRUCTURE. SHOULD AN ENGINEER'S SEAL (OR ARCHTITECT AND/OR CERTIFIED BUILDING DESIGNER SEAL) BE PRESENT ON THE DRAWINGS, THE "ENGINEER OF RECORD" SHALL BEAR THE RESPONSIBILITY FOR THE STRUCTURAL DESIGN. PRESTON GRANT DESIGN WILL NOT BE HELD RESPONSIBLE FOR THE STRUCTURAL DESIGN IN ANY WAY AND/OR ANY PROBLEMS WHICH MAY ARISE.

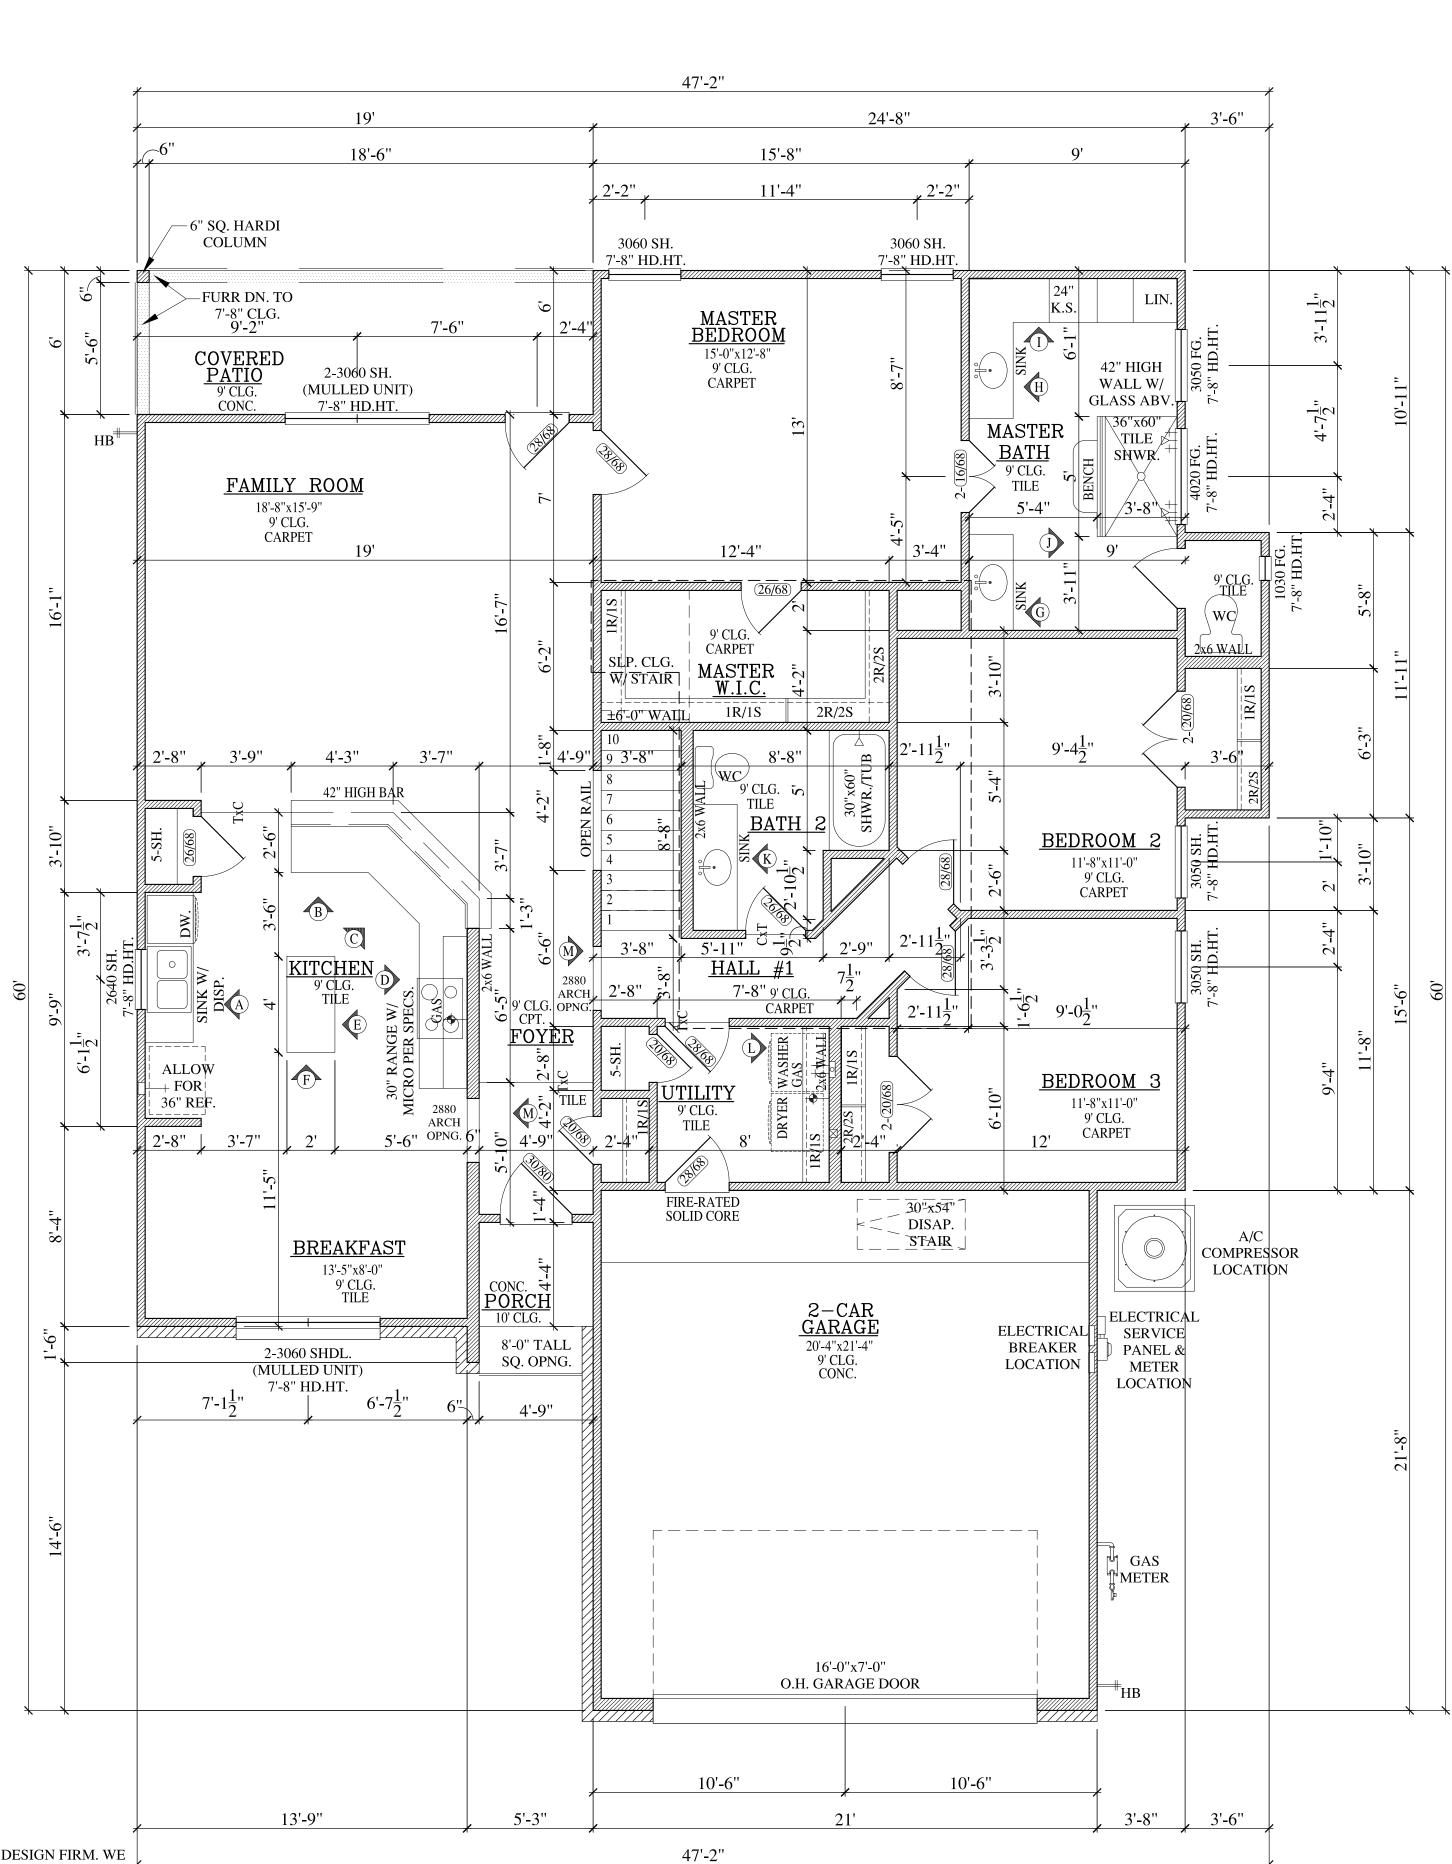

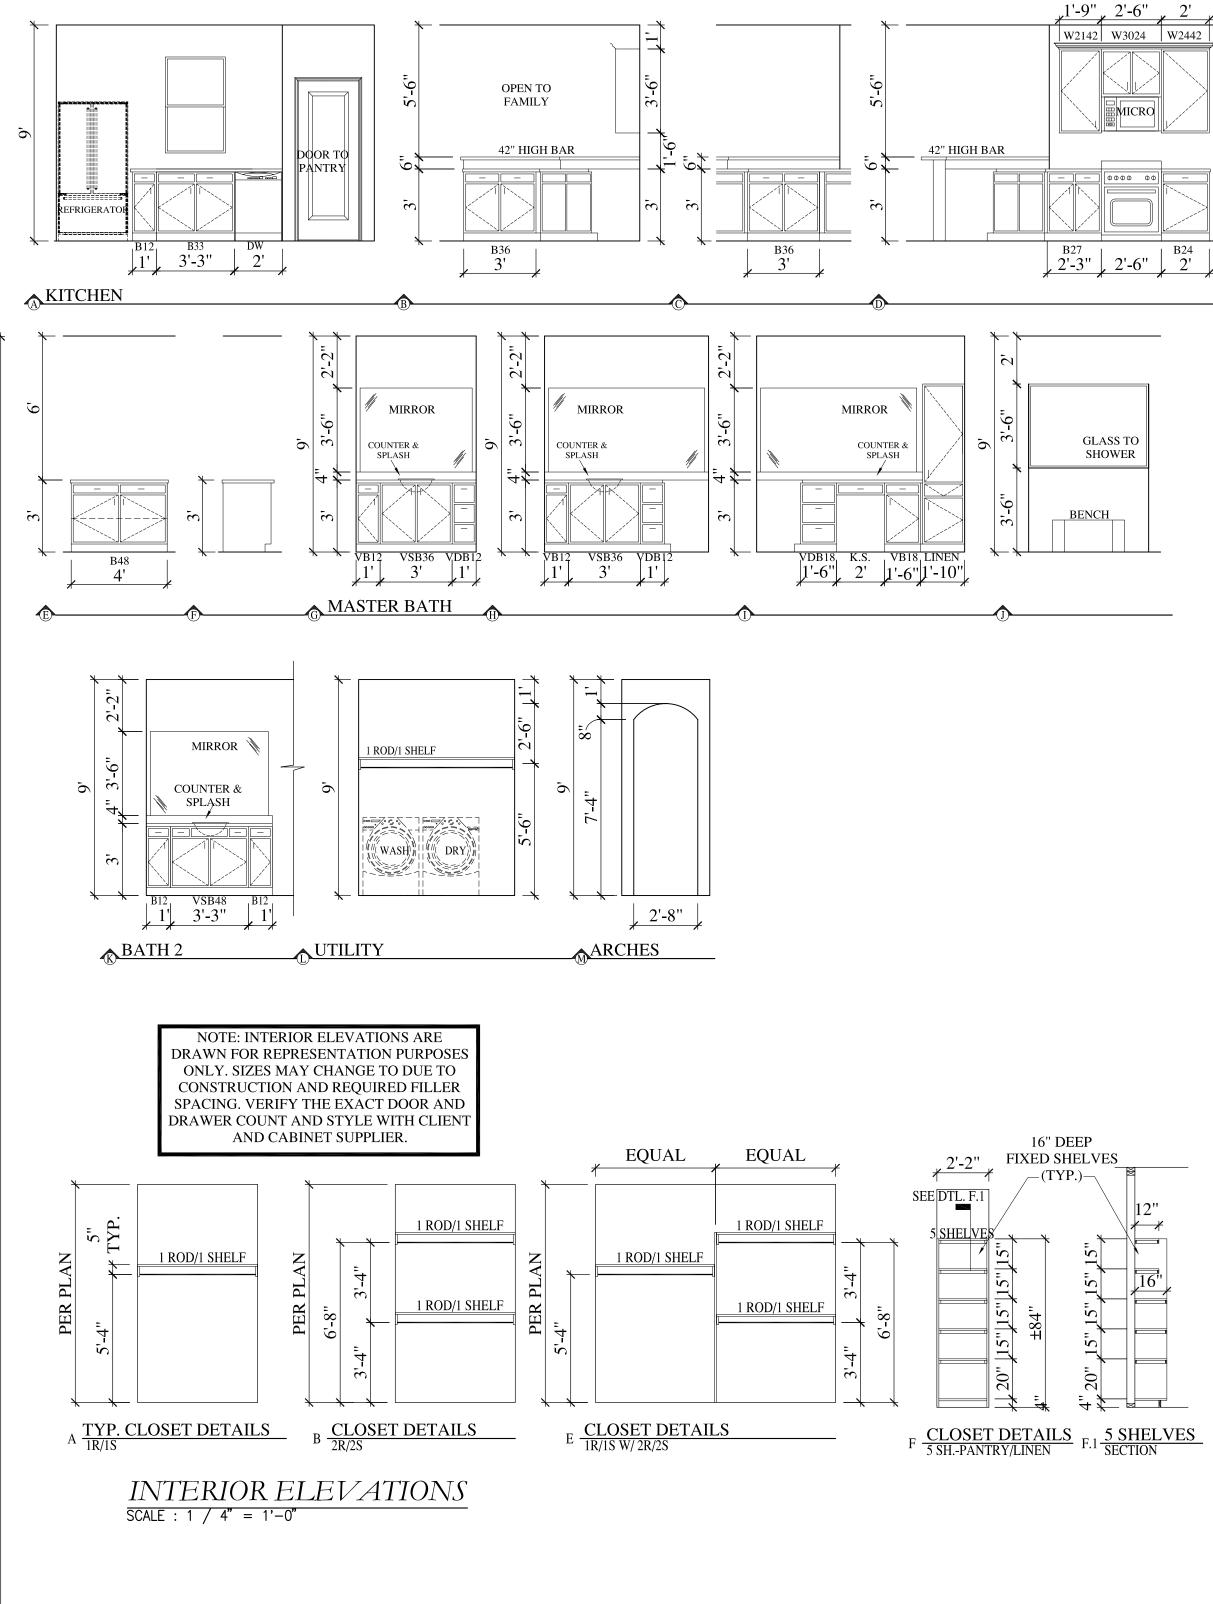



1/4" = 1'-0" DRAWN BY: CHECKED BY: 10/17/17 FLOOR PLAN

FLOOR PLAN NOTES:

- BUILDER OR CONTRACTOR TO COMPLY WITH ALL THE CUREENT IRC CODES REQUIRED BY THE LOCAL JURISDICTION. REFER TO LOCAL JURISDICTIONAL CODE FOR VARIOUS PROVISIONS WHICH OVERRIDE OR SUPPLEMENT THE IRC.
- DO NOT SCALE DRAWINGS. WRITTEN DIMENSIONS TAKE PRECEDENCE, BUILDER/CONTRACTOR TO VERIEY

TAKE PRECEDENCE. BUILDER/ CONTRACTOR TO VERIFY AND BE RESPONSIBLE FOR ALL DIMENSIONS AND CONDITIONS ON THE JOB AND NOTIFY OF ANY VARIATIONS FROM THE DIMENSIONS OR CONDITIONS SHOWN ON THE DRAWINGS PRESENTED HEREIN.
- ALL WRITTEN NOTES ON THESE DRAWINGS SHALL TAKE PRECEDENCE OVER THE MINIMUM STANDARD

TAKE PRECEDENCE OVER THE MINIMUM STANDARD NOTES.

- ALL ANGLES TO BE 45 DEGREES U.O.N.

- ALL EGRESS WINDOW SILLS TO BE A MAXIMUM OF 44"
ABOVE FINISHED FLOOR. MINIMUM WINDOW OPENINGS ARE 24" HIGH, 20" WIDE AND MIN. 5.7 SQ.FT. NET CLEAR OPENING. WHERE DOORS ARE USED AS EGRESS,

OPENING. WHERE DOORS ARE USED AS EGRESS,
PROVIDE LOCKING HARDWARE THAT DOES NOT
REQUIRE A KEY TO OPEN FROM THE INSIDE. ALL
WINDOW HEAD HEIGHTS TAKEN FROM IMMEDIATE
INTERIOR FLOOR LEVEL. HEAD HEIGHTS IN STAIRWELLS
TAKEN FROM FIRST FLOOR LEVEL (AT THE STAIRWELL).
- STAIRWAYS SHALL COMPLY WITH IRC STANDARDS
- ALL GUARDRAIL AND HANDRAIL SHALL COMPLY
WITH IRC STANDARDS FOR HEIGHT, LOAD DESIGN,
GRIPPING SURFACE AND DIAMETER

WITH IRC STANDARDS FOR HEIGHT, LOAD DESIGN,
GRIPPING SURFACE AND DIAMETER
- ALL RAILING (WOOD, METAL OR PRECAST) TO HAVE 4"
MAXIMUM SPACING BETWEEN BALUSTERS (SPINDLES)

AND TO CONFORM WITH IRC.

a. <u>INTERIOR</u> GUARDS SHALL NOT BE

CONSTRUCTED WITH HORIZONTAL RAILS OR OTHER

ORNAMENTAL PATTERN THAT RESULTS IN A LADDER

EFFECT

b. EXTERIOR GUARDS TO HAVE RAILING NO
LOWER THAN 42" FROM FINISHED FLOOR, WITH NO LESS
THAN 36" DISTANCE FROM TOP OF GUARD TO BOTTOM
OF LOWEST RUNNER. MAXIMUM UNSUPPORTED SPAN
OF LOWEST RUNNER SHALL BE 6'-0".

- ALL BRICK OR PREFAB FIREPLACES TO BE BUILT AND INSTALLED PER IRC. A COPY OF THE MANUFACTURER INSTALLATION MANUAL WILL BE AVAILABLE ON SITE FOR INSPECTOR REVIEW.

- LOCATE GAS WATER HEATER IN ATTIC ABV. LOAD BEARING PARTITION IN PAN WITH RELIEF DRAIN LINE TO OUTSIDE, INSTALLATION MUST COMPLY WITH MANUF. INSTRUCT. AND ALL APPLICABLE CODES.
- PROVIDE SPARK ARRESTORS AT CHIMNEY. MESH TO HAVE MAXIMUM GAP OF 1/2", MINIMUM GAP OF 3/8" AND TO COMPLY WITH IRC.

- PROVIDE 24" WIDE PLYWOOD WALKWAY TO ACCESS ALL MECHANICAL EQUIPMENT LOCATED IN ATTIC. MAXIMUM DISTANCE FROM ATTIC ACCESS TO EQUIPMENT SHALL NOT EXCEED 20'-0". PROVIDE A 30" WIDE SERVICE PLATFORM AT SERVICE SIDE OF ALL EQUIPMENT IN ATTIC.

- PROVIDE ATTIC ACCESS WITH A MINIMUM CLEAR OPENING OF 22" X 30". PROVIDE MINIMUM HEAD CLEARANCE OF 30". WHERE SERVICING MECHANICAL EQUIPMENT, THE MINIMUM SIZE OF A PULL DOWN STAIR IS 30"x54", AND TO HAVE A MINIMUM LOAD CAPACITY OF 350 LBS.
- ALL CLG. HTS. AND HD. HTS. TAKEN FROM WHERE THE

SAFETY GLASS AT FRENCH DOORS
LOCATE H.V.A.C. EQUIPMENT IN ATTIC.
ALL MECHANICAL EQUIPMENT EXHAUST MUST TERMINATE ON THE EXTERIOR OF THE STRUCTURE.

NOTE IS LOCATED ON PLAN.

BATH NOTES:


- TILE FLOORS (AT WET AREAS)
- ANY GLASS AT TUBS AND SHOWERS SHALL BE
TEMPERED SAFETY GLASS AND MUST COMPLY WITH
R308 (IRC 2009)
- SHOWER STALLS AND TUB (WITH SHOWER HEADS)

WALLS. TO BE FINISHED WITH NON ABSORBENT SURFACE TO A HT. OF NOT LESS THAN 72" ABV. DRAIN INLET OVER CONCRETE BACKERBOARD - ALL PLUMBING FIXTURES SHALL BE SPACED PER

R307.2 (IRC 2009)
- BUILDER TO VERIFY ROUGH OPENING OF TUB WITH

MANUFACTURER PRIOR TO CONSTRUCTION TYPICAL
- PROVIDE PLUMBING ACCESS PANEL AT ALL BATHTUBS
BY IRC 2000 SECT. P2704.1.

8:12 7'-7" WALL BONUS ROOM SLP. CLG. 8'-0" CLG. CARPET 7'-3" WALL 8:12 ±3'-6" WALL 3'-8" ______

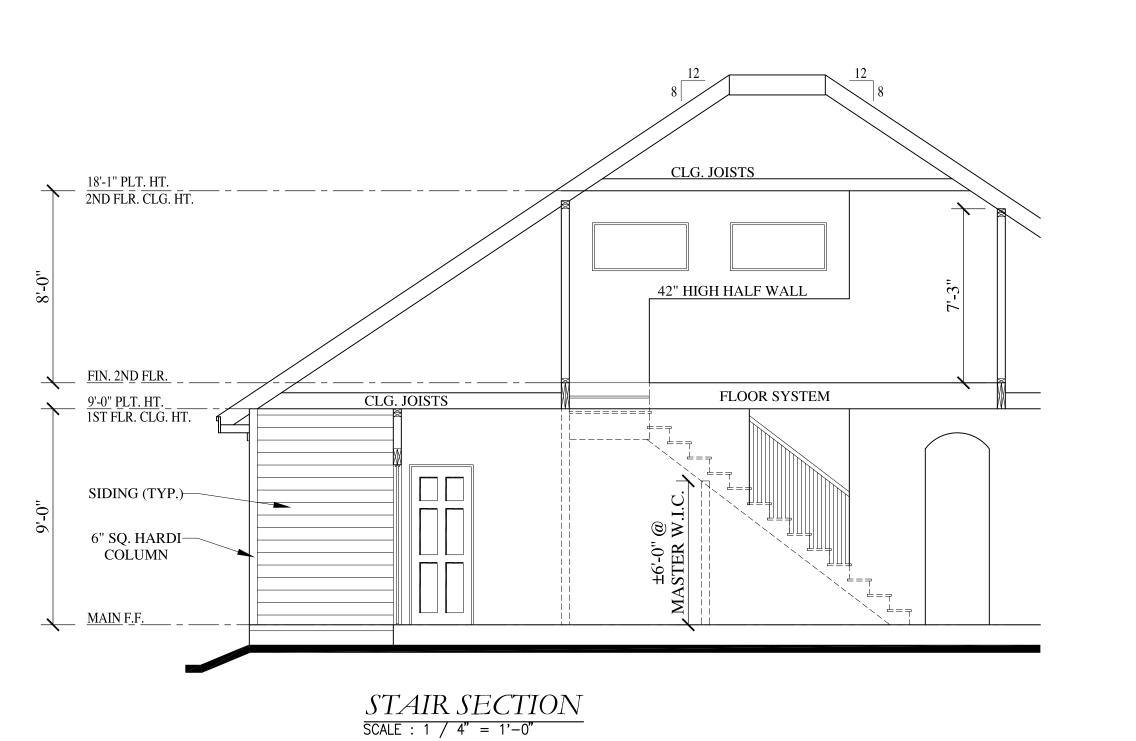

PRESTON GRANT DESIGN IS A PROFESSIONAL BUILDING DESIGN FIRM. WE ARE NOT QUALIFIED TO NOR LICENSED TO DESIGN STRUCTURAL FRAMING OR FOUNDATIONS. A LICENSED PROFESSIONAL ENGINEER SHOULD BE CONSULTED REGARDING THE FRAMING AND FOUNDATION DESIGN OF THE PROPOSED STRUCTURE. SHOULD AN ENGINEER'S SEAL (OR ARCHTITECT AND/OR CERTIFIED BUILDING DESIGNER SEAL) BE PRESENT ON THE DRAWINGS, THE "ENGINEER OF RECORD" SHALL BEAR THE RESPONSIBILITY FOR THE STRUCTURAL DESIGN. PRESTON GRANT DESIGN WILL NOT BE HELD RESPONSIBLE FOR THE STRUCTURAL DESIGN IN ANY WAY AND/OR ANY PROBLEMS WHICH MAY ARISE.



CAMPBELL GARRETT DISTINCTIVE HOMES YOUR LAND, OUR EXPERTISE



SCALE: 1/4" = 1'-0"

DRAWN BY: TSP

CHECKED BY: TSP

DATE: 10/17/17

SHEET NAME: BONUS ROOM FLOOR PLA

ELECTRICAL NOTES:

- BUILDER OR CONTRACTOR TO COMPLY WITH ALL THE CUREENT NEC CODES REQUIRED BY THE LOCAL JURISDICTION. REFER TO LOCAL JURISDICTIONAL CODE FOR VARIOUS PROVISIONS WHICH OVERRIDE OR SUPPLEMENT THE NEC.

- ALUMINUM WIRING SHALL NOT BE PERMITTED. - SMOKE DETECTORS REQUIRE A 110v CONNECTION TO HOUSE WITH BATTERY BACKUP. ALL SMOKE DETECTORS SHALL BE

WIRED IN SERIES (INTERCONNECTED). - CARBON MONOXIDE ALARMS INSTALLED PER IRC 2009 R315.1

- GROUND-FAULT CIRCUIT-INTERRUPTER (GFCI) PROTECTION SHALL BE PROVIDED FOR ALL 125-VOLT, 15 AND 20 AMP RECEPTACLE OUTLETS INSTALLED AS REQUIRED BOTH AT THE INTERIOR AND EXTERIOR OF RESIDENCE AND WITHIN 6'-0" OF THE OUTSIDE EDGE OF THE SINK IN LAUNDRY ROOMS, UTILITY ROOMS

AND AT WET BARS. - PROVIDE 110v OUTLET AND SWITCHED LIGHT IN ATTIC NEAR H.V.A.C. EQUIPMENT. LOCATE SWITCH NEAR (IF NOT OUTSIDE) ATTIC ACCESS.

- PROVIDE VENTILATION AT ALL BATHS AND UTILITY ROOMS. IF UTILITY ROOM HAS A MEANS OF NATURAL VENTILATION TO OUTSIDE, A VENT IS NOT REQUIRED.

- ALL EXHAUST VENTS SHALL EXIT THROUGH THE ROOF DECKING AT A MINIMUM DISTANCE OF 5'-0" FROM ANY PROPERTY LINE. DRYER VENTS MAY EXIT A NON-FIRE RATED EXTERIOR WALL. - LUMINARIES (LIGHTING FIXTURES) INSTALLED IN CLOTHES CLOSETS SHALL HAVE THE FOLLOWING MINIMUM CLEARANCES FROM THE DEFINED STORAGE AREA: PER NEC 410.16:

12 INCHES FOR TOTALLY ENCLOSED INCANDESCENT OR LED LUMINARIES

6 INCHES FOR RECESSED TOTALLY ENCLOSED INCANDESCENT FLUORESCENT OR LED LUMINARIES 6 INCHES FOR SURFACE MOUNTED OR ENCLOSED RECESSED

FLUORESCENT LUMINARIES - WHEN GARAGE DOOR OPENERS ARE INSTALLED, PROVIDE LOW VOLTAGE FOR SHUTOFF AND REVERSE SENSORS AT BOTH SIDES OF OVERHEAD DOOR.

- PROVIDE NETWORK JACKS AS PER OWNER - PROVIDE CIRCUITS FOR FUTURE POOL AND REAR YARD

- PROVIDE ELECTRIC DISCONNECT AT EACH A/C UNIT - PROVIDE LOW VOLTAGE CIRCUITS FOR BURGLAR ALARM SYSTEM

ELECTRICAL PLACEMENT NOTES:

- CONTRACTOR TO VERIFY INSTALLATION HTS. PER APPLICABLE CODE REQUIREMENTS FOR VARIOUS RECEPTACLES, OUTLETS, SWITCHES AND TO INSTALL ACCORDINGLY. - CONTRACTOR TO VERIFY ACCESSIBILITY STANDARDS FOR VARIOUS RECEPTACLES, OUTLETS, SWITCHES AND TO TO INSTALL ACCORDINGLY WHERE REQUIRED BY CODE/LAW OR PER OWNER'S REQUEST.

- CONTRACTOR TO VERIFY INSTALLATION LOCATIONS FOR VARIOUS RECEPTACLES, OUTLETS, SWITCHES AT BUILDER OR OWNER'S REQUEST. - FIELD VERIFY CONDITIONS AND ADJUST HTS. TO MEET FIELD CONDITIONS E.G.

MOTION SENSOR SWITCH

RECESSED CAN LIGHT

WP WATERPROOF RECESSED CAN LIGHT

HANGING PENDANT FIXTURE

HANGING LIGHT

□─[]WS WALL SCONCE

NT EXHAUST FAN

CEILING MOUNTED LIGHT FIXTURE

RECESSED EYEBALL SPOT LIGHT

WALL MOUNTED LIGHT FIXTURE

† HOSE BIB

CEILING FAN

FUTURE FAN

SIZE PER PLAN LOCATION

FLUORESCENT LIGHT

OUTLETS/RECEPTACLES AND SWITCHES TO BE INSTALLED INSIDE MILLWORK/CASEWORK.

ELECTRICAL LEGEND

110 VOLT RECEPTACLE

₩_{WP} WATERPROOF RECEPTACLE

©CLG. 110 VOLT IN CLG.

■ 110 VOLT IN CABINET

⊕QUAD QUAD 110 VOLT RECEPTACLE

220 VOLT RECEPTACLE

GAS OUTLET

TELEVISION ANTENNA


TELEPHONE OUTLET

SINGLE POLE SWITCH

THREE WAY SWITCH

FOUR WAY SWITCH

DIMMER SWITCH

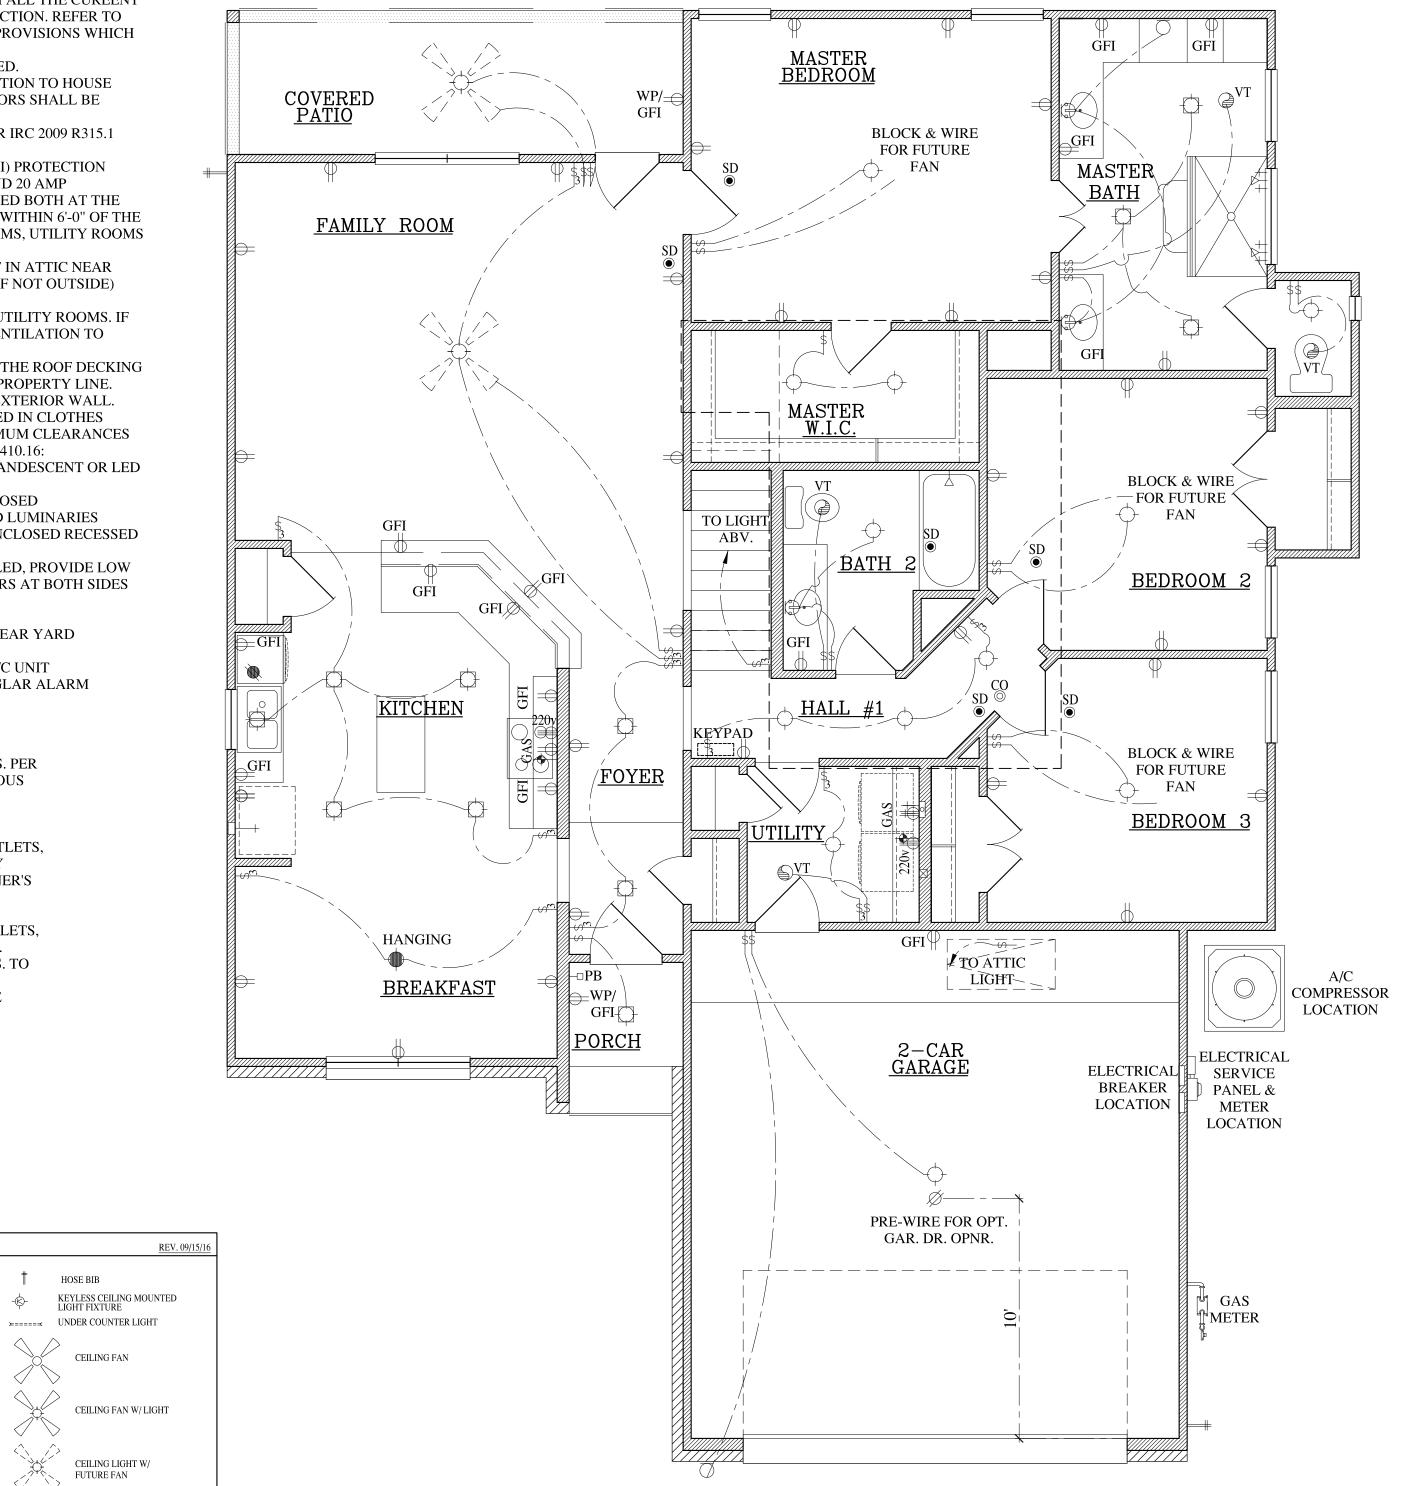

PRESTON GRANT DESIGN IS A PROFESSIONAL BUILDING DESIGN FIRM. WE ARE NOT QUALIFIED TO NOR LICENSED TO DESIGN STRUCTURAL FRAMING OR FOUNDATIONS. A LICENSED PROFESSIONAL ENGINEER SHOULD BE CONSULTED REGARDING THE FRAMING AND FOUNDATION DESIGN OF THE PROPOSED STRUCTURE. SHOULD AN ENGINEER'S SEAL (OR ARCHTITECT AND/OR CERTIFIED BUILDING DESIGNER SEAL) BE PRESENT ON THE DRAWINGS, THE "ENGINEER OF RECORD" SHALL BEAR THE RESPONSIBILITY FOR THE STRUCTURAL DESIGN. PRESTON GRANT DESIGN WILL NOT BE HELD RESPONSIBLE FOR THE STRUCTURAL DESIGN IN ANY WAY AND/OR ANY PROBLEMS WHICH MAY ARISE.

ELECTRICAL FIRST FLOOR PLANALARM AND SURROUND SOUND PLAN $\overline{\text{SCALE}} : 1 / 4" = 1'-0"$



DRAWN BY: CHECKED BY: 10/17/17 ELECTRICAL PLAN

ELECTRICAL NOTES:

- BUILDER OR CONTRACTOR TO COMPLY WITH ALL THE CUREENT NEC CODES REQUIRED BY THE LOCAL JURISDICTION. REFER TO LOCAL JURISDICTIONAL CODE FOR VARIOUS PROVISIONS WHICH OVERRIDE OR SUPPLEMENT THE NEC.

- ALUMINUM WIRING SHALL NOT BE PERMITTED. - SMOKE DETECTORS REQUIRE A 110v CONNECTION TO HOUSE WITH BATTERY BACKUP. ALL SMOKE DETECTORS SHALL BE WIRED IN SERIES (INTERCONNECTED).

- CARBON MONOXIDE ALARMS INSTALLED PER IRC 2009 R315.1

- GROUND-FAULT CIRCUIT-INTERRUPTER (GFCI) PROTECTION SHALL BE PROVIDED FOR ALL 125-VOLT, 15 AND 20 AMP RECEPTACLE OUTLETS INSTALLED AS REQUIRED BOTH AT THE INTERIOR AND EXTERIOR OF RESIDENCE AND WITHIN 6'-0" OF THE OUTSIDE EDGE OF THE SINK IN LAUNDRY ROOMS, UTILITY ROOMS AND AT WET BARS.

- PROVIDE 110v OUTLET AND SWITCHED LIGHT IN ATTIC NEAR H.V.A.C. EQUIPMENT. LOCATE SWITCH NEAR (IF NOT OUTSIDE) ATTIC ACCESS.

- PROVIDE VENTILATION AT ALL BATHS AND UTILITY ROOMS. IF UTILITY ROOM HAS A MEANS OF NATURAL VENTILATION TO OUTSIDE, A VENT IS NOT REQUIRED.

- ALL EXHAUST VENTS SHALL EXIT THROUGH THE ROOF DECKING AT A MINIMUM DISTANCE OF 5'-0" FROM ANY PROPERTY LINE. DRYER VENTS MAY EXIT A NON-FIRE RATED EXTERIOR WALL. - LUMINARIES (LIGHTING FIXTURES) INSTALLED IN CLOTHES CLOSETS SHALL HAVE THE FOLLOWING MINIMUM CLEARANCES FROM THE DEFINED STORAGE AREA: PER NEC 410.16:

12 INCHES FOR TOTALLY ENCLOSED INCANDESCENT OR LED LUMINARIES

6 INCHES FOR RECESSED TOTALLY ENCLOSED

INCANDESCENT FLUORESCENT OR LED LUMINARIES 6 INCHES FOR SURFACE MOUNTED OR ENCLOSED RECESSED FLUORESCENT LUMINARIES

- WHEN GARAGE DOOR OPENERS ARE INSTALLED, PROVIDE LOW VOLTAGE FOR SHUTOFF AND REVERSE SENSORS AT BOTH SIDES OF OVERHEAD DOOR.

- PROVIDE NETWORK JACKS AS PER OWNER - PROVIDE CIRCUITS FOR FUTURE POOL AND REAR YARD

- PROVIDE ELECTRIC DISCONNECT AT EACH A/C UNIT - PROVIDE LOW VOLTAGE CIRCUITS FOR BURGLAR ALARM SYSTEM

ELECTRICAL PLACEMENT NOTES:

- CONTRACTOR TO VERIFY INSTALLATION HTS. PER APPLICABLE CODE REQUIREMENTS FOR VARIOUS RECEPTACLES, OUTLETS, SWITCHES AND TO INSTALL ACCORDINGLY. - CONTRACTOR TO VERIFY ACCESSIBILITY STANDARDS FOR VARIOUS RECEPTACLES, OUTLETS, SWITCHES AND TO TO INSTALL ACCORDINGLY WHERE REQUIRED BY CODE/LAW OR PER OWNER'S REQUEST. - CONTRACTOR TO VERIFY INSTALLATION

LOCATIONS FOR VARIOUS RECEPTACLES, OUTLETS, SWITCHES AT BUILDER OR OWNER'S REQUEST. - FIELD VERIFY CONDITIONS AND ADJUST HTS. TO MEET FIELD CONDITIONS E.G. OUTLETS/RECEPTACLES AND SWITCHES TO BE

MOTION SENSOR SWITCH

WP WATERPROOF RECESSED CAN LIGHT

HANGING PENDANT FIXTURE

CEILING MOUNTED LIGHT FIXTURE

RECESSED EYEBALL SPOT LIGHT

WALL MOUNTED LIGHT FIXTURE

SD SMOKE DETECTOR

HANGING LIGHT

□⊢]WS WALL SCONCE

NT EXHAUST FAN

INSTALLED INSIDE MILLWORK/CASEWORK.

ELECTRICAL LEGEND

Ф 110 VOLT RECEPTACLE

■ 110 VOLT IN CABINET

⊕QUAD QUAD 110 VOLT RECEPTACLE 220 VOLT RECEPTACLE

GAS OUTLET

TELEVISION ANTENNA

TELEPHONE OUTLET


SINGLE POLE SWITCH

THREE WAY SWITCH

FOUR WAY SWITCH

DIMMER SWITCH

₩_{WP} WATERPROOF RECEPTACLE

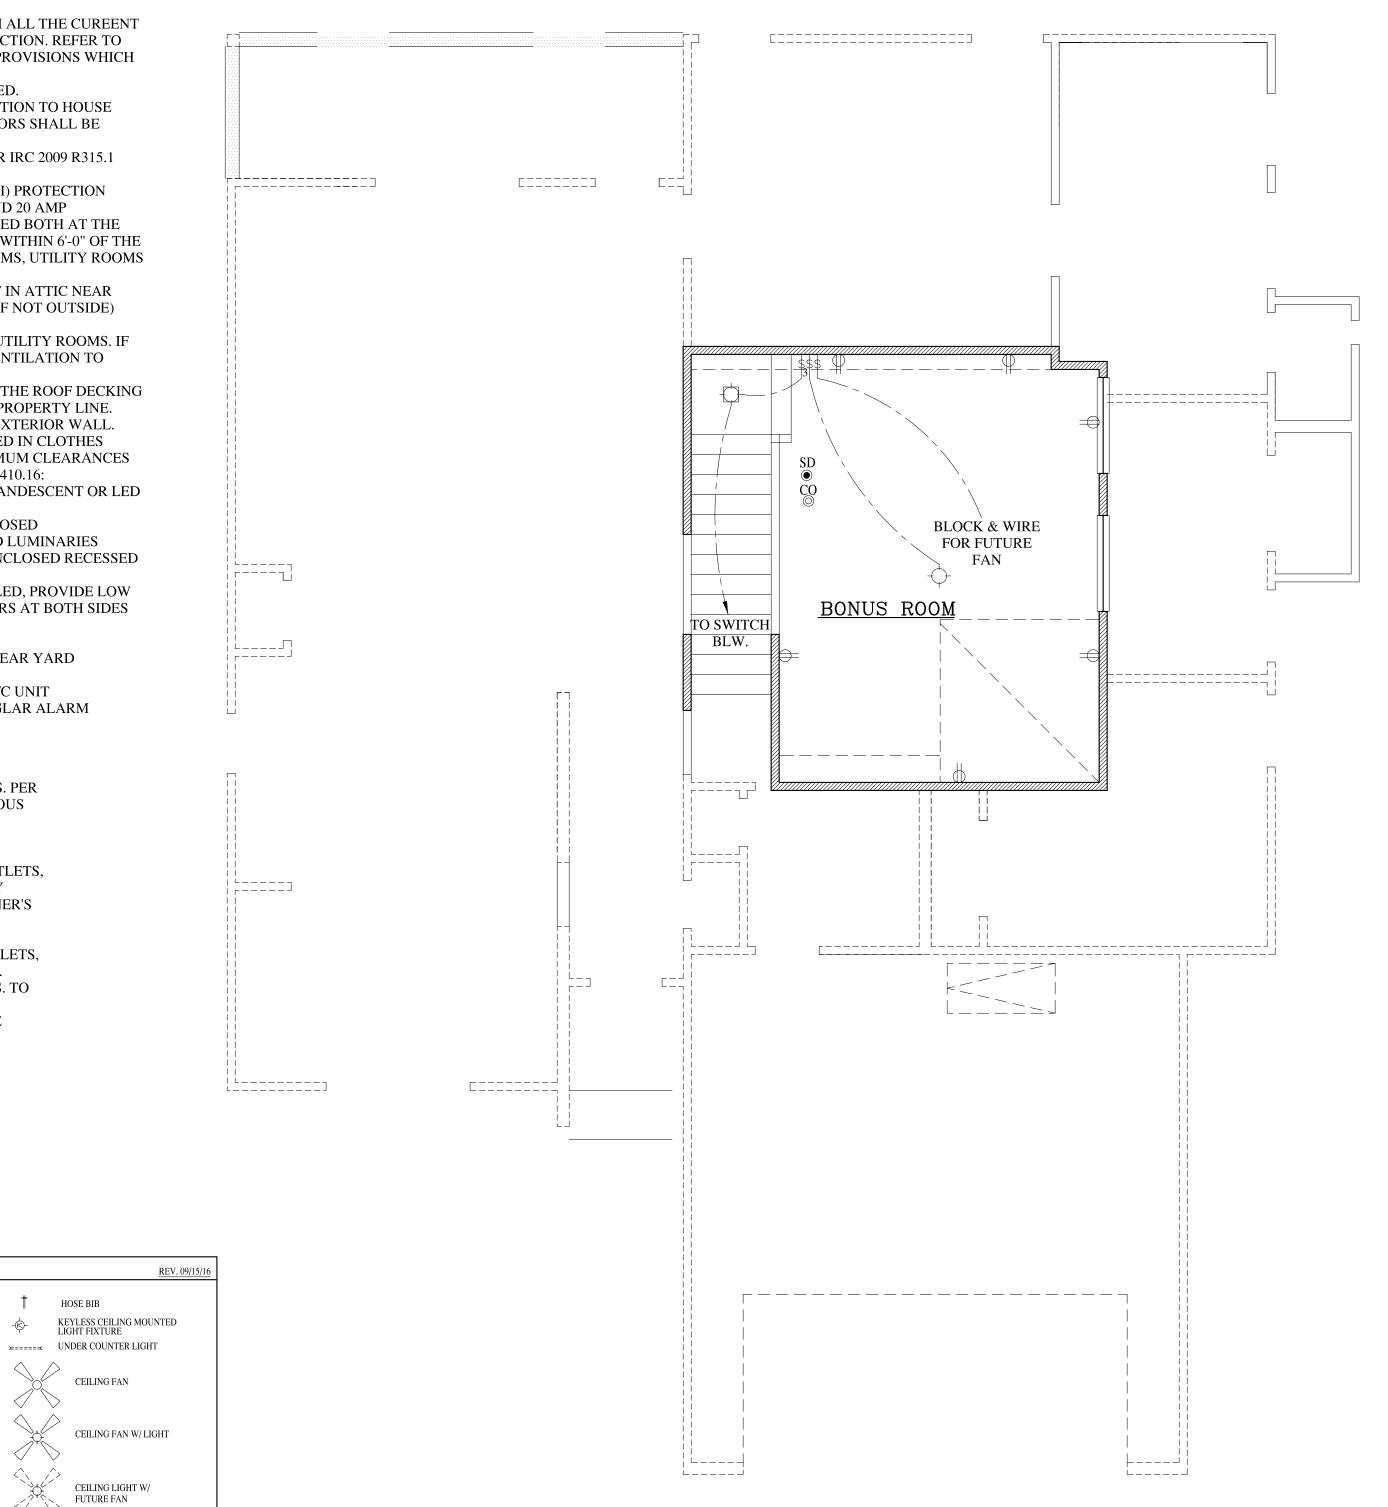

PRESTON GRANT DESIGN IS A PROFESSIONAL BUILDING DESIGN FIRM. WE ARE NOT QUALIFIED TO NOR LICENSED TO DESIGN STRUCTURAL FRAMING OR FOUNDATIONS. A LICENSED PROFESSIONAL ENGINEER SHOULD BE CONSULTED REGARDING THE FRAMING AND FOUNDATION DESIGN OF THE PROPOSED STRUCTURE. SHOULD AN ENGINEER'S SEAL (OR ARCHTITECT AND/OR CERTIFIED BUILDING DESIGNER SEAL) BE PRESENT ON THE DRAWINGS, THE "ENGINEER OF RECORD" SHALL BEAR THE RESPONSIBILITY FOR THE STRUCTURAL DESIGN. PRESTON GRANT DESIGN WILL NOT BE HELD RESPONSIBLE FOR THE STRUCTURAL DESIGN IN ANY WAY AND/OR ANY PROBLEMS WHICH MAY ARISE.

ELECTRICAL

SECOND FLOOR PLAN-ALARM AND SURROUND SOUND PLAN SCALE : 1 / 4" = 1'-0"

CEILING FAN


FUTURE FAN

SIZE PER PLAN LOCATION

FLUORESCENT LIGHT



1/4" = 1'-0" DRAWN BY: CHECKED BY: BONUS ROOM ELECTRICAL PL

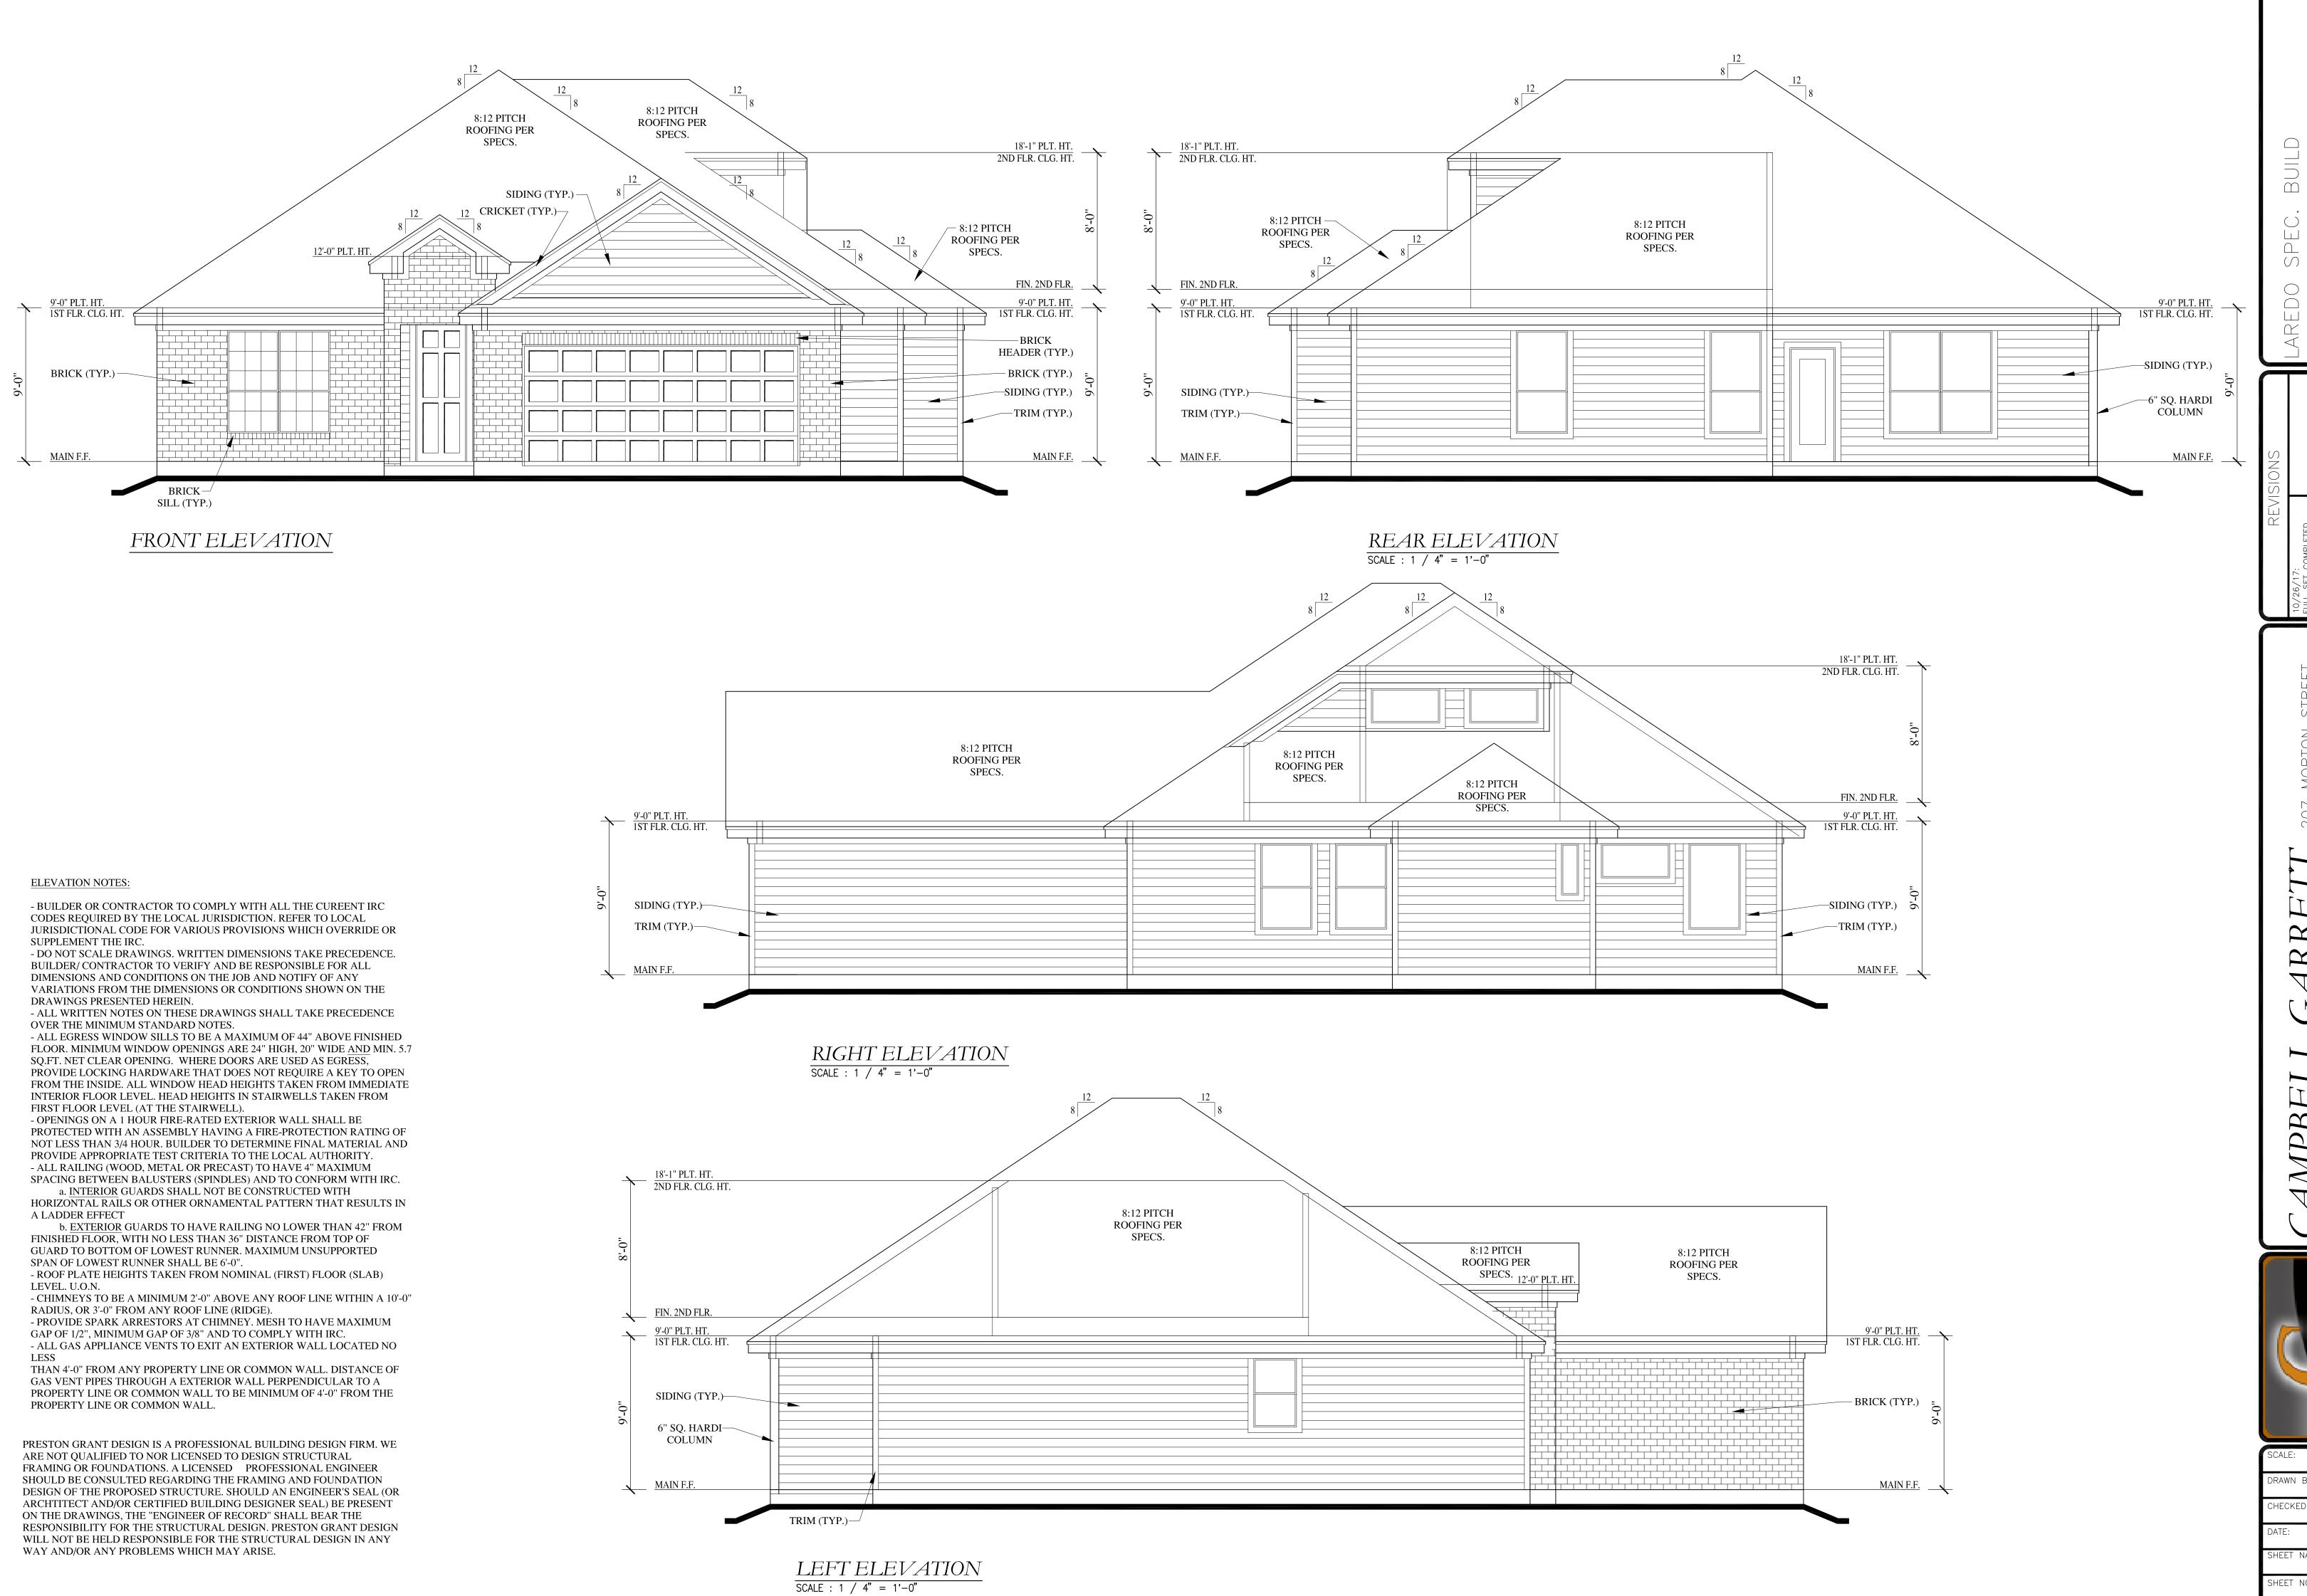

REDO SPEC. BUILD
19 ANNA STREET
17 9, BLOCK 3, SECTION N/EDVILLE, TEXAS 77461
AL LANDING

S RM.

207 MORTON STREET RICHMOND, TEXAS 77469 OFFICE (281) 344-8727

PBELL GARRETT 207
ISTINCTIVE HOMES
RICHM



SCALE:

1/4" = 1'-0"

DRAWN BY:

TSP

CHECKED BY:

TSP

DATE:


10/17/17

SHEET NAME:

EXTERIOR ELEVATIO

SHEET NO.

A - 5

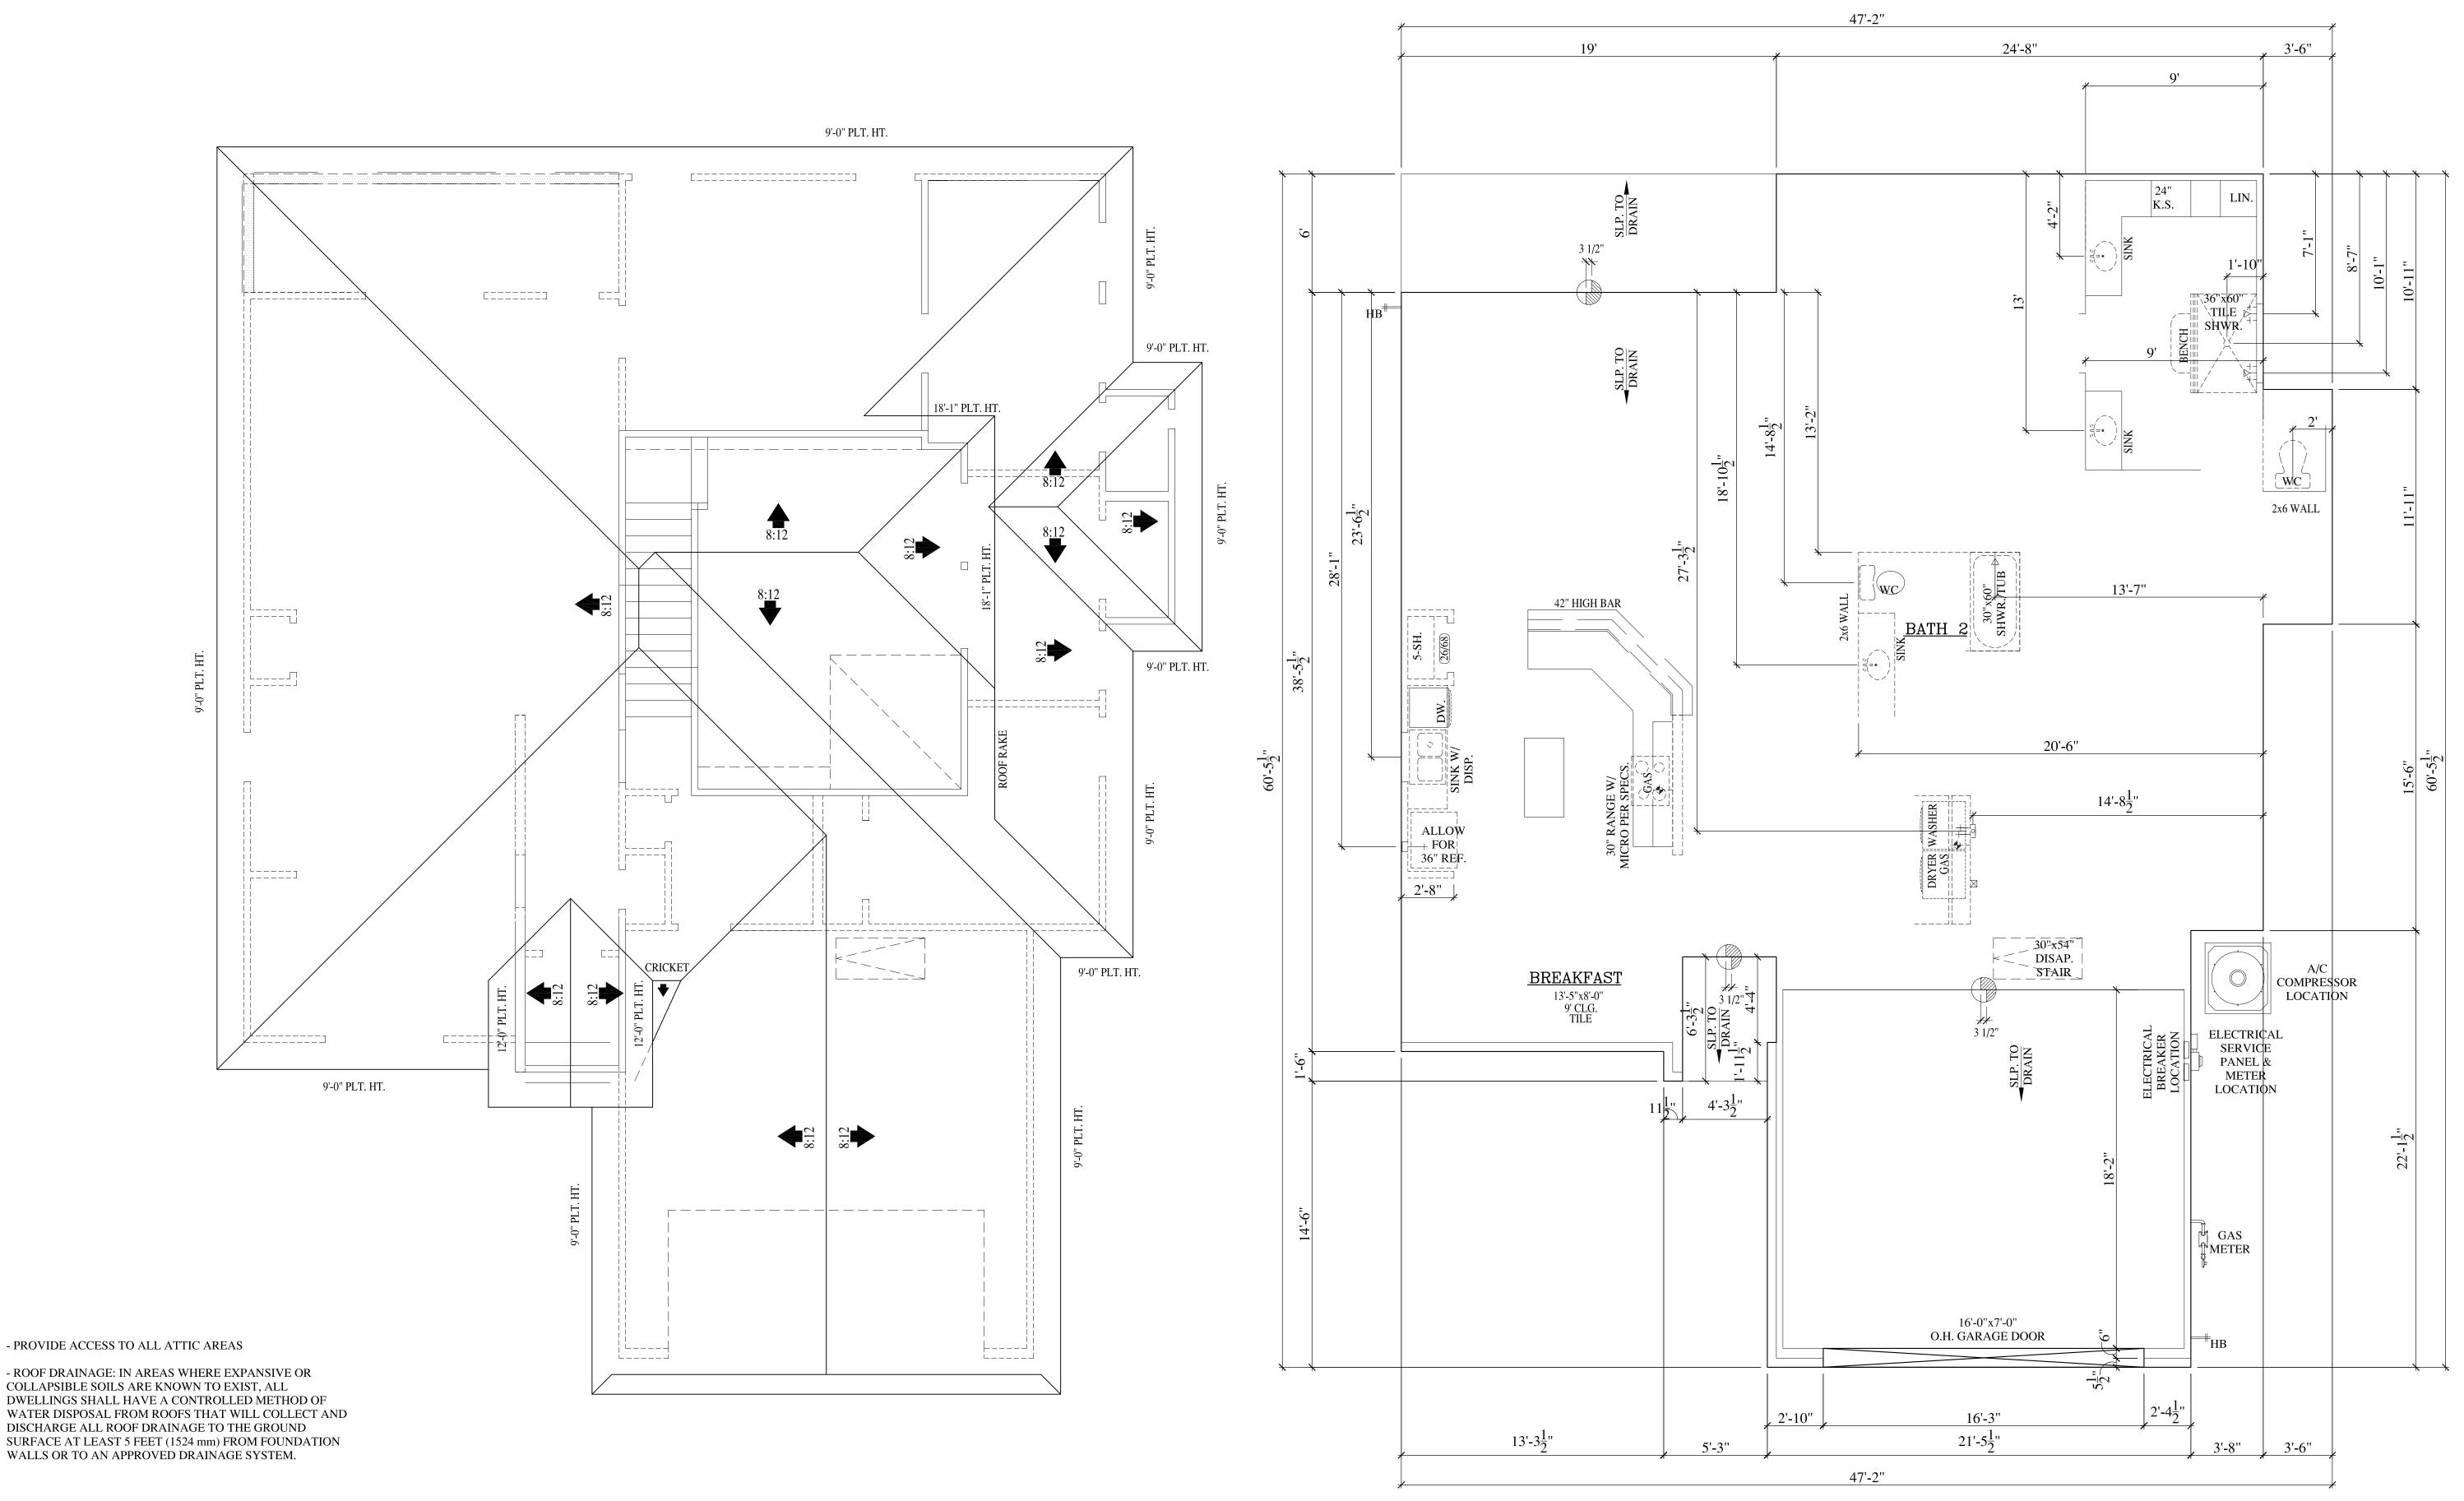

PRESTON GRANT DESIGN IS A PROFESSIONAL BUILDING DESIGN FIRM. WE ARE NOT QUALIFIED TO NOR LICENSED TO DESIGN STRUCTURAL FRAMING OR FOUNDATIONS. A LICENSED PROFESSIONAL ENGINEER SHOULD BE CONSULTED REGARDING THE FRAMING AND FOUNDATION DESIGN OF THE PROPOSED STRUCTURE. SHOULD AN ENGINEER'S SEAL (OR ARCHTITECT AND/OR CERTIFIED BUILDING DESIGNER SEAL) BE PRESENT ON THE DRAWINGS, THE "ENGINEER OF RECORD" SHALL BEAR THE RESPONSIBILITY FOR THE STRUCTURAL DESIGN. PRESTON GRANT DESIGN WILL NOT BE HELD RESPONSIBLE FOR THE STRUCTURAL DESIGN IN ANY WAY AND/OR ANY PROBLEMS WHICH MAY ARISE.

 $\frac{ROOOF\ PLAN}{SCALE: 1 / 4" = 1'-0"}$

FOUNDATION OUTLINE
SCALE: 1 / 4" = 1'-0"

LAREDO SPEC. BUILD
9119 ANNA STREET
LOT 9, BLOCK 3, SECTION N/A
NEEDVILLE, TEXAS 77461
TFALLANDING

10/26/17: FULL SET COMPLETED	12/06/17: ADDED BONUS RM.	01/03/18: REVISED EXT. ELEVS.	

MPBELL GARRETT 207 MORTON ST DISTINCTIVE HOMES OUR LAND, OUR EXPERTISE OFFICE (281) 344



SCALE:

1/4" = 1'-0"

DRAWN BY:

TSP

CHECKED BY:

TSP

DATE:

10/17/17


SHEET NAME:

ROOF/FOUNDATION OUTLINE

SHEET NO.

N 45°00'00" E 67.60'

5' U.E.

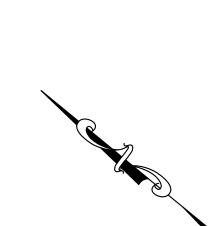

notes:

- OWNER, BUILDER AND SURVEYOR TO APPROVE LOCATION OF HOUSE ON LOT, AND TO VERIFY ALL EASEMENTS AND BUILDING LINES PRIOR TO START OF CONSTRUCTION. DESIGNER SHALL BE NOTIFIED OF ANY DEVIATION FROM THIS SITE PLAN.

- DRAINAGE DESIGN IS BEYOND THE SCOPE OF WORK OF THIS FIRM. GREAT CARE SHOULD BE TAKEN IN EVALUATING THE DRAINAGE REQUIREMENTS.

lot calculations:

iot carcarati		
LOT AREA	10,140	SQ. FT.
HOUSE PAD	2,310	SQ. FT.
DRIVE/WALK	511	SQ. FT.
TOTAL COV.	2,821	SQ. FT.
PERC. COV.		27.8%

lot 9
block 3
section N/A
subdivision
TEAL LANDING

site plan

SCALE : $1 / 8^{"} = 1'-0"$

CAMPBELL GARRETTI
DISTINCTIVE HOMES

1/4" = 1'-0"

12/06/17

SITE PLAN

CHECKED BY: TSP

SHEET NO.

SITE

MORTON STREET

MOND, TEXAS 77469

CE (281) 344-8727

CE (281) 344-8802

CARDVILLE, TEXAS

TEAL AND INC.