



FLOOR PLAN

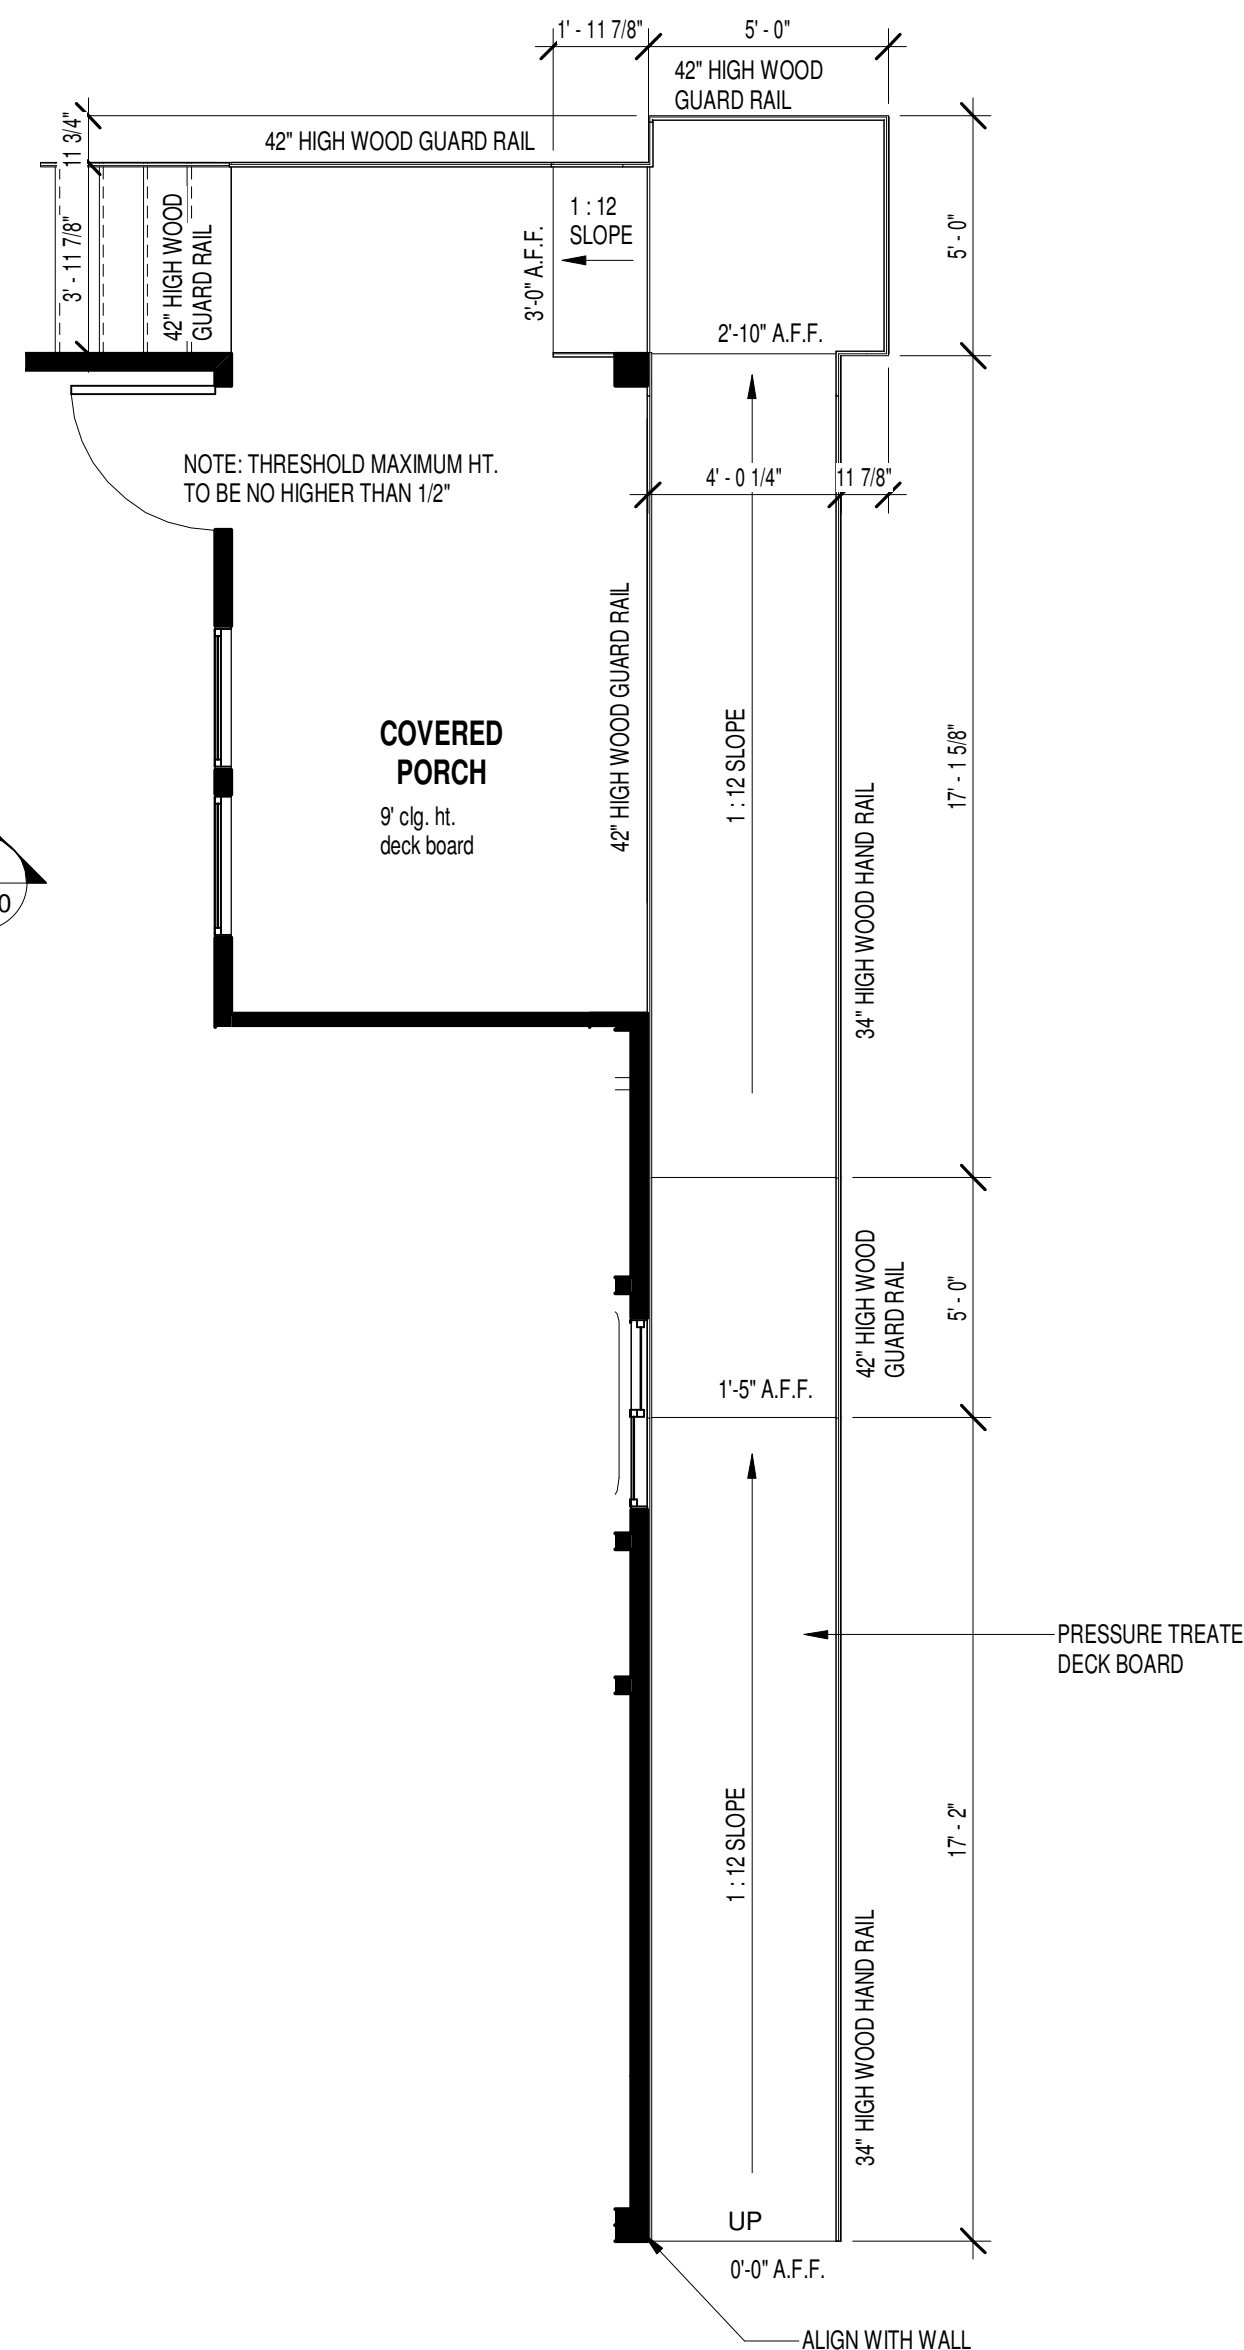


10 ADA RAMP - DETAILED
1/4" = 1'-0"

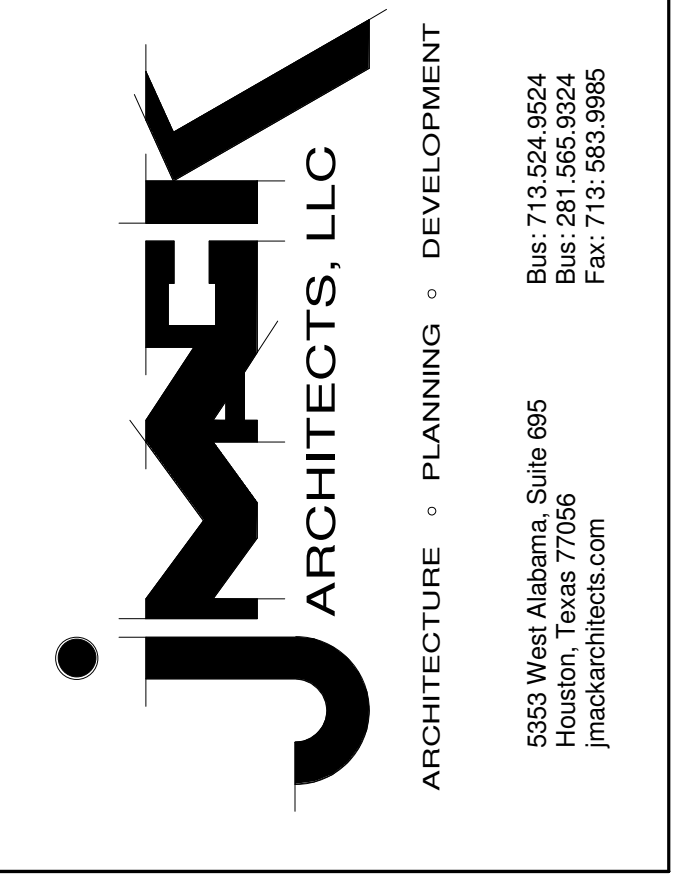

Copyright 2010 Jmax Architects, LLC. Drawings and specifications are instruments of service and shall remain property of Jmax Architects, LLC. They are not to be used on other projects or extensions to this project except by agreement in writing and with appropriate compensation to the architect. Contractor is responsible for confirming and correlating dimensions at the job site. Jmax Architects, LLC will not be responsible for construction means, techniques, sequences or procedures, or the safety precautions and programs in connection with this project.

SINGLE FAMILY RESIDENCE
3 BEDROOM MASTER PLAN
JMA-MP-1298

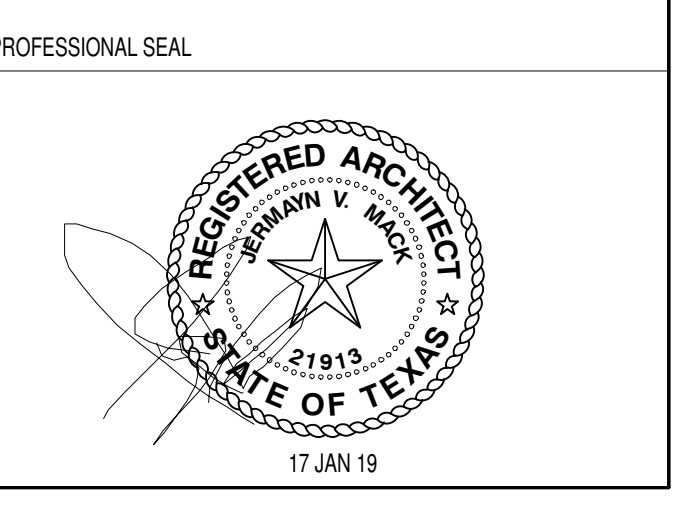

MARK	DATE	DESCRIPTION
1	17 JAN 19	ISSUED FOR PERMIT

PROJECT NO.	
CAD DRAWING FILE:	
DRAWN BY:	SEM
CHECKED BY:	JVM

SCALE	1/4" = 1'-0"
SHEET TITLE	FLOOR PLAN, INTERIOR ELEVATIONS & NOTES

1/28/2019 3:27:18 PM



FRONT ELEVATION



REAR ELEVATION

jmaek
ARCHITECTS, LLC
ARCHITECTURE • PLANNING • DEVELOPMENT
5553 West Alabama, Suite 695
Houston, Texas 77056
jmaekarchitects.com
Bus: 713.524.9524
Bus: 281.565.9324
Fax: 713.583.9965

Thompson

Copyright 2010 Jmaek Architects, LLC
Drawings and specifications are instruments of service and shall remain property of Jmaek Architects, LLC. They are not to be used on other projects or extensions to this project except by agreement in writing and with appropriate compensation to the architect. Contractor is responsible for confirming and correlating dimensions at the job site. Jmaek Architects, LLC will not be responsible for construction means, techniques, sequences or procedures, or the safety precautions and programs in connection with this project.

**SINGLE FAMILY
RESIDENCE**
3 BEDROOM MASTER PLAN
JMA-MP-1298

PROFESSIONAL SEAL

MARK	DATE	DESCRIPTION
1	17 JAN 19	ISSUED FOR PERMIT

PROJECT NO.:
CAD DRAWING FILE:
DRAWN BY: SEM
CHECKED BY: JVM

SCALE: As indicated
SHEET TITLE: EXTERIOR ELEVATIONS

A4.00
SHEET 5 OF 11 TOTAL SHEETS

1/28/2019 3:27:38 PM