

SECOND FLOOR PLAN SCALE 1/4"=1'-0"

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.) BUILDER OR CONTRACTOR MUST VERIFY ALL DIMENSIONS PRIOR TO PROCEEDING WITH CONSTRUCTION. 2.) CONTRACTOR MUST VERIFY COMPLIANCE WITH ALL

LOCAL BUILDING CODES IN THE AREA WHERE THE HOME IS TO BE CONSTRUCTED.

3.) PLANS INDICATE LOCATION ONLY; ENGINEERING ASPECTS SHOULD INCORPORATE ACTUAL SITE CONDITIONS.

CAUTION MUST BE EXERCISED IN MAKING ANY CHANGES IN THIS PLAN. ONLY A QUALIFIED ENGINEER SHOULD ATTEMPT MODIFICATIONS, AS EVEN MINOR CHANGES IN ONE AREA OF THE HOUSE COULD LEAD TO MAJOR PROBLEMS IN ANOTHER AREA.

GENERAL NOTES (WHERE APPLICABLE)

* All exterior walls to be 2x4, 2x6, 2x8, or other as noted, @16" O.C., w/ 1/2" plywood sheathing, w/outer vapor barrier, unless noted otherwise. (Blocked @ Midspan) & as per code. Interior walls, 2x4 @ 16" O.C., unless noted otherwise. (Blocked

Midspan), all plumbing walls to be 2x6. All metal fireplaces to be top of the line- double lined (min)- code

units as per mfg. (Wgas logs optional.)

* All fireplaces to have tile, marble, or brick hearths \$ facing, as

per builder & as selected by owner.

* All shelving to be 3/4" Wedging, supported at edges & or, 4' O.C.

(Bookshelves to have hidden "Ribbon" lighting- optional)

* All closets to have at least one single rod & two shelves, unless noted otherwise, W/med to top hardware. Most to have 2 rods, 2 or 3

shelves, or more as per builder. * All exterior doors, garage, and attic doors to be weather stripped.

* All baths, utility, water heater, \$ pony walls to have full insulation. (Garage common walls and ceiling, when living space above.) * Kitchen counter tops to be formica, corian or stone w/turned edges as selected. Kitchen cabinets to have compound hinges, edged

counter lighting, all sinks w/disposers, down-draft cooktop (w/6 optional burners & w/grill as selected). Refrigerator to have water supply w/cut-off. All plugs to be GFI. (As required by code.) Stairs to have (optional step lights as selected), continous

shelves, solid panels, "Blum" type guides, special hardware, under

handrails w/l l/2" grip \$ 36" high, T" nosing w/4" clear spacing. Guardrails to be 42'" high.

* All bath vanities to be marble or stone (w/optional porcelain

bowls). Verify heights from 32" to 36". All drawers and cabinet shelves to be lined. (Verify with builder.)

* Linens to have hamper and drawer caulked, lined, waterproofed \$
vented for moisture. (Medicine cabinets as selected)

Ridges and valleys are to be braced down to proper support, on

through to foundation support. Ridges and valleys over 12', to be 2x12, unless noted otherwise. Ends to be cut to frame out w/rafters. (See builder/engineer.)

* Garage ceiling, under stairs, water heaters \$ chimney drywall to be 5/8" X-šheetrock. All ceiling corners at main rooms to have molding. (verify mldg. pkg.) Closet, garage, dormer windows to have optional sheers.

(some with special lighting.) Windows to be wood or metal, double pane insulated- shown in nominal sizes, w/extra caulking & head flashing where required. (See builder.)

* Windows sills & casing to be wood, stone , marble, or drywall. * All main drywall corners to have Bull-Nose. (optional) * Connect gutters and downspouts to an underground drainage piping

system. (Verify w/owner and builder/engineer.) * All brick arches \$ designs w/reinforcing, \$ w/type "S" mortar. * Brick columns to have treated wood post centers, or steel as shown. Wood columns to be set on anchored metal plinth \$ wall ties

* All brick support over roofs to be designed by a Registered Texas Structural Engineer, as well as other structural members and assemblies. All yard hydrants to be freeze proofed.

Provide high "R" ratings for all attic floors \$ walls. (optional) All gas appliances to have code vents. * All water piping, condensate drains, water heaters or storage in the

attic to be freeze proofed and insulated. Attic water heaters to have metal pans w/drains. A/C ducts should be routed around most usable attic space.

Dryer vents to be outside. * Ceiling joists to be sized for 3/4" plywood flooring in attic as directed by builder. Stud wall support below must be sized for

proper support.

Radian't barriers are optional. * Uniform cornice vents @ entire perimeter, screened w/insulation

baffled for air flow. Thermostatically controlled roof vents as per mfq's recommendations, to be low rise \$ color coded to roof materials.

* Framing members shown are suggested minimals. Engineering design takes priority over these schematic drawings. (See builder.)


* All long span ceilings to be stripped 2" O.C., w/lx4 leveling. (optional) * All rafter spans to be braced 12' O.C. (maximum). (see eng.) * All ridges and beam connections to have metal clips & nailing. (see eng.)

AREAS		
FIRST FLOOR LIVING (AC)	1704	SQ. FT.
SECOND FLOOR LIVING (AC)	1881	SQ. FT.
TOTAL LIVING (AC)	3585	SQ. FT.
GARAGE I	280	SQ. FT.
GARAGE 2	313	SQ. FT.
PATIO	166	SQ. FT.
PORCH	68	SQ. FT.
REAR BALCONY I	76	SQ. FT.
FRONT BALCONY I	43	SQ. FT.
FRONT BALCONY 2	43	SQ. FT.
TOTAL COVERAGE	4574	SQ. FT.
REAR BALCONY 2	29	SQ. FT.

GENERAL NOTES:

* FIRST FLOOR PLATE TO BE 10'-0" AFF

- UNLESS NOTED OTHERWISE * SECOND FLOOR PLATE TO BE 9'-0" AFF
- UNLESS NOTED OTHERWISE * ALL DIMENSIONS ARE TO FACE OF STUD
- UNLESS NOTED OTHERWISE * ALL 4'S @ 45° UNLESS NOTED OTHERWISE
- * ALL PLATE LINES AS NOTED ON ELEVATIONS * ALL EXTERIOR WALLS TO BE 2X6 UNLESS
- UNLESS NOTED OTHERWISE * ALL FINISHED CEILINGS @ FIRST FLOOR TO
- BE IO'-O" AFF UNLESS NOTED
- * ALL FINISHED CEILINGS @ SECOND FLOOR TO BE 9'-O" AFF UNLESS NOTED * ALL INTERIOR WALL, FLOOR & CEILING
- FINISHES AS PER BUILDER
- * ALL WINDOW HDRS @ FIRST FLOOR @ 8'-0" AFF UNLESS NOTED OTHERWISE
- * ALL WINDOW HDRS @ SECOND FLOOR @ 7'-4" AFF UNLESS NOTED OTHERWISE

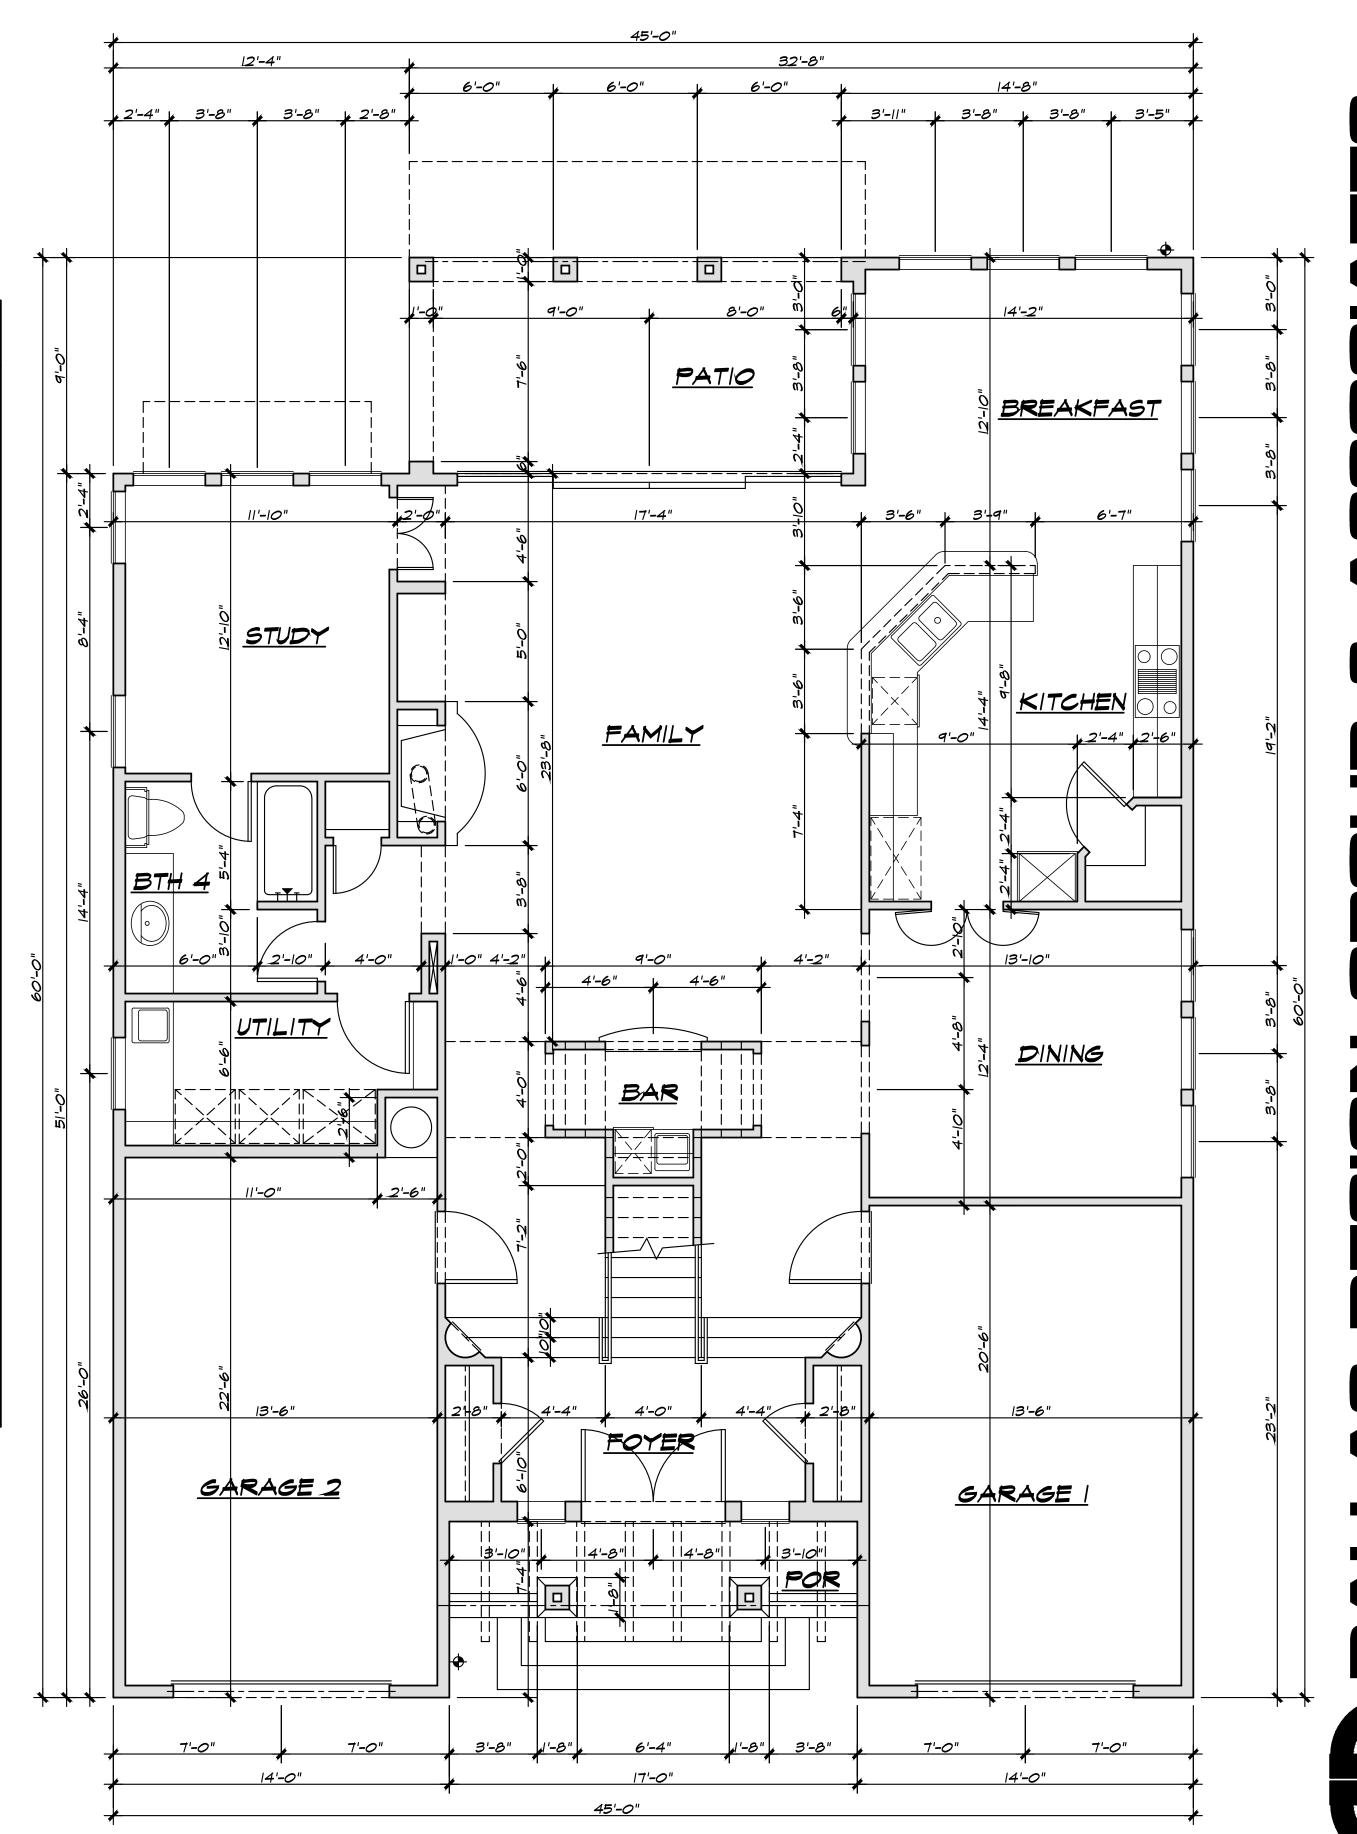

FIRST FLOOR PLAN SCALE 1/4"=1'-0"

4-25-2019 PLAN NO. T. MOORE MISSION VIELO SHEET NO.



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