

# PROJECT INFORMATION:

Square Footage: FAT FARMH	OUSE
LIVING AREA: FIRST FLOOR LIVING: SECOND FLOOR LIVING: THIRD FLOOR LIVING:	753 SF 783 SF N/A
TOTAL LIVING AREA:	1536 SF
FRONT PORCH:	84 SF
BALCONY (2ND LEVEL):	N/A
MECHANICAL ROOM:	N/A
TOTAL FRAMED AREA:	1620 SF
TOTAL FRANCED AREA.	1020 36
ROOF TERRACE:	N/A
FOUNDATION:	837 SF


Code Compliance: 2012 INTERNATIONAL RESIDENTIAL CODE W/ HOUSTON AMMENDMENTS 2012 INTERNATIONAL PLUMBING CODE W/ HOUSTON AMMENDMENTS PLUMBING 2012 INTERNATIONAL MECHANICAL CODE W/ HOUSTON AMMENDMENTS 2017 NATIONAL ELECTRICAL CODE W/ DALLAS AMMENDMENTS MECHANICAL

ELECTRICAL ENERGY 2015 INTERNATIONAL ENERGY CONSERVATION CODE

OCCUPANCY CONSTRUCTION TYPE

R-3 SINGLE FAMILY RESIDENTIAL VBII (NOT SPRINKLED)

## VICINITY MAP

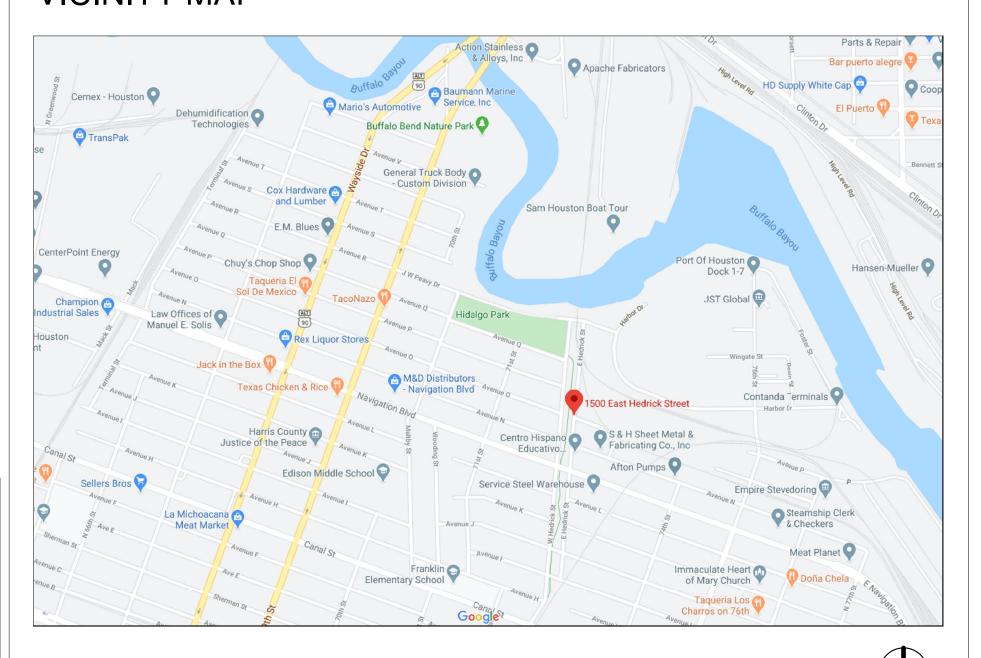

# SHEET LIST

Sheet List		
Sheet Number	Sheet Name	
A1	Cover	
A2	Plat	
A3	Site Plan	
A4	COH Traffic Details	
A5	Floor Plans	
A6	Elevations	
A7	3D Views & Int. Elevations	
A8	Section & Details	
A9	Fiber Cement Details	
E1	Electrical Layouts	
S1	Foundation Plan	
S2	Framing Plans	
S3	Roof Framing Plan	
S4	General Notes and Details	




Avenue 'O' - Fat Farmhouse Vecino Homes


1516 & 1520 E Hedrick Street Houston, TX 77011

2020.1008 Project number 08/03/2020 Construction Doc.



Cover

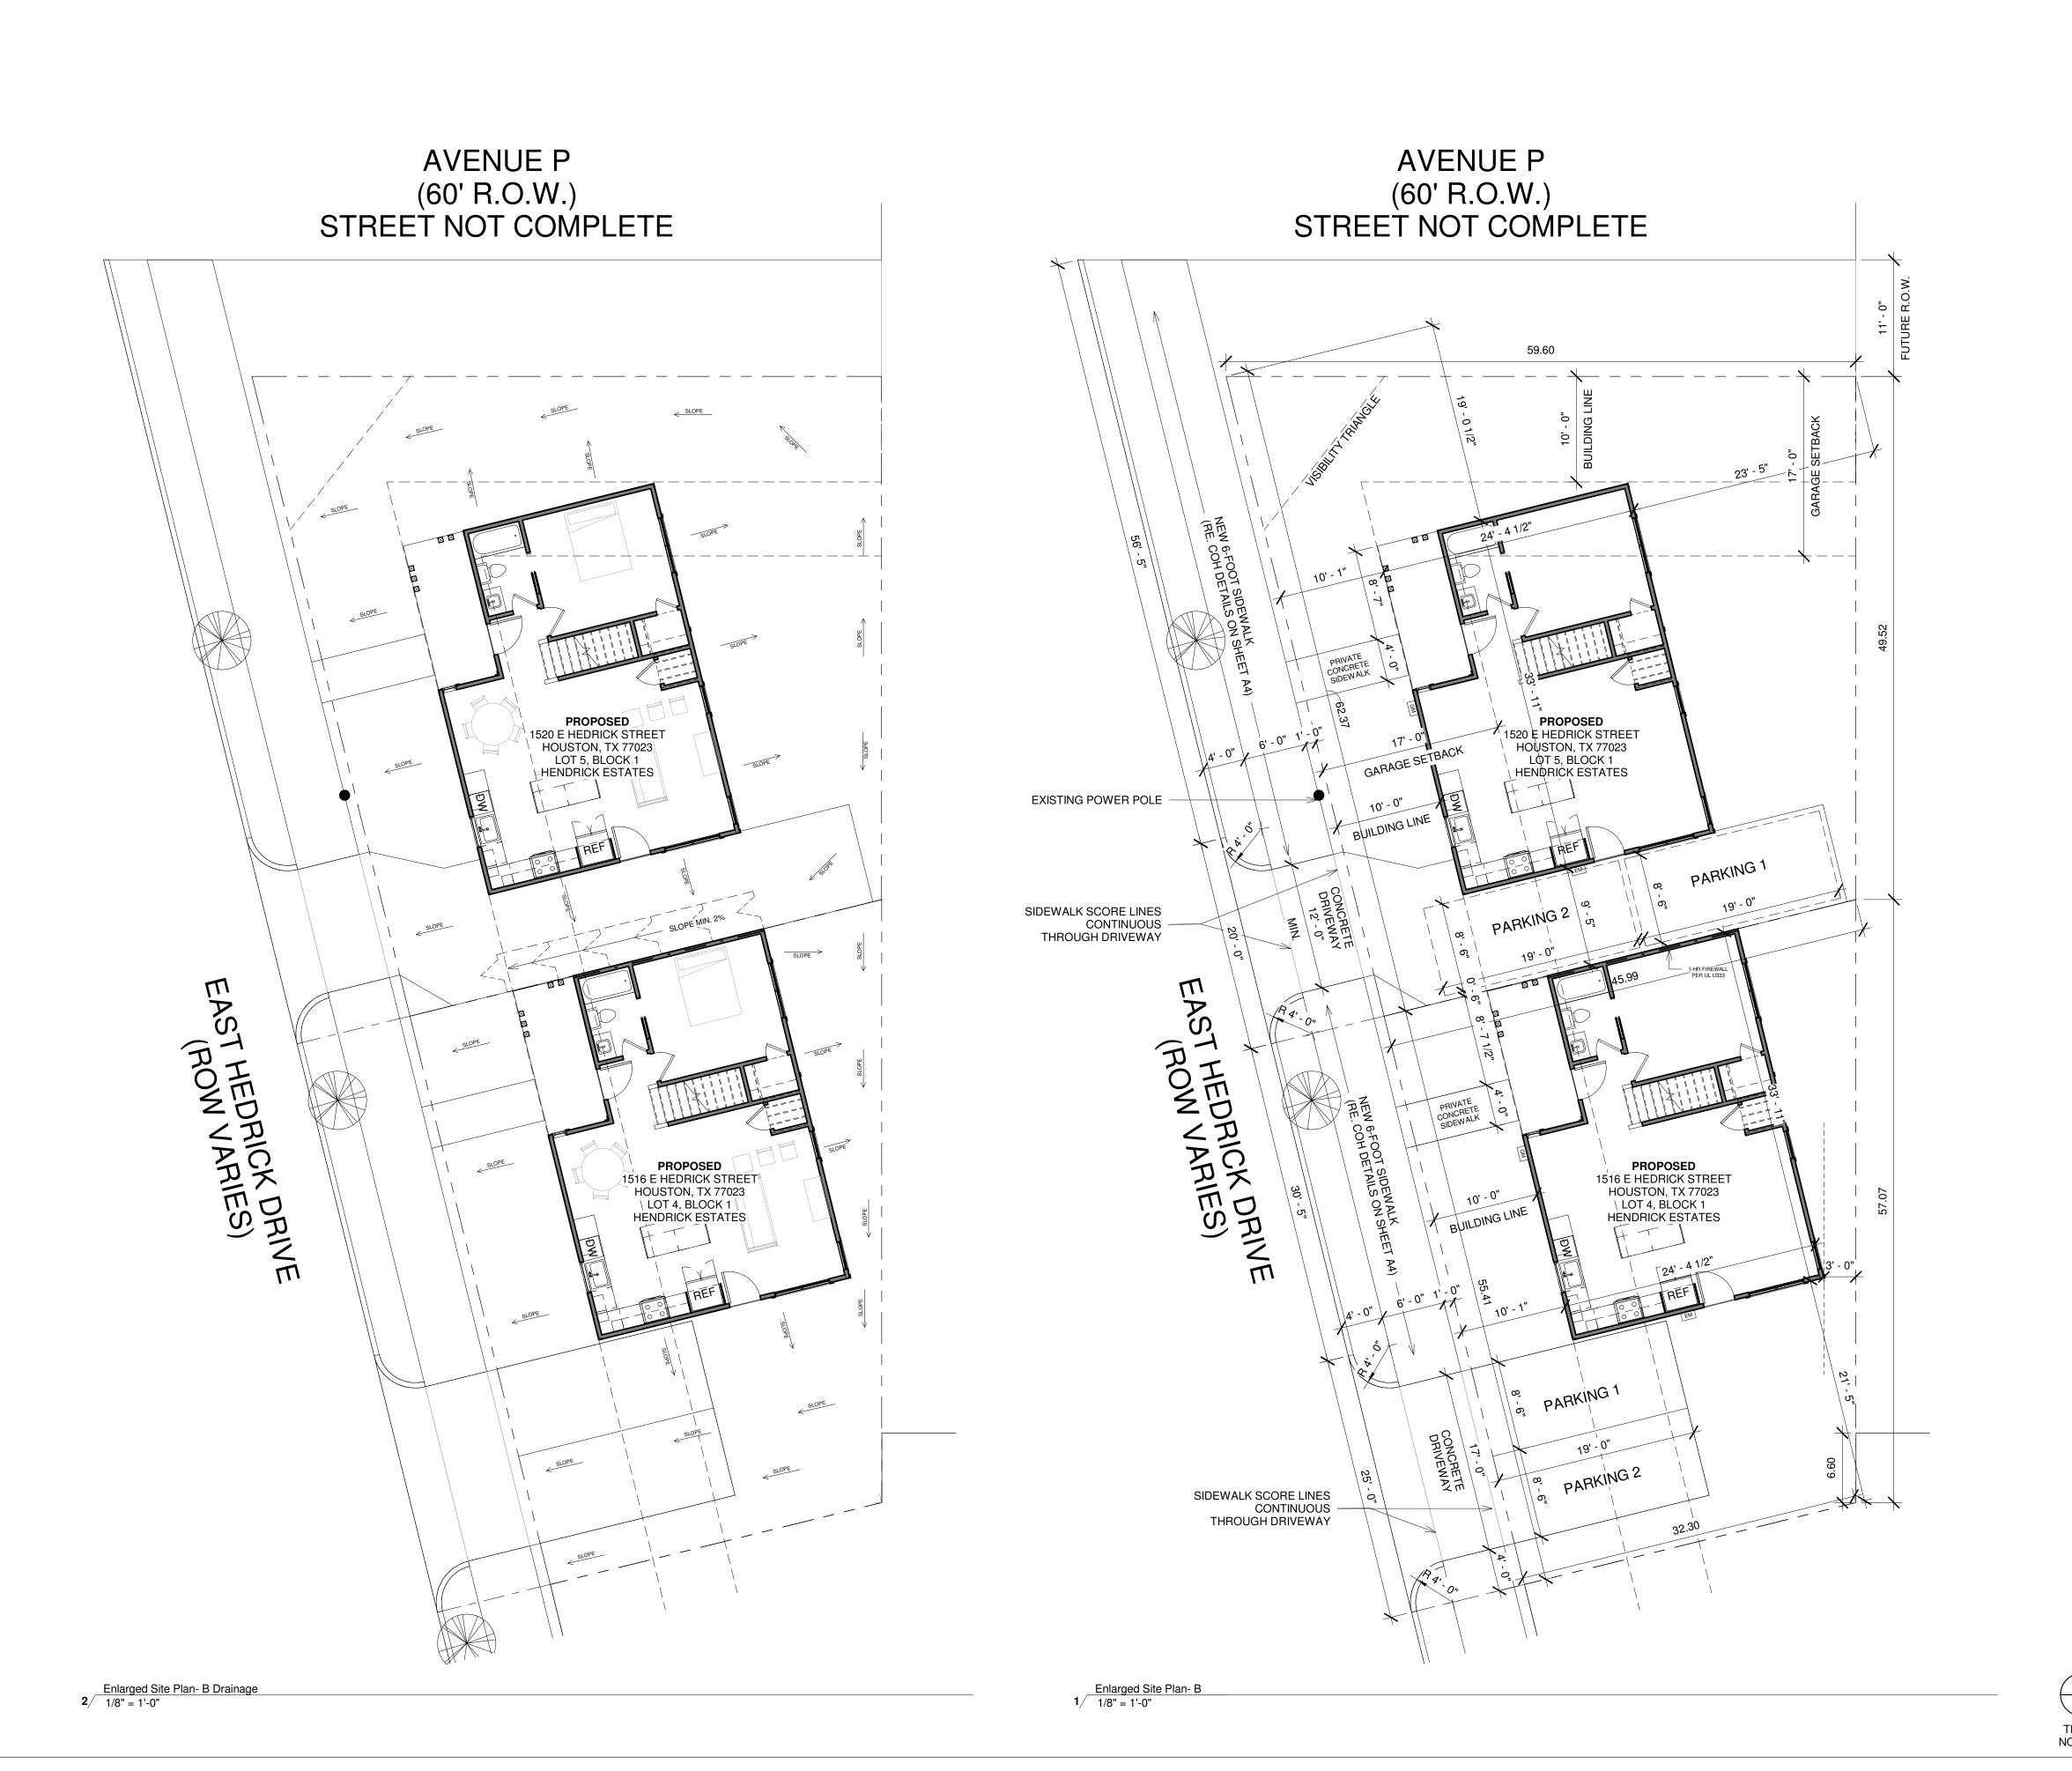

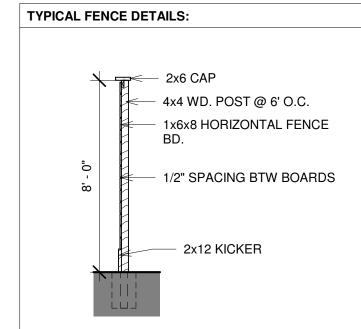

FINISHED FLOOR ELEVATION MUST BE A MINIMUM 12" ABOVE THE NEAREST SANITARY SEWER MANHOLE RIM.


## **GRADING NOTES**

1. ALL NEW BUILDINGS WITHIN THIS JURISDICTION SHALL HAVE THE FINISHED FLOOR OF THE BUILDING NOT LESS THAN 12-INCHES ABOVE THE NEAREST SANITARY SEWER MANHOLE RIM, OR, WHERE NO SEWER IS AVAILABLE, THE FINISHED FLOOR SHALL NOT BE LESS THAN 4-INCHES ABOVE THE CROWN OF THE STREET.

2. LOTS SHALL BE GRADED TO DRAIN SURFACE WATER AWAY FROM FOUNDATION WALLS. THE GRADE SHALL FALL A MINIMUM 6-INCHES WITHIN THE FIRST

EXCEPTION: WHERE LOT LINES, SLOPES, WALLS, OR OTHER PHYSICAL BARRIERS PROHIBIT 6-INCHES OF FALL WITHIN 10-FEET, DRAINS OR SWALES SHALL BE CONSTRUCTED TO ENSURE DRAINAGE AWAY FROM THE STRUCTURE. IMPERVIOUS COVERAGES WITHIN 10-FEET OF THE BUILDING FOUNDATION SHALL BE SLOPED A MIN. 2% AWAY FROM THE BUILDING.

3. ON GRADED SITES, THE TOP OF ANY EXTERIOR FOUNDATION SHALL EXTEND ABOVE THE ELEVATION OF THE STREET GUTTER AT POINT OF DISCHARGE OR THE INLET OF AN APPROVED DRAINAGE DEVICE A MIN. 12-INCHES PLUS 2%.

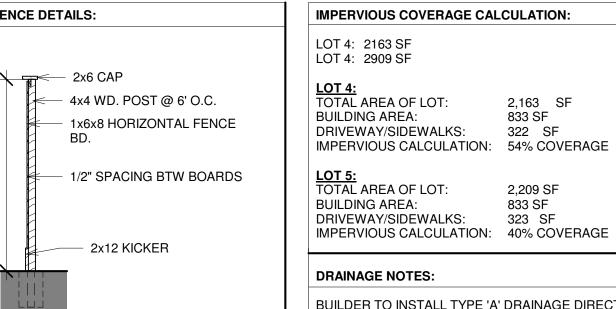

LEGEND:

BUILDER TO INSTALL TYPE 'A' DRAINAGE DIRECTING RUNOFF TO THE CITY RIGHT-OF-WAY AND MAY NOT OVERFLOW TO AN ADJACENT PROPERTY.

# EM **ELECTRIC METER** GM **GAS METER** PROPERTY LINE SETBACKS/BUILDING LINE \_ \_ \_ \_ \_ \_ \_ \_ \_ **BUILDING OVERHANG**

OAK TREE (2" CALIPER)



Hendricks Estates

Vecino Homes

1516 & 1520 E Hedrick Street Houston, TX 77011

TRAFFIC NOTES

CITY OF HOUSTON SIDEWALK AND DRIVEWAY DETAILS ARE LOCATED ON SHEET A4.


**PLAT NOTES** 


TRUE PROJECT NORTH NORTH


HENDRICK ETSTAES - RECORDED IN THE OFFICE OF COUNTY CLERK ON 8/12/20, HARRIS COUNTY, TX FILM CODE: RP-2020-369128

2019.08 Project number 08/03/20 CONSTRUCTION DOCUMENTS

> **A3** Floor Plans

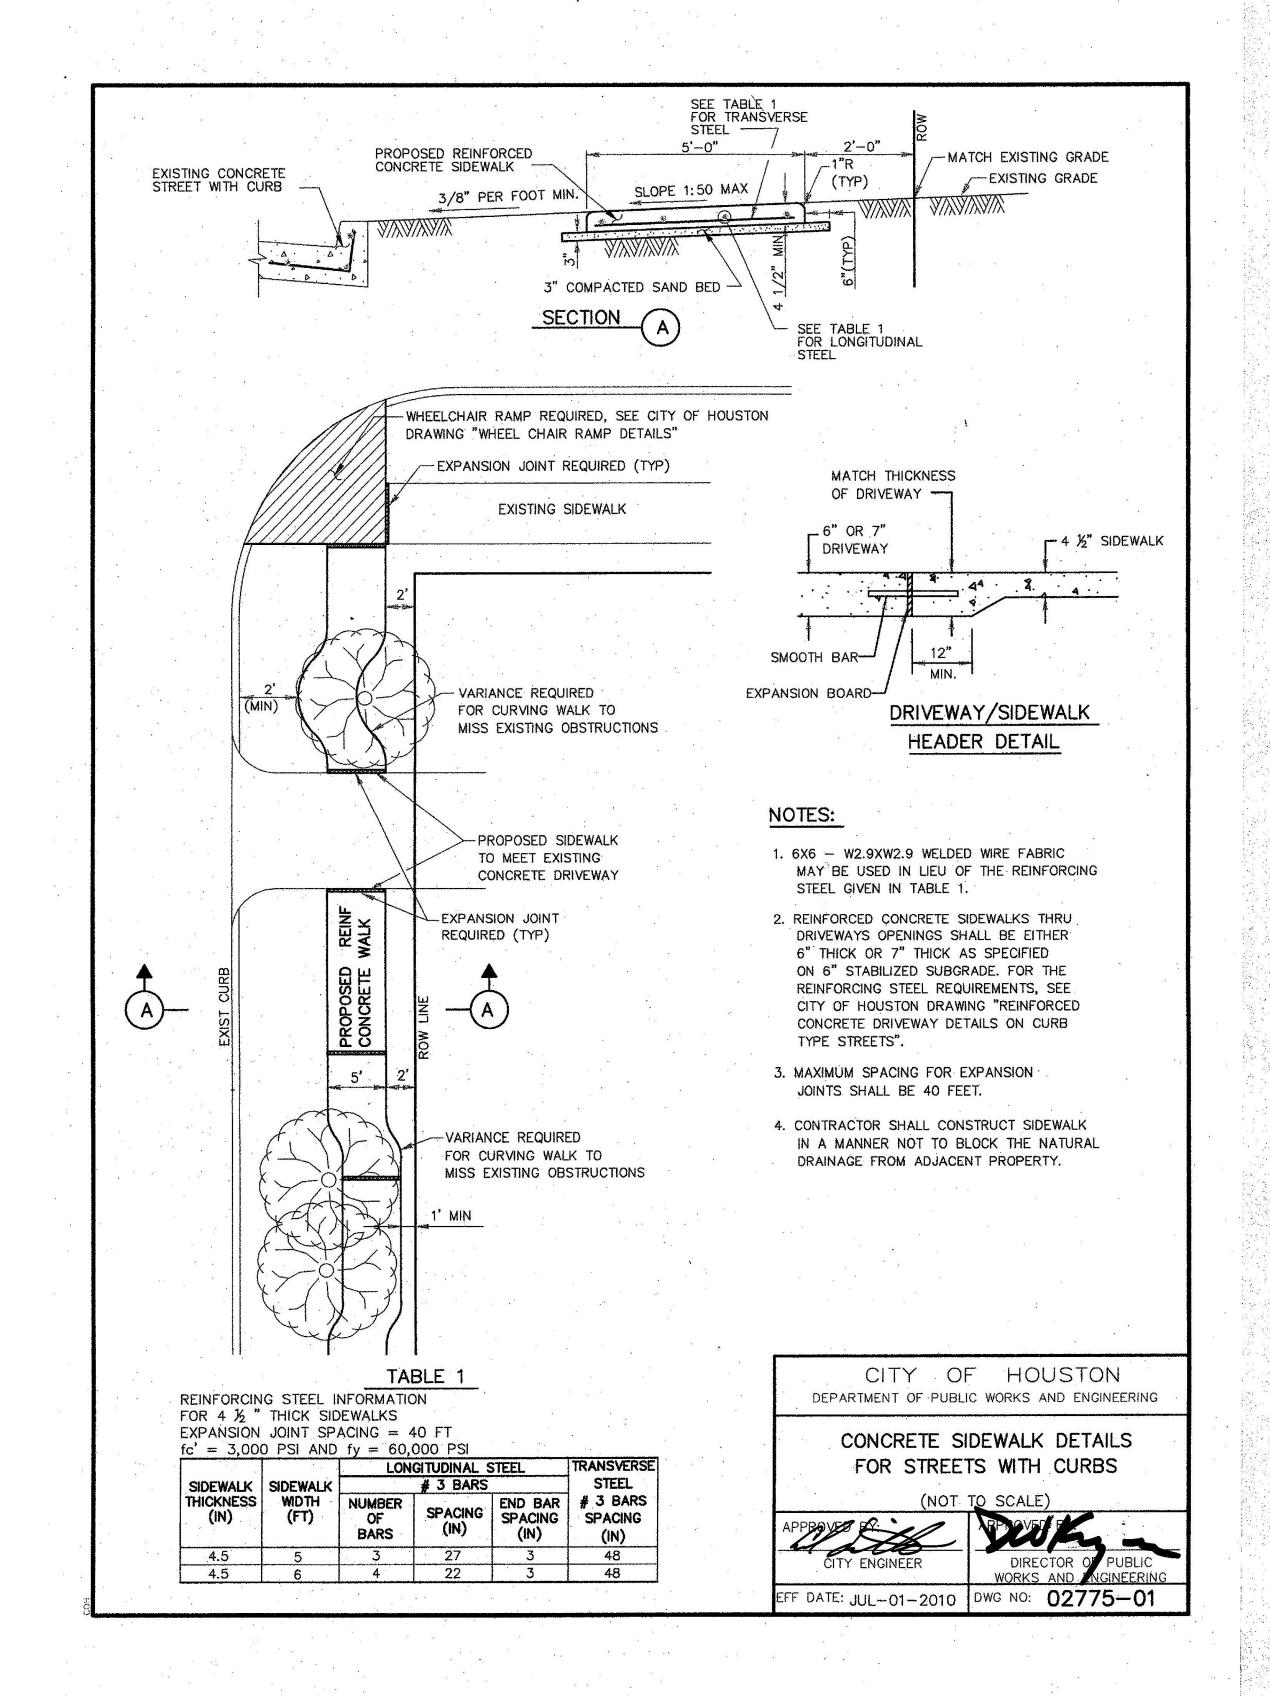

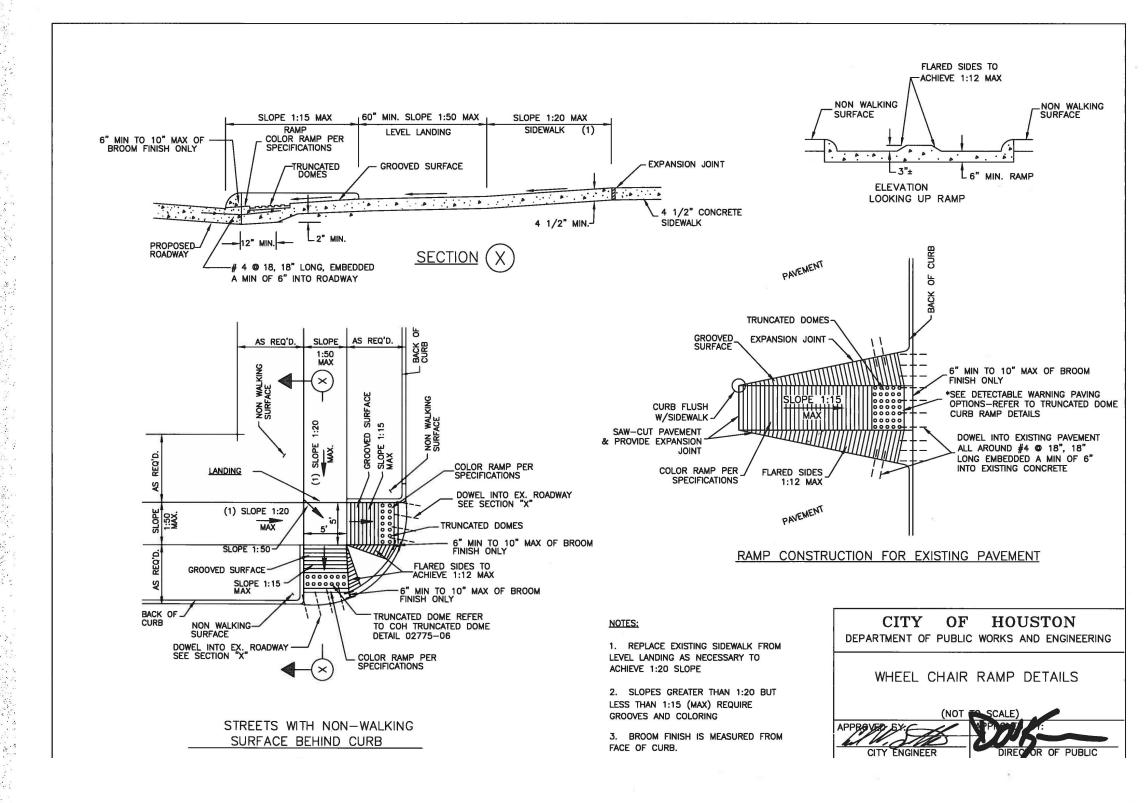

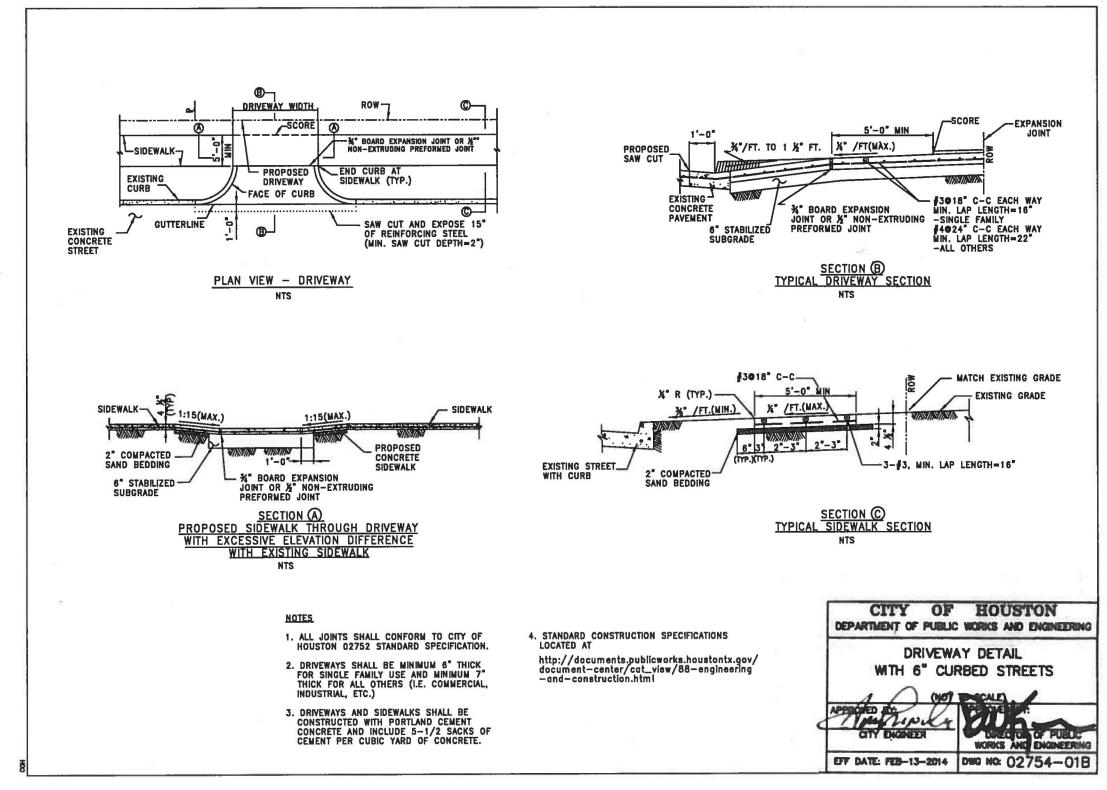




Project number 2019.08

Date 08/03/20

CONSTRUCTION DOCUMENTS

A4

COH Flatwork Details

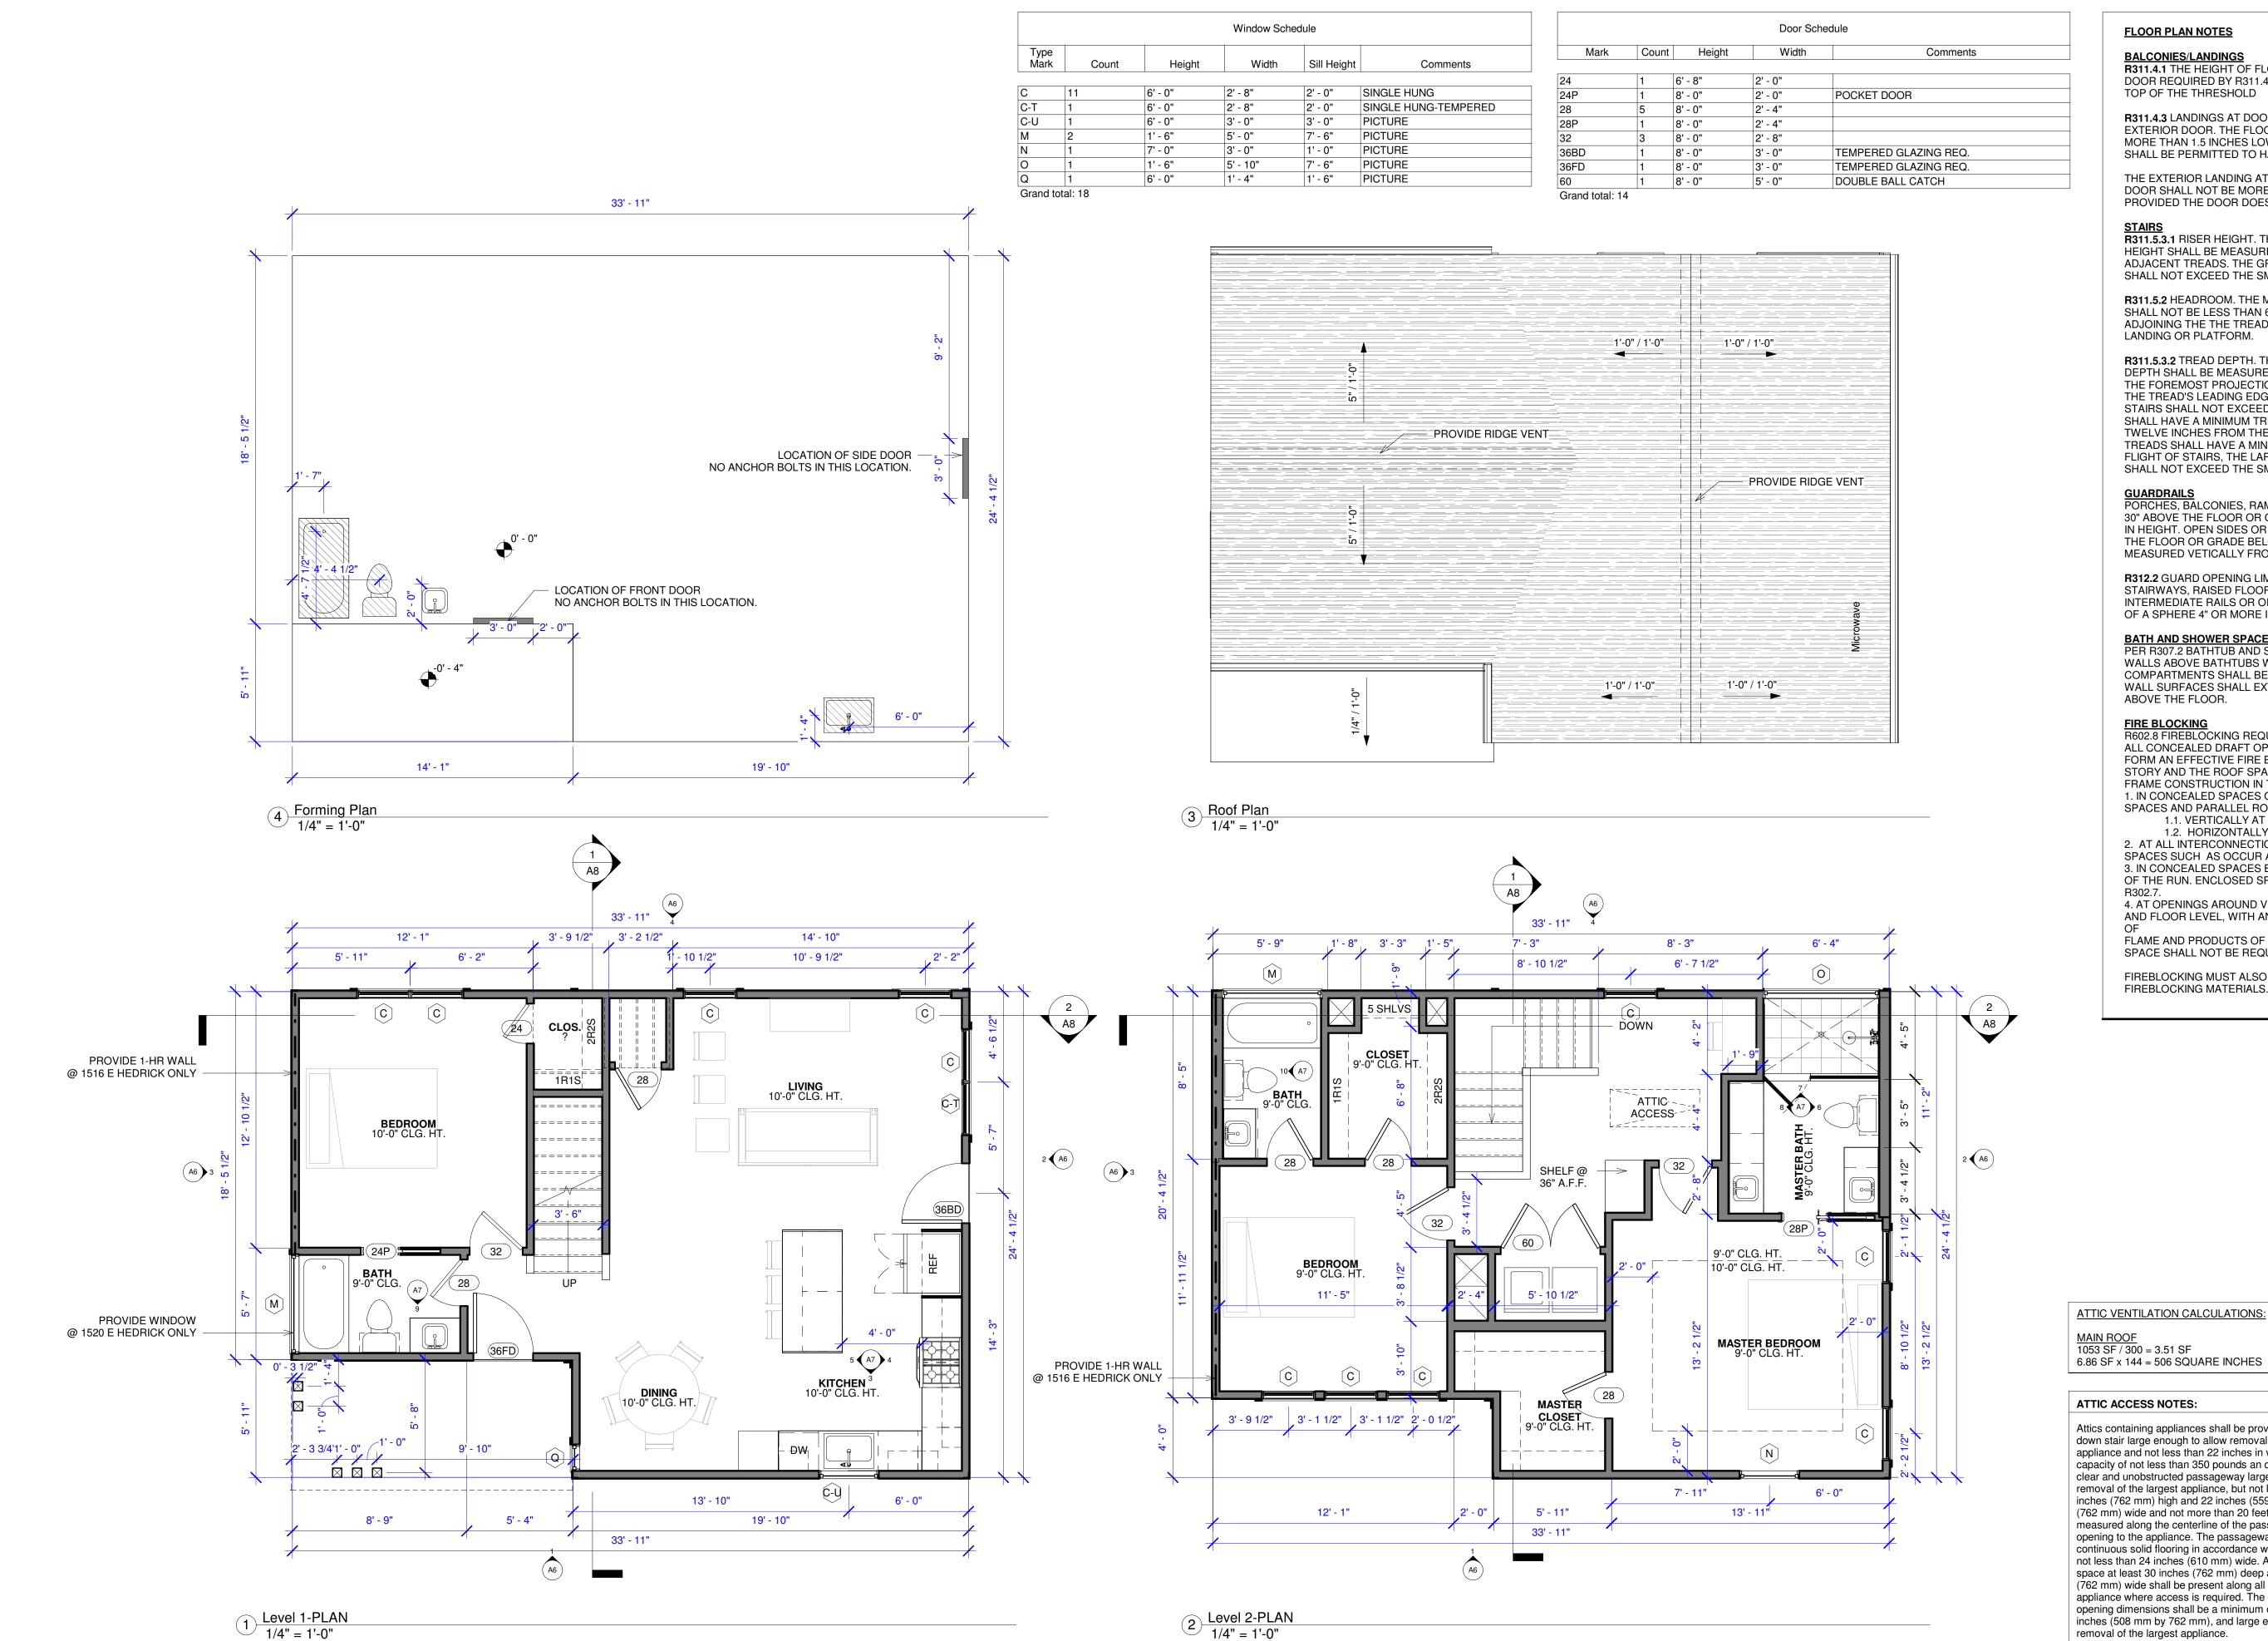

### **FLOOR PLAN NOTES**

R311.4.1 THE HEIGHT OF FLOORS AT EXTERIOR DOORS OTHER THAN THE EXIT DOOR REQUIRED BY R311.4.1 SHALL NOT BE MORE THAN 7 3/4" LOWER THAN THE TOP OF THE THRESHOLD

R311.4.3 LANDINGS AT DOORS. THERE SHALL BE A FLOOR ON EACH SIDE OF EACH EXTERIOR DOOR. THE FLOOR OR LANDING AT THE EXTERIOR DOOR SHALL NOT BE MORE THAN 1.5 INCHES LOWER THAN THE TOP OF THE THRESHOLD. THE LANDING SHALL BE PERMITTED TO HAVE A SLOPE NOT TO EXCEED 1/4" PER FOOT OR 2%.

THE EXTERIOR LANDING AT AN EXTERIOR DOOR OTHER THAN THE REQUIRED EXIT DOOR SHALL NOT BE MORE THAN 7 3/4" BELOW THE TOP OF THE THRESHOLD, PROVIDED THE DOOR DOES NOT SWING OVER THE LANDING.

R311.5.3.1 RISER HEIGHT. THE MAXIMUM RISER HEIGHT SHALL BE 7 3/4". THE RISER HEIGHT SHALL BE MEASURED VERICALLY BETWEEN LEADING EDGES OF THE ADJACENT TREADS. THE GREATEST RISER HEIGHT WITHIN ANY FLIGHT OF STAIRS SHALL NOT EXCEED THE SMALLEST BY MORE THAN 3/8".

R311.5.2 HEADROOM. THE MINIMUM HEADROOM IN ALL PARTS OF THE STAIRWAY SHALL NOT BE LESS THAN 6'-8" MEASURED VERTICALLY FROM THE SLOPED PLAIN ADJOINING THE THE TREAD NOSING OR FROM THE FLOOR SURFACE IF THE LANDING OR PLATFORM.

R311.5.3.2 TREAD DEPTH. THE MINIMUM TREAD DEPTH SHALL BE 10". THE TREAD DEPTH SHALL BE MEASURED HORIZONTALLY BETWEEN THE VERTICAL PLANES OF THE FOREMOST PROJECTION OF ADJACENT TREADS AND AT A RIGHT ANGLE TO THE TREAD'S LEADING EDGE. THE GREATEST TREAD DEPTH WITHIN ANY FLIGHT OF STAIRS SHALL NOT EXCEED THE SMALLEST BY MORE THAN 3/8". WINDER TREADS SHALL HAVE A MINIMUM TREAD DEPTH OF 10" MEASURES AS ABOVE AT A POINT TWELVE INCHES FROM THE SIDE WHERE THE TREADS ARE NARROWER. WINDER TREADS SHALL HAVE A MINIMUM TREAD DEPTH OF 6" AT ANY POINT. WITHIN ANY FLIGHT OF STAIRS, THE LARGEST WINDER TREAD DEPTH AT THE 12" WALK LINE SHALL NOT EXCEED THE SMALLEST BY MORE THAN 3/8".

PORCHES, BALCONIES, RAMPS OR RAISED FLOOR SURFACES LOCATED MORE THAN 30" ABOVE THE FLOOR OR GRADE BELOW SHALL HAVE GUARDS NOT LESS THAN 36" IN HEIGHT. OPEN SIDES OR STAIRS WITH A TOTAL RISE OF MORE THAN 30" ABOVE THE FLOOR OR GRADE BELOW SHALL HAVE GUARDS NOT LESS THAN 34" IN HEIGHT MEASURED VETICALLY FROM THE NOSING OF THE TREADS.

R312.2 GUARD OPENING LIMITATIONS. REQUIRED GUARDS ON OPEN SIDES OF STAIRWAYS, RAISED FLOOR AREAS, BALCONIES AND PORCHES SHALL HAVE INTERMEDIATE RAILS OR ORNAMENTAL CLOSURES WHICH DO NOT ALOW PASSAGE OF A SPHERE 4" OR MORE IN DIAMETER.

PER R307.2 BATHTUB AND SHOWER SPACES. BATHTUB AND SHOWER FLOORS AND WALLS ABOVE BATHTUBS WITH INSTALLED SHOWER HEADS AND IN SHOWER COMPARTMENTS SHALL BE FINISHED WITH A NON-ABSORBANT SURFACE. SUCH WALL SURFACES SHALL EXTEND TO A HEIGHT OF NOT LESS THAN 6' (1829mm) ABOVE THE FLOOR.

R602.8 FIREBLOCKING REQUIRED. FIREBLOCKING SHALL BE PROVIDED TO CUT OFF ALL CONCEALED DRAFT OPENINGS(BOTH VERTICAL AND HORIZONTAL) AND TO FORM AN EFFECTIVE FIRE BARRIER BETWEEN STORIES AND BETWEEN A TOP STORY AND THE ROOF SPACE. FIREBLOCKING SHALL BE PROVIDED IN WOOD-FRAME CONSTRUCTION IN THE FOLLOWING LOCATIONS:

1. IN CONCEALED SPACES OF STUD WALLS AND PARTITIONS, INCLUDING FURRED SPACES AND PARALLEL ROWS OF STUDS OR STAGGERED STUDS AS FOLLOWS: 1.1. VERTICALLY AT THE CEILING AND FLOOR LEVELS

1.2. HORIZONTALLY AT INTERVALS NOT EXCEEDING 10 FEET (3048mm). 2. AT ALL INTERCONNECTIONS BETWEEN CONCEALED VERTICAL AND HORIZONTAL SPACES SUCH AS OCCUR AT SOFFITS, DROP CEILINGS AND COVE CEILINGS. 3. IN CONCEALED SPACES BETWEEN STAIR STRINGERS AT THE TOP AND BOTTOM OF THE RUN. ENCLOSED SPACES UNDER STAIRS SHALL COMPLY WITH SECTION

4. AT OPENINGS AROUND VENTS, PIPES, DUCTS, CABLES AND WIRES AT CEILING AND FLOOR LEVEL, WITH AN APPROVED MATERIAL TO RESIST THE FREE PASSAGE

FLAME AND PRODUCTS OF COMBUSTION. THE MATERIAL FILLING THIS ANNULAR

SPACE SHALL NOT BE REQUIRED TO MEET THE ASTM E 136 REQUIREMENTS.

FIREBLOCKING MUST ALSO COMPLY WITH 2012 IRC SECTION R302.11.1 FIREBLOCKING MATERIALS.



DRAFT HOUSE DESIGN STUDIO, LLC. Avenue 'O' - Fat Farmhouse

> Vecino Homes 1516 & 1520 E Hedrick Street

Houston, TX 77011

6.86 SF x 144 = 506 SQUARE INCHES

## ATTIC ACCESS NOTES:

Attics containing appliances shall be provided with pull down stair large enough to allow removal of the largest appliance and not less than 22 inches in width with a load capacity of not less than 350 pounds an opening and a clear and unobstructed passageway large enough to allow removal of the largest appliance, but not less than 30 inches (762 mm) high and 22 inches (559 mm) 30 inches (762 mm) wide and not more than 20 feet (6096 mm) long measured along the centerline of the passageway from the opening to the appliance. The passageway shall have continuous solid flooring in accordance with Chapter 5 not less than 24 inches (610 mm) wide. A level service space at least 30 inches (762 mm) deep and 30 inches (762 mm) wide shall be present along all sides of the appliance where access is required. The clear access opening dimensions shall be a minimum of 20 inches by 30 inches (508 mm by 762 mm), and large enough to allow removal of the largest appliance.


2020.1008 Project number 08/03/2020

Construction Doc.

Floor Plans





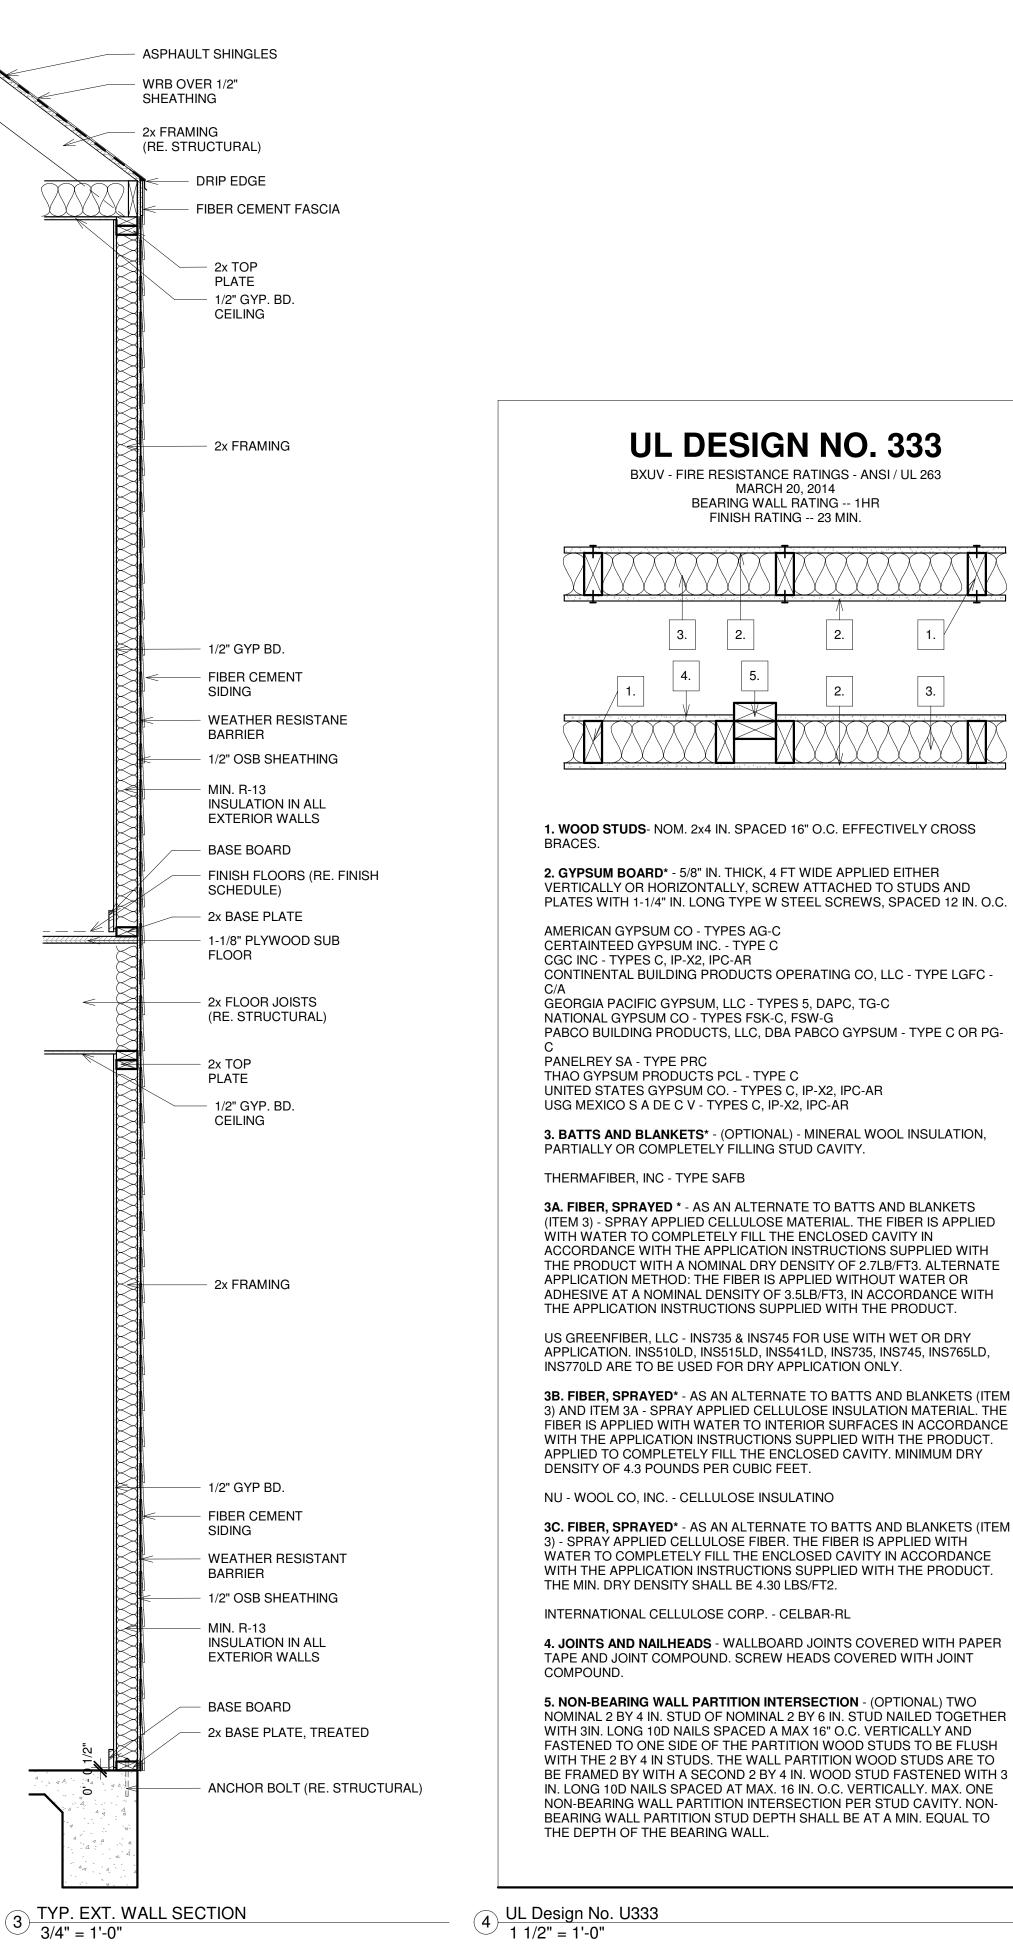

# **UL DESIGN NO. 333** BXUV - FIRE RESISTANCE RATINGS - ANSI / UL 263 MARCH 20, 2014 BEARING WALL RATING -- 1HR FINISH RATING -- 23 MIN. PLATES WITH 1-1/4" IN. LONG TYPE W STEEL SCREWS, SPACED 12 IN. O.C. CONTINENTAL BUILDING PRODUCTS OPERATING CO, LLC - TYPE LGFC -PABCO BUILDING PRODUCTS, LLC, DBA PABCO GYPSUM - TYPE C OR PG-

NU - WOOL CO, INC. - CELLULOSE INSULATINO

**3C. FIBER, SPRAYED\*** - AS AN ALTERNATE TO BATTS AND BLANKETS (ITEM 3) - SPRAY APPLIED CELLULOSE FIBER. THE FIBER IS APPLIED WITH WATER TO COMPLETELY FILL THE ENCLOSED CAVITY IN ACCORDANCE WITH THE APPLICATION INSTRUCTIONS SUPPLIED WITH THE PRODUCT. THE MIN. DRY DENSITY SHALL BE 4.30 LBS/FT2.

INTERNATIONAL CELLULOSE CORP. - CELBAR-RL

4. JOINTS AND NAILHEADS - WALLBOARD JOINTS COVERED WITH PAPER TAPE AND JOINT COMPOUND. SCREW HEADS COVERED WITH JOINT

5. NON-BEARING WALL PARTITION INTERSECTION - (OPTIONAL) TWO NOMINAL 2 BY 4 IN. STUD OF NOMINAL 2 BY 6 IN. STUD NAILED TOGETHER WITH 3IN. LONG 10D NAILS SPACED A MAX 16" O.C. VERTICALLY AND FASTENED TO ONE SIDE OF THE PARTITION WOOD STUDS TO BE FLUSH WITH THE 2 BY 4 IN STUDS. THE WALL PARTITION WOOD STUDS ARE TO BE FRAMED BY WITH A SECOND 2 BY 4 IN. WOOD STUD FASTENED WITH 3 IN. LONG 10D NAILS SPACED AT MAX. 16 IN. O.C. VERTICALLY. MAX. ONE NON-BEARING WALL PARTITION INTERSECTION PER STUD CAVITY. NON-BEARING WALL PARTITION STUD DEPTH SHALL BE AT A MIN. EQUAL TO THE DEPTH OF THE BEARING WALL.

MIN. R-33 INSULATION @ ALL ATTIC SPACES Level 3-PLAN 20' - 6" MASTER CLOSET 9'-0" CLG. H Level 2-PLAN 11' - 6" 18" OPEN WEB TRUSS 2x4 STUDS @ ALL EXTERIOR WALLS SPACED 16-INCHES O.C. 2x4 STUDS @ ALL EXTERIOR WALLS MIN. R-13 INSULATION @ ALL EXTERIOR WALLS SPACED 16-INCHES O.C. MIN. R-13 INSULATION @ ALL EXTERIOR WALLS -

SPACE SHALL NOT BE REQUIRED TO MEET THE ASTM E 136 REQUIREMENTS. FIREBLOCKING MATERIALS. MIN. R-33 INSULATION @ ALL ATTIC SPACES <u>Level 3-PLAN</u> 20' - 6" 1-HR FIREWALL @ 1516 E HEDRICK ONLY 2x6 STUDS @ ALL EXTERIOR/PLUMBING WALLS Level 2-PLAN 11' - 6" 18" OWT 18" OWT 2x4 STUDS @ ALL EXTERIOR WALLS SPACED 16-INCHES O.C. 2x4 STUDS @ ALL EXTERIOR WALLS SPACED 16-INCHES O.C. MIN. R-13 INSULATION @ ALL EXTERIOR WALLS CLOS. MIN. R-13 INSULATION @ ALL EXTERIOR WALLS Level 1-PLAN 0' - 0"

## **FLOOR PLAN NOTES**

R311.4.1 THE HEIGHT OF FLOORS AT EXTERIOR DOORS OTHER THAN THE EXIT DOOR REQUIRED BY R311.4.1 SHALL NOT BE MORE THAN 7 3/4" LOWER THAN THE TOP OF THE THRESHOLD

R311.4.3 LANDINGS AT DOORS. THERE SHALL BE A FLOOR ON EACH SIDE OF EACH EXTERIOR DOOR. THE FLOOR OR LANDING AT THE EXTERIOR DOOR SHALL NOT BE MORE THAN 1.5 INCHES LOWER THAN THE TOP OF THE THRESHOLD. THE LANDING SHALL BE PERMITTED TO HAVE A SLOPE NOT TO EXCEED 1/4" PER FOOT OR 2%.

THE EXTERIOR LANDING AT AN EXTERIOR DOOR OTHER THAN THE REQUIRED EXIT DOOR SHALL NOT BE MORE THAN 7 3/4" BELOW THE TOP OF THE THRESHOLD, PROVIDED THE DOOR DOES NOT SWING OVER THE LANDING.

R311.5.3.1 RISER HEIGHT. THE MAXIMUM RISER HEIGHT SHALL BE 7 3/4". THE RISER HEIGHT SHALL BE MEASURED VERICALLY BETWEEN LEADING EDGES OF THE ADJACENT TREADS. THE GREATEST RISER HEIGHT WITHIN ANY FLIGHT OF STAIRS SHALL NOT EXCEED THE SMALLEST BY MORE THAN 3/8".

R311.5.2 HEADROOM. THE MINIMUM HEADROOM IN ALL PARTS OF THE STAIRWAY SHALL NOT BE LESS THAN 6'-8" MEASURED VERTICALLY FROM THE SLOPED PLAIN ADJOINING THE THE TREAD NOSING OR FROM THE FLOOR SURFACE IF THE LANDING OR PLATFORM.

R311.5.3.2 TREAD DEPTH. THE MINIMUM TREAD DEPTH SHALL BE 10". THE TREAD DEPTH SHALL BE MEASURED HORIZONTALLY BETWEEN THE VERTICAL PLANES OF THE FOREMOST PROJECTION OF ADJACENT TREADS AND AT A RIGHT ANGLE TO THE TREAD'S LEADING EDGE. THE GREATEST TREAD DEPTH WITHIN ANY FLIGHT OF STAIRS SHALL NOT EXCEED THE SMALLEST BY MORE THAN 3/8". WINDER TREADS SHALL HAVE A MINIMUM TREAD DEPTH OF 10" MEASURES AS ABOVE AT A POINT TWELVE INCHES FROM THE SIDE WHERE THE TREADS ARE NARROWER. WINDER TREADS SHALL HAVE A MINIMUM TREAD DEPTH OF 6" AT ANY POINT. WITHIN ANY FLIGHT OF STAIRS, THE LARGEST WINDER TREAD DEPTH AT THE 12" WALK LINE SHALL NOT EXCEED THE SMALLEST BY MORE THAN 3/8".

PORCHES, BALCONIES, RAMPS OR RAISED FLOOR SURFACES LOCATED MORE THAN 30" ABOVE THE FLOOR OR GRADE BELOW SHALL HAVE GUARDS NOT LESS THAN 36" IN HEIGHT. OPEN SIDES OR STAIRS WITH A TOTAL RISE OF MORE THAN 30" ABOVE THE FLOOR OR GRADE BELOW SHALL HAVE GUARDS NOT LESS THAN 34" IN HEIGHT MEASURED VETICALLY FROM THE NOSING OF THE TREADS.

R312.2 GUARD OPENING LIMITATIONS. REQUIRED GUARDS ON OPEN SIDES OF STAIRWAYS, RAISED FLOOR AREAS, BALCONIES AND PORCHES SHALL HAVE INTERMEDIATE RAILS OR ORNAMENTAL CLOSURES WHICH DO NOT ALOW PASSAGE OF A SPHERE 4" OR MORE IN DIAMETER.

PER R307.2 BATHTUB AND SHOWER SPACES. BATHTUB AND SHOWER FLOORS AND WALLS ABOVE BATHTUBS WITH INSTALLED SHOWER HEADS AND IN SHOWER COMPARTMENTS SHALL BE FINISHED WITH A NON-ABSORBANT SURFACE. SUCH WALL SURFACES SHALL EXTEND TO A HEIGHT OF NOT LESS THAN 6' (1829mm) ABOVE THE FLOOR.

R602.8 FIREBLOCKING REQUIRED. FIREBLOCKING SHALL BE PROVIDED TO CUT OFF ALL CONCEALED DRAFT OPENINGS(BOTH VERTICAL AND HORIZONTAL) AND TO FORM AN EFFECTIVE FIRE BARRIER BETWEEN STORIES AND BETWEEN A TOP STORY AND THE ROOF SPACE. FIREBLOCKING SHALL BE PROVIDED IN WOOD-FRAME CONSTRUCTION IN THE FOLLOWING LOCATIONS:

1. IN CONCEALED SPACES OF STUD WALLS AND PARTITIONS, INCLUDING FURRED SPACES AND PARALLEL ROWS OF STUDS OR STAGGERED STUDS AS FOLLOWS: 1.1. VERTICALLY AT THE CEILING AND FLOOR LEVELS

1.2. HORIZONTALLY AT INTERVALS NOT EXCEEDING 10 FEET (3048mm). 2. AT ALL INTERCONNECTIONS BETWEEN CONCEALED VERTICAL AND HORIZONTAL SPACES SUCH AS OCCUR AT SOFFITS, DROP CEILINGS AND COVE CEILINGS. 3. IN CONCEALED SPACES BETWEEN STAIR STRINGERS AT THE TOP AND BOTTOM OF THE RUN. ENCLOSED SPACES UNDER STAIRS SHALL COMPLY WITH SECTION

4. AT OPENINGS AROUND VENTS, PIPES, DUCTS, CABLES AND WIRES AT CEILING AND FLOOR LEVEL, WITH AN APPROVED MATERIAL TO RESIST THE FREE PASSAGE

FLAME AND PRODUCTS OF COMBUSTION. THE MATERIAL FILLING THIS ANNULAR

FIREBLOCKING MUST ALSO COMPLY WITH 2012 IRC SECTION R302.11.1



COPYRIGHT © 2020 DRAFT HOUSE DESIGN STUDIO, LLC.

Avenue 'O' - Fat Farmhouse

Vecino Homes

1516 & 1520 E Hedrick Street Houston, TX 77011


2020.1008 Project number 08/03/2020

Construction Doc.

2 Section 2 1/4" = 1'-0"

1/4" = 1'-0"

Section & Details

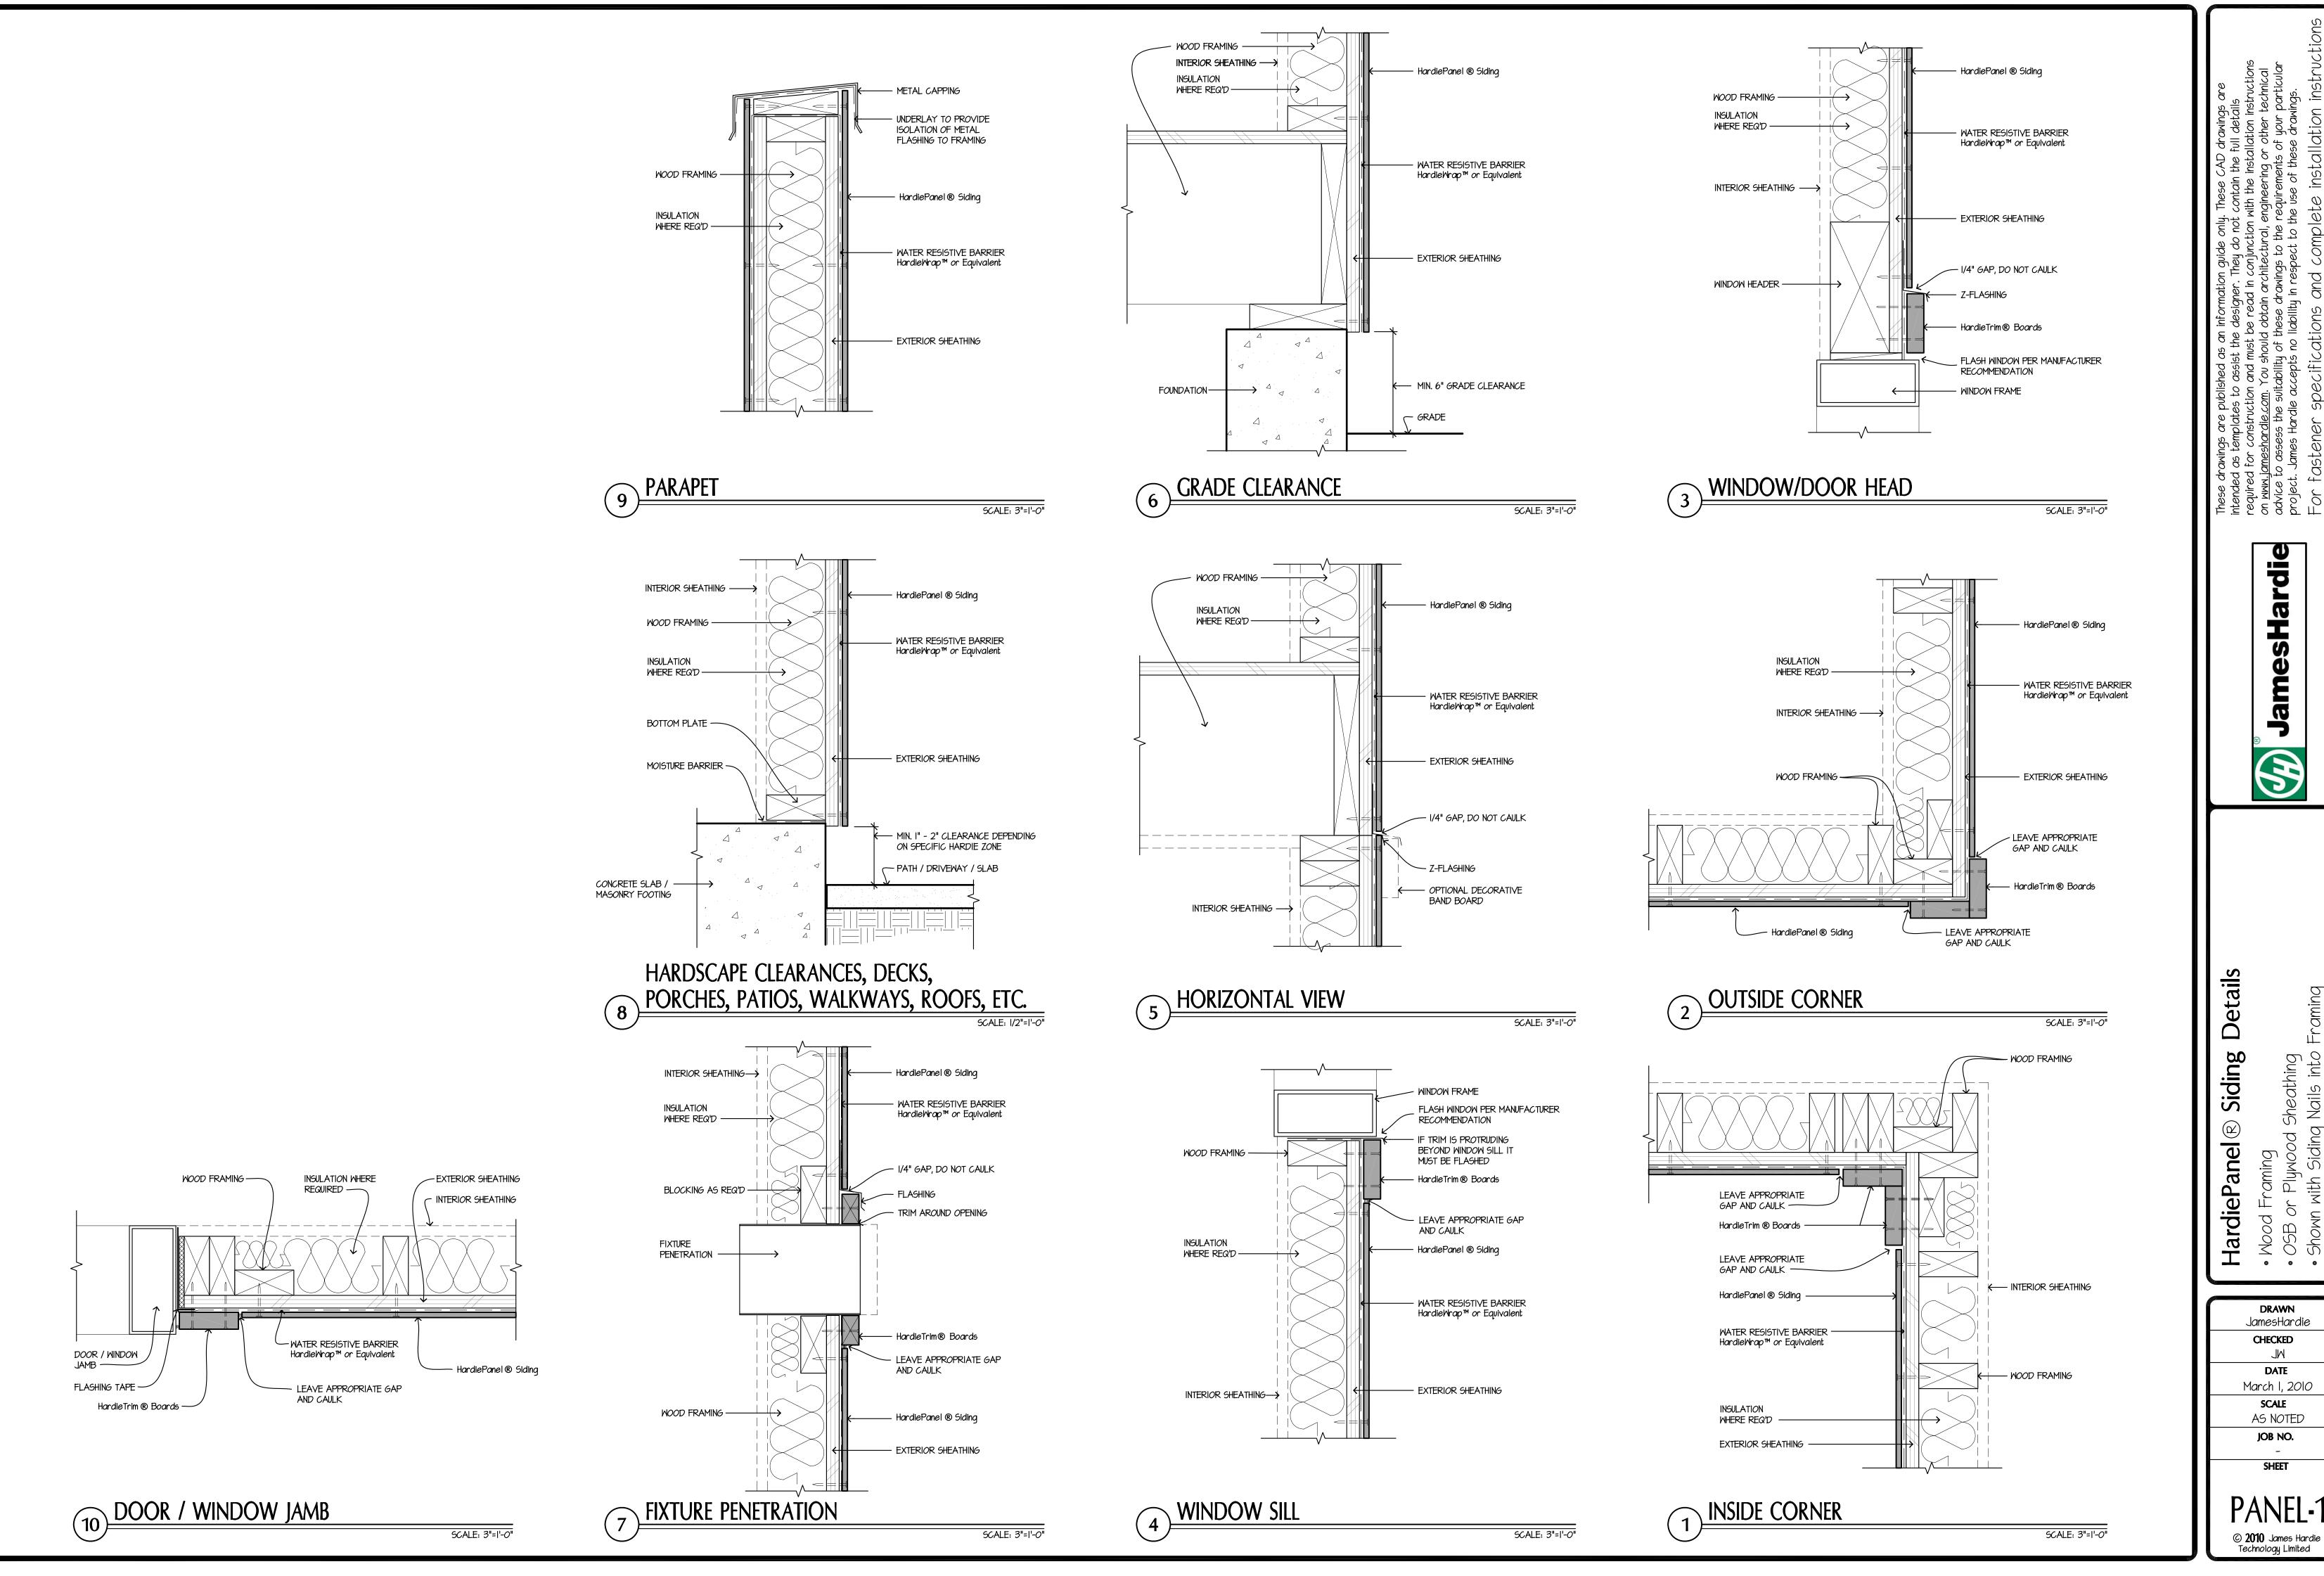

JamesHardie

**Details** Siding HardiePanel®

Mood FrcOSB or FShown wit

JamesHardie CHECKED March 1, 2010 AS NOTED JOB NO. PANEL-1