
DRAINAGE NOTES

NO MORE THAN 1-FOOT OF FILL VILL BE PLACED ON THE LOT
PRIMARY USE OF FILL WILL BE YARD LEVELING
EXISTING DRAINAGE PATTENS WILL BE MESSEVED
FINAL DRAINAGE VILL BE MESTELL BY THE EXISTING PARALLEL DITCH
FINAL DRAINAGE VILL BE MESTELLU AND SIDE/ARD SVALES
AT FM5005 BY WAY OF SHETFLLW AND SIDE/ARD SVALES

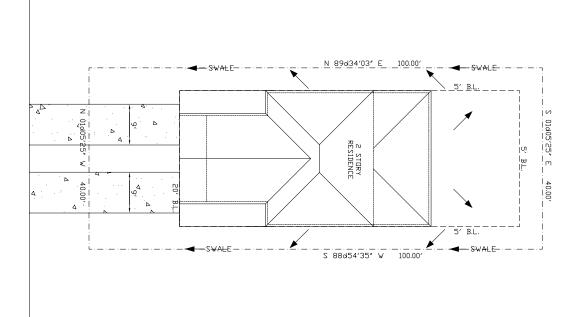

MINIMUM OF TWO TREES PER CITY ORDINANCE SHALL BE INSTALLED IN FRONT YARD MINIMUM 3" DIA, AND SPECIES PER CITY ORDINANCE

ALL DOWN SPOUTS SHALL BE TIED INTO NON-PERFORATED UNDERGROUND PVC PIPE WITH DISCHARGE LOCATED AT DITCH LINE IN FRONT OF PROPERTY

GUTTERS SHALL BE INSTALLED AROUND PERIMETER OF ROOF

411 PINE ROAD

NORTH SITE PLAN

SCALE: 1" = 10'-0"

> CLEAR \square 1, LAKE SHORES, TEXAS BLOCK 1

411 PINE ROAD

INDEX OF DRAWINGS

1 - COVER SHEET/SITE PLAN

2 - FOUNDATION / GROUND FLOOR PLAN

3 - IST FLOOR PLAN / CELLING JOIST PLAN

4 - 2ND FLOOR PLAN / CELLING JOIST PLAN

5 - FRONT & REAR ELEVATIONS / ROOF PLAN

6 - LEFT & RIGHT ELEVATIONS / ROOF PLAN

7 - ELECTRICAL PLAN

8 - TYPICAL DETAILS

REVISION / ISSUE DATE

GROUND FLOOR: FIRST FLOOR: SECOND FLOOR: COVERED PORCH: TOTAL LIVING:

2,471 SQ. FT. 177 SQ. FT. 1,362 SQ. FT. 932 SQ. FT. 346 SQ. FT.

411 PINE ROAD LOT 1, BLK 1 CLEAR LAKE SHORES TEXAS

ROJECT NAME & ADDRESS

ALL WORK SHALL BE IN STRICT COMPLIANCE WITH ALL APPLICABLE WINDSTORM CODES LOCAL BUILDING CODES & ORDINANCES


SHEET

DATE: JULY 23, 2018

COVER SHEET SITE PLAN DRAINAGE PLAN

무

 \otimes

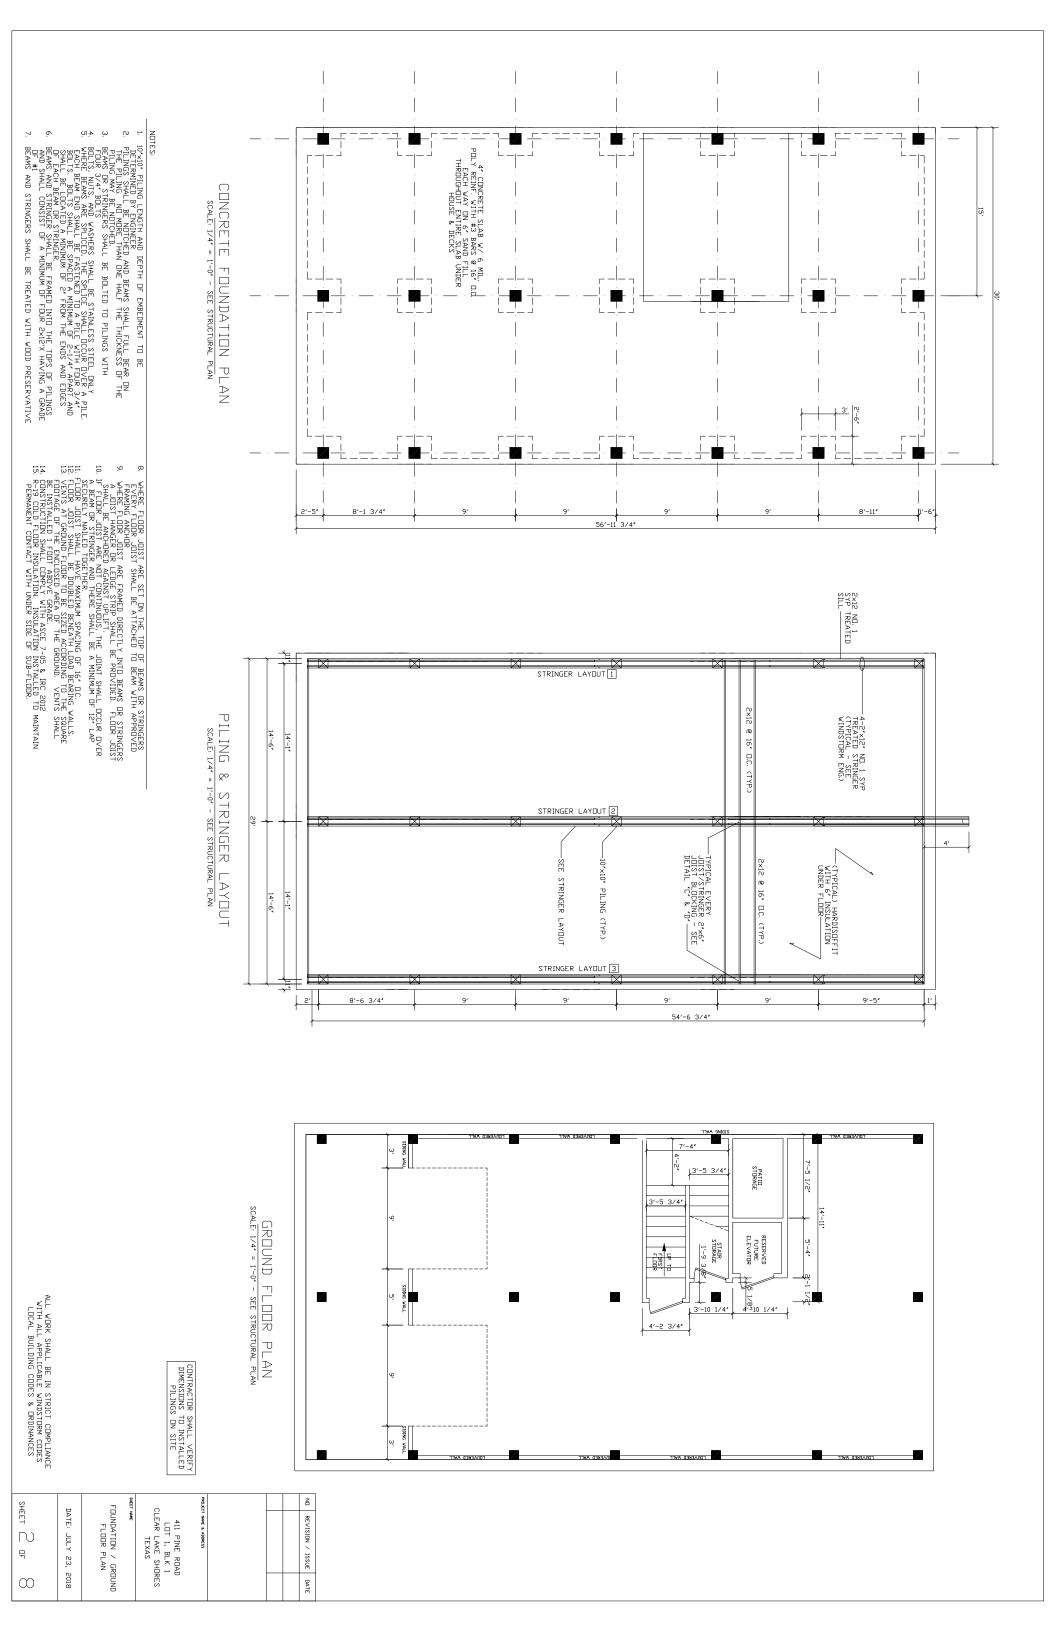

ALL WORK SHALL BE IN STRICT COMPLIANCE
WITH ALL APPLICABLE WINDSTORM CODES
LOCAL BUILDING CODES & ORDINANCES

SHEET

 ω

무

 \otimes

DATE:

JULY 23,

2018

NOTES:

1. MAIN FLORR - 9' CEILINGS UNLESS NOTED DIHERVISE
2. CEILING JUIST #2 Y.P. 16' D.C. (2×6 MIN.)
3. STRONG-BACK ALL SPANS DYER 10'
4. LAMINATED SUPPERT BEAMS TO BE USE FOR LARGE
SPANS (GLUE AND NAIL 1/2 PLY BETVEEN 2×12S')
5. INTERIOR WALL STUDS 2×4 916' D.C.
6. EXTERIOR WALL STUDS 2×6 916' D.C. AND 8' D.C.
7. STUDS 3*2 GRADE YELLOW PINE
8. VINDOWS AND DORSS APPROVED BY TDI FOR 130 MPH
VIND AND PER 2012 IRC
9. HOLD DOWN ANCHORS AT EACH CORNER PER ENGINEER
10. EXTERIOR SHEATHING TO BE 5/8 PLYVOOD (TYPICAL)
11. INSULATION R-19 COLD FLODE, R-19 WALLS, R-30 ATTIC

| FIRST FLOOR PLAN | SHEET NAME | 411 PINE ROAD LOT 1, BLK 1 CLEAR LAKE SHORES TEXAS | PROJEC | POLECT WHE & ADDRESS | | ND. |
|---------------------|------------|---|------------------|----------------------|--|------------------|
| | NAME | | T MAME & ADDRESS | | | REVISION / ISSUE |
| | | | | | | DATE |

5'-1 1/4" 14'-11 1/2" 9,-8, H'H' 3025 2H DC 6.-8 H.H. 2660 SH DL 6.-8 HH. See0 2H DF 6'-8' H.H. 3652 SH DL FLT PANEL RECESS 5/8" 3'-5 3/8" 3060 SH DL 6'-8' H.H. VENTLESS N.G. FIREPLACE WALK IN CLST. 10'-8"×11'-8" BEDROOM 1 9' CLG. WOOD FL. 10'-7 1/2" 5040 SLIDER 6'-8' H.H. 3060 SH DL 6'-8 H.H. 16'-2"x21'-5" LIVING ROOM 9' CLG. WOOD FL. 4'-7"
4' RESERVED
FUTURE
4 ELEVATOR 1ST FLOOR DEVELOUD TO BATH 1
9' CLG.
7' CLG.
5' O 29'-0"x8'-0" COVERED DECK 6068 DBL DR | | 3'-5 3/4" | 3'-5 3/4" | HVAC CONDENSOR DECK 9'-4 3/8" 8'-2 1/2" 7′-8 1/2″ 9, CLG./WDDD FL. 8′-5* 3' 1 1 8' PLAN FRIDGE. | -----7'-6 1/2" KITCHEN 0 11'-9"×10'-6" DINING AREA 9'CLG. WOOD FL. 11'-5"×11'-8" BEDROOM 2 9' CLG. WOOD FL. MES ASTONOMA BATH 2 9' CLG. TILE FL. 11'-4 1/2" 5040 SLIDER 6'-8' H.H. 0 9'-9 7/8" 6'-3 3/4" 94NTRY 3'-10" SHWR 9.-8, H'H' 3025 ZH DC 9,-8, HH 3090 ZH DF 46'-11 3/4"

FLT PANEL RECESS 22' FLOOR TRUSS @ 16' D.C. 22' FLOOR TRUSS @ 16' D.C. VENTLESS N.G. FIREPLACE 1ST FLOOR CEILING BEDROOM 1 LIVING ROOM 22" FLOOR TRUSS @ 16" O.C. RESERVED FUTURE ELEVATOR END TO 22" FLOOR TRUSS @ 16" D.C. 22' FLOOR TRUSS @ 16' O.C. 22' FLOOR TRUSS @ 16' D.C. 787 5 788 1 BATH COVERED DECK HVAC CONDENSOR DECK I JJ∀H FRIDGE. TSIOL 22' FLOOR TRUSS @ 16' O.C. 22' FLOOR TRUSS @ 16" D.C. 0 KITCHEN DINING AREA LINEN WIS 25TOHAW BATH 2 BEDROOM 2 TRUSS @ 16" D.C. 0 7 Ž PANTRY

ALL WORK SHALL BE IN STRICT COMPLIANC WITH ALL APPLICABLE WINDSTORM CODES LOCAL BUILDING CODES & ORDINANCES

2ND FLOOR F 6068 DBL DR PLAN 3060 SH DL 6'-8 H.H. 6'-8' H.H.

Ņ.

REVISION / ISSUE DATE

2X8 @16' D.C. 2X8 @16' D.C. 2X8 @16" D.C. WALK-IN CLST. 2X8 @16" D.C. /2×10 @16" D.C. 2X10 @16* D.C. 2X10 @16* D.C. MASTER BDRM 2X10 @16' D.C. 816. S JJAH 2X8 @16* D.C. 2X8 @16" D.C. 2X8 @16' D.C LNDRY 2X8 e16' D.C. 2x8 816" D.C. 2X8 @16' D.C.

MECHANICAL

STORAGE

2X8 @16' D.C. ватн з 0 CEILING VAULTED 0

2ND FLOOR CEILING JOINT PLAN

NOTES:

1. MAIN FLORR - 9' CEILINGS UNLESS NOTED D'HERWISE
2. CEILING JOIST #2 YP, 16' D.C. (2>6 MIN.)
3. STRONG-BACK ALL SPANS D'VER 10'
4. LAMINATED SUPPORT BEANS TO BE USE FOR LARGE
SPANS GOLUE AND NAIL 1/2 PLY BETWEEN 2×12'S)
5. INTERIOR WALL STUDS 2×4 0 6' D.C.
6. EXTERIOR WALL STUDS 2×6 0 16' D.C. AND 8' D.C.
IN CORNERS FOR 4'
7. STUDS #2 GRADE YELLOW PINE
8. WINDOWS AND DOORS APPROVED BY TDI FOR 130 MPH
WIND AND PER 2012 IRC
9. HOLD DOWN ANCHORS AT EACH CORNER PER ENGINEER
10. EXTERIOR SHEATHING TO BE 5/8 PLYMODD (TYPICAL)
11. INSULATION R-19 COLD FLODE, R-19 WALLS, R-30 ATTIC

13'-5 1/4" 6'-8 H.H. 2016 FXD 9,-8, H'H' 3925 ZH DF 4'-7 1/2" 6'-8' H.H. 11'-10"x8'-6" WALK-IN CLST. 8' CLG. CARPET 6'-8' H.H. 3'-5 3/4" 3'-5 3/4" 14'-7 1/4" 3060 SH DL 6'-8' H.H. 4 RESERVED - FUTURE 4 ELEVATOR DN TO 17'-11"×14'-7"
MASTER BDRM
9' CLG.
WOOD FL. 9, CLG,/WOOD FL. HALL 2 HALL 2 1,4/1 ATTIC ACCESS 1'-10 3'-9 1/4" BATH 3 9' CLG. TILE FL. 237 0 1/2* 6'-8' H.H. 0 6'-8' H.H. 2020 FXD 3'-10 1/2" 13'-5 1/4" 12'-2 1/2" 36'-9 1/4" 54'-11 3/4"

| S | | | | | | |
|--------------|---------------------|----------------------|------------|--|--|--|
| SHEET 4 OF 8 | DATE: JULY 23, 2018 | SECOND FLOOR PLAN | SHEET NAME | 411 PINE ROAD LOT 1, BLK 1 CLEAR LAKE SHORES TEXAS | | |

ROOF SCALE: 1/4" = 1'-0" NOTES:

IR RIDGES, HIP, AND VALLEY RAFTERS - 2X8 (MUST BE AT LEAST AS LARGE AS CONNECTING RAFTER CUTS)

COMMON AND JACK RAFTERS - 16' DC. (2X6 MIN WITH 11'-2' MAX SPAN)

PRELINS - 2X46' - 27' DC., 2-2X4' TF BRAGE IS OVER 8' LONG

BRACES - 2X6' - EVERY RAFTER & INSTALLED DN UPPER 1/3 OF MATTING RAFTERS 916' DC.

MATTING RAFTERS 916' DC.

MATTING RAFTERS 916' DC.

MATTING RAFTERS 916' DC.

MATTING RAFTERS 18' DC.

SHALL BE YP #2 DR BETTER

AUTOLOGY SHALL BE YP #2 DR BETTER

HURBER LISTED ABOVE SHALL BE YP #3 DN BETTER

HURBER LISTED ABOVE SHALL BE YP #3 DN BETTER

HURBER LISTED ABOVE SHALL BETTER

HURBER LISTED BETTER

HURBER LISTED ABOVE SHALL BETTER


HURBER LISTED BETTER


HURBER LISTED ABOVE SHALL BETTER

HURBER LISTED ABOVE SHALL BETTER BETTER


HURBER LISTED ABOVE SHALL BETTER BETTER

HURBER LISTED ABOVE SHALL BETTER BUTTER BETTER BETTER BETTER BETTER B 11 /// 6 12 1// 111 REAR ELEVATION 1// /// /// /// /// — ASPHALT SHINGLES ASTM D3161 MODIFIED FOR 120 MPH (TYPICAL) ALL WORK SHALL BE IN STRICT COMPLIANCE WITH ALL APPLICABLE WINDSTORM CODES LOCAL BUILDING CODES & ORDINANCES — ASPHALT SHINGLES ASTM D3161 MDDIFIED FOR 120 MPH (TYPICAL) FRONT ELEVATION SHEET 5 FRONT & REAR ELEVATIONS / ROOF PLAN 411 PINE ROAD LOT 1, BLK 1 CLEAR LAKE SHORES TEXAS DATE: JULY 23, 2018 REVISION / ISSUE 뮈 DATE ∞

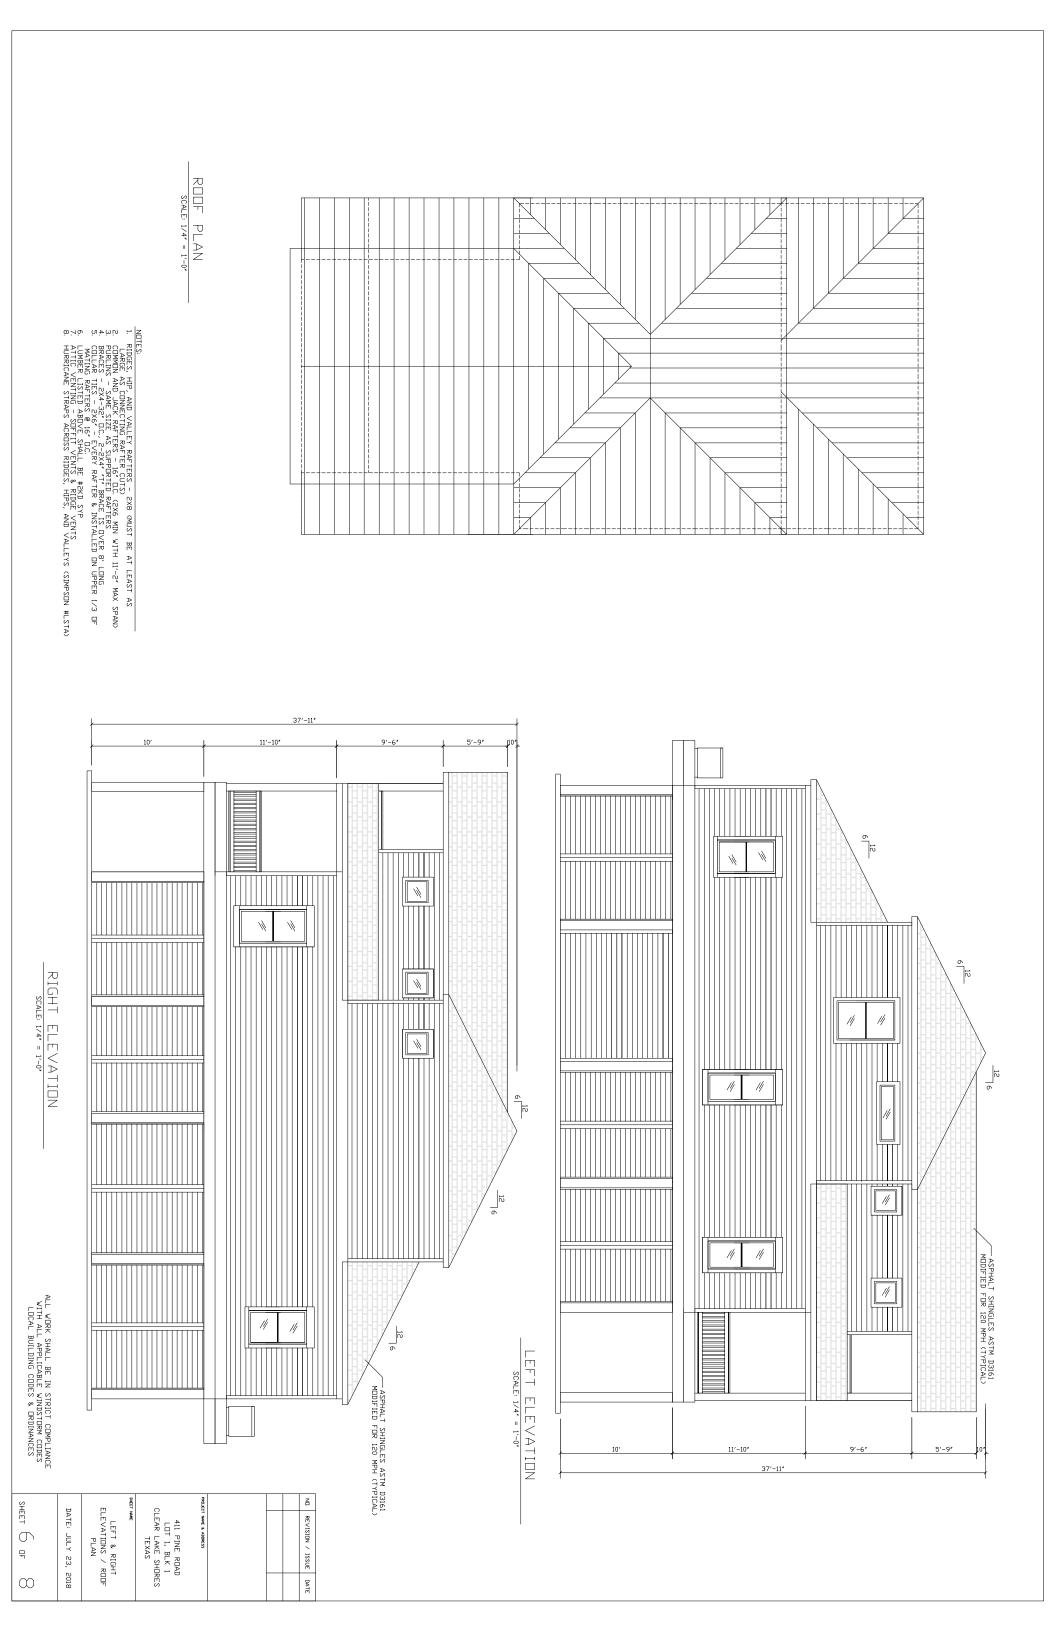

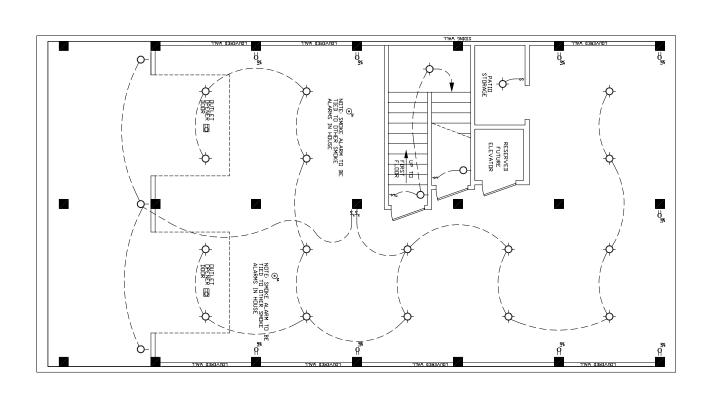

GRND. FL. ELECTRICAL PLAN NOTE: ALL ELECTRICAL SHALL BE MOUNTED ABOVE BASE FLOOD ELEV.

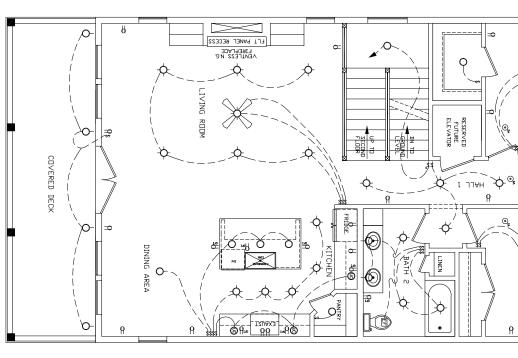

WALK-IN CLST.

⊙,

6

BATH 1

RESERVED FUTURE ELEVATOR

STORAGE O

HALL 2

* LNDRY

9

WATER HEATER ATTIC


*** 9**

S CERTIFICATION PLAN

HVAC CONDENSOR DECK

FIRST FL. ELECTRICAL PLAN

SCALE: 1/4' = 1'-0'

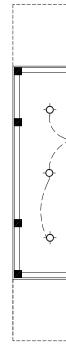



SECOND FL. ELECTRICAL SCALE: 1/4" = 1"-0"

PLAN

ELECTRICAL LEGEND

GROUND FAULT INTERRUPT DUPLEX OUTLET

- ELECTRICAL PANEL

| | Ë | |
|--|------------------|--|
| | REVISION / ISSUE | |
| | DATE | |

| SHEET | D | SHEET I | C | | |
|-------|----------|-----------------|--|--|--|
| Ē | DATE: | ELEC | A11 PINI LOT 1, CLEAR LAK | | |
| | JULY | TRIC | PIN PIN TE) | | |
| 무 | Y 23 | ELECTRICAL PLAN | 411 PINE ROAD LOT 1, BLK 1 CLEAR LAKE SHORES TEXAS | | |
| | 23, 2018 | ř Ž | in AD | | |
| | ∞ | | <u>د</u> | | |

ALL WORK SHALL BE IN STRICT COMPLIANCE WITH ALL APPLICABLE WINDSTORM CODES LOCAL BUILDING CODES & ORDINANCES

