


ARCHITECTURAL SOLUTIONS, INC.

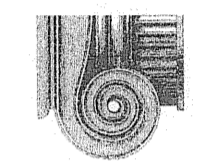

1616 S. Voss, Suite 850
Houston, Texas 77057
Phone: (713)978-6989
Fax: (713)978-7085



DATE: 4-11-06

A Custom Residence for:
Lisa and Tom Gladney

PROJECT ADDRESS:
644 Arlington Street
Houston, Texas 77007

PROJECT NUMBER:
0511103

PLAN NUMBER:
6681

DRAWN BY: BPS
CHECKED BY: LSG

AREA TABULATION	
FIRST FLOOR	4159 S.F.
SECOND FLOOR	2092 S.F.
QUARTERS	430 S.F.
TOTAL LIVABLE AREA	6681 S.F.
GARAGE	760 S.F.
REAR COVERED PORCH	237 S.F.
FRONT COVERED PORCH	1015 S.F.
TOTAL COVERED AREA	8695 S.F.

GENERAL NOTES

- 10'-0" CEILING HEIGHTS AT FIRST FLOOR (U.O.N.)
- 9'-0" CEILING HEIGHTS AT SECOND FLOOR (U.O.N.)
- CARPET FLOORS (U.O.N.)
- WOOD DOUBLE HUNG WINDOWS, AT 8'-0" HEAD HT. @ FIRST FLOOR, 7'-6" @ SECOND FLOOR (U.O.N.)
- 1-3/8" 2-PANEL INTERIOR DOORS. 8'-0" AT FIRST FLOOR, 6'-8" AT SECOND FLOOR (U.O.N.)
- 1-3/4" SOLID CORE EXTERIOR DOORS.
- MECHANICAL ACCESSORIES ARE PROVIDED ON PLAN TO SERVICE MECHANICAL EQUIPMENT ONLY. THE ROUGH OPENING SHALL BE 30" X 24" AND THE STAIR LOAD CAPACITY SHALL BE A MIN. OF 350 POUND CAPACITY, PER IBC M1005.13


BATH SCHEDULE

- TILE FLOORS (U.O.N.)
- TILE WALLS AT TUB ALCOVES TO CEILING.
- TILE FULL AT SHOWERS.
- SYNTHETIC MARBLE DRAIN AND SPLASH (U.O.N.)


FIRST FLOOR PLAN

SCALE: 1/4" = 1'-0"
DATE: APRIL 11, 2006

A1.10

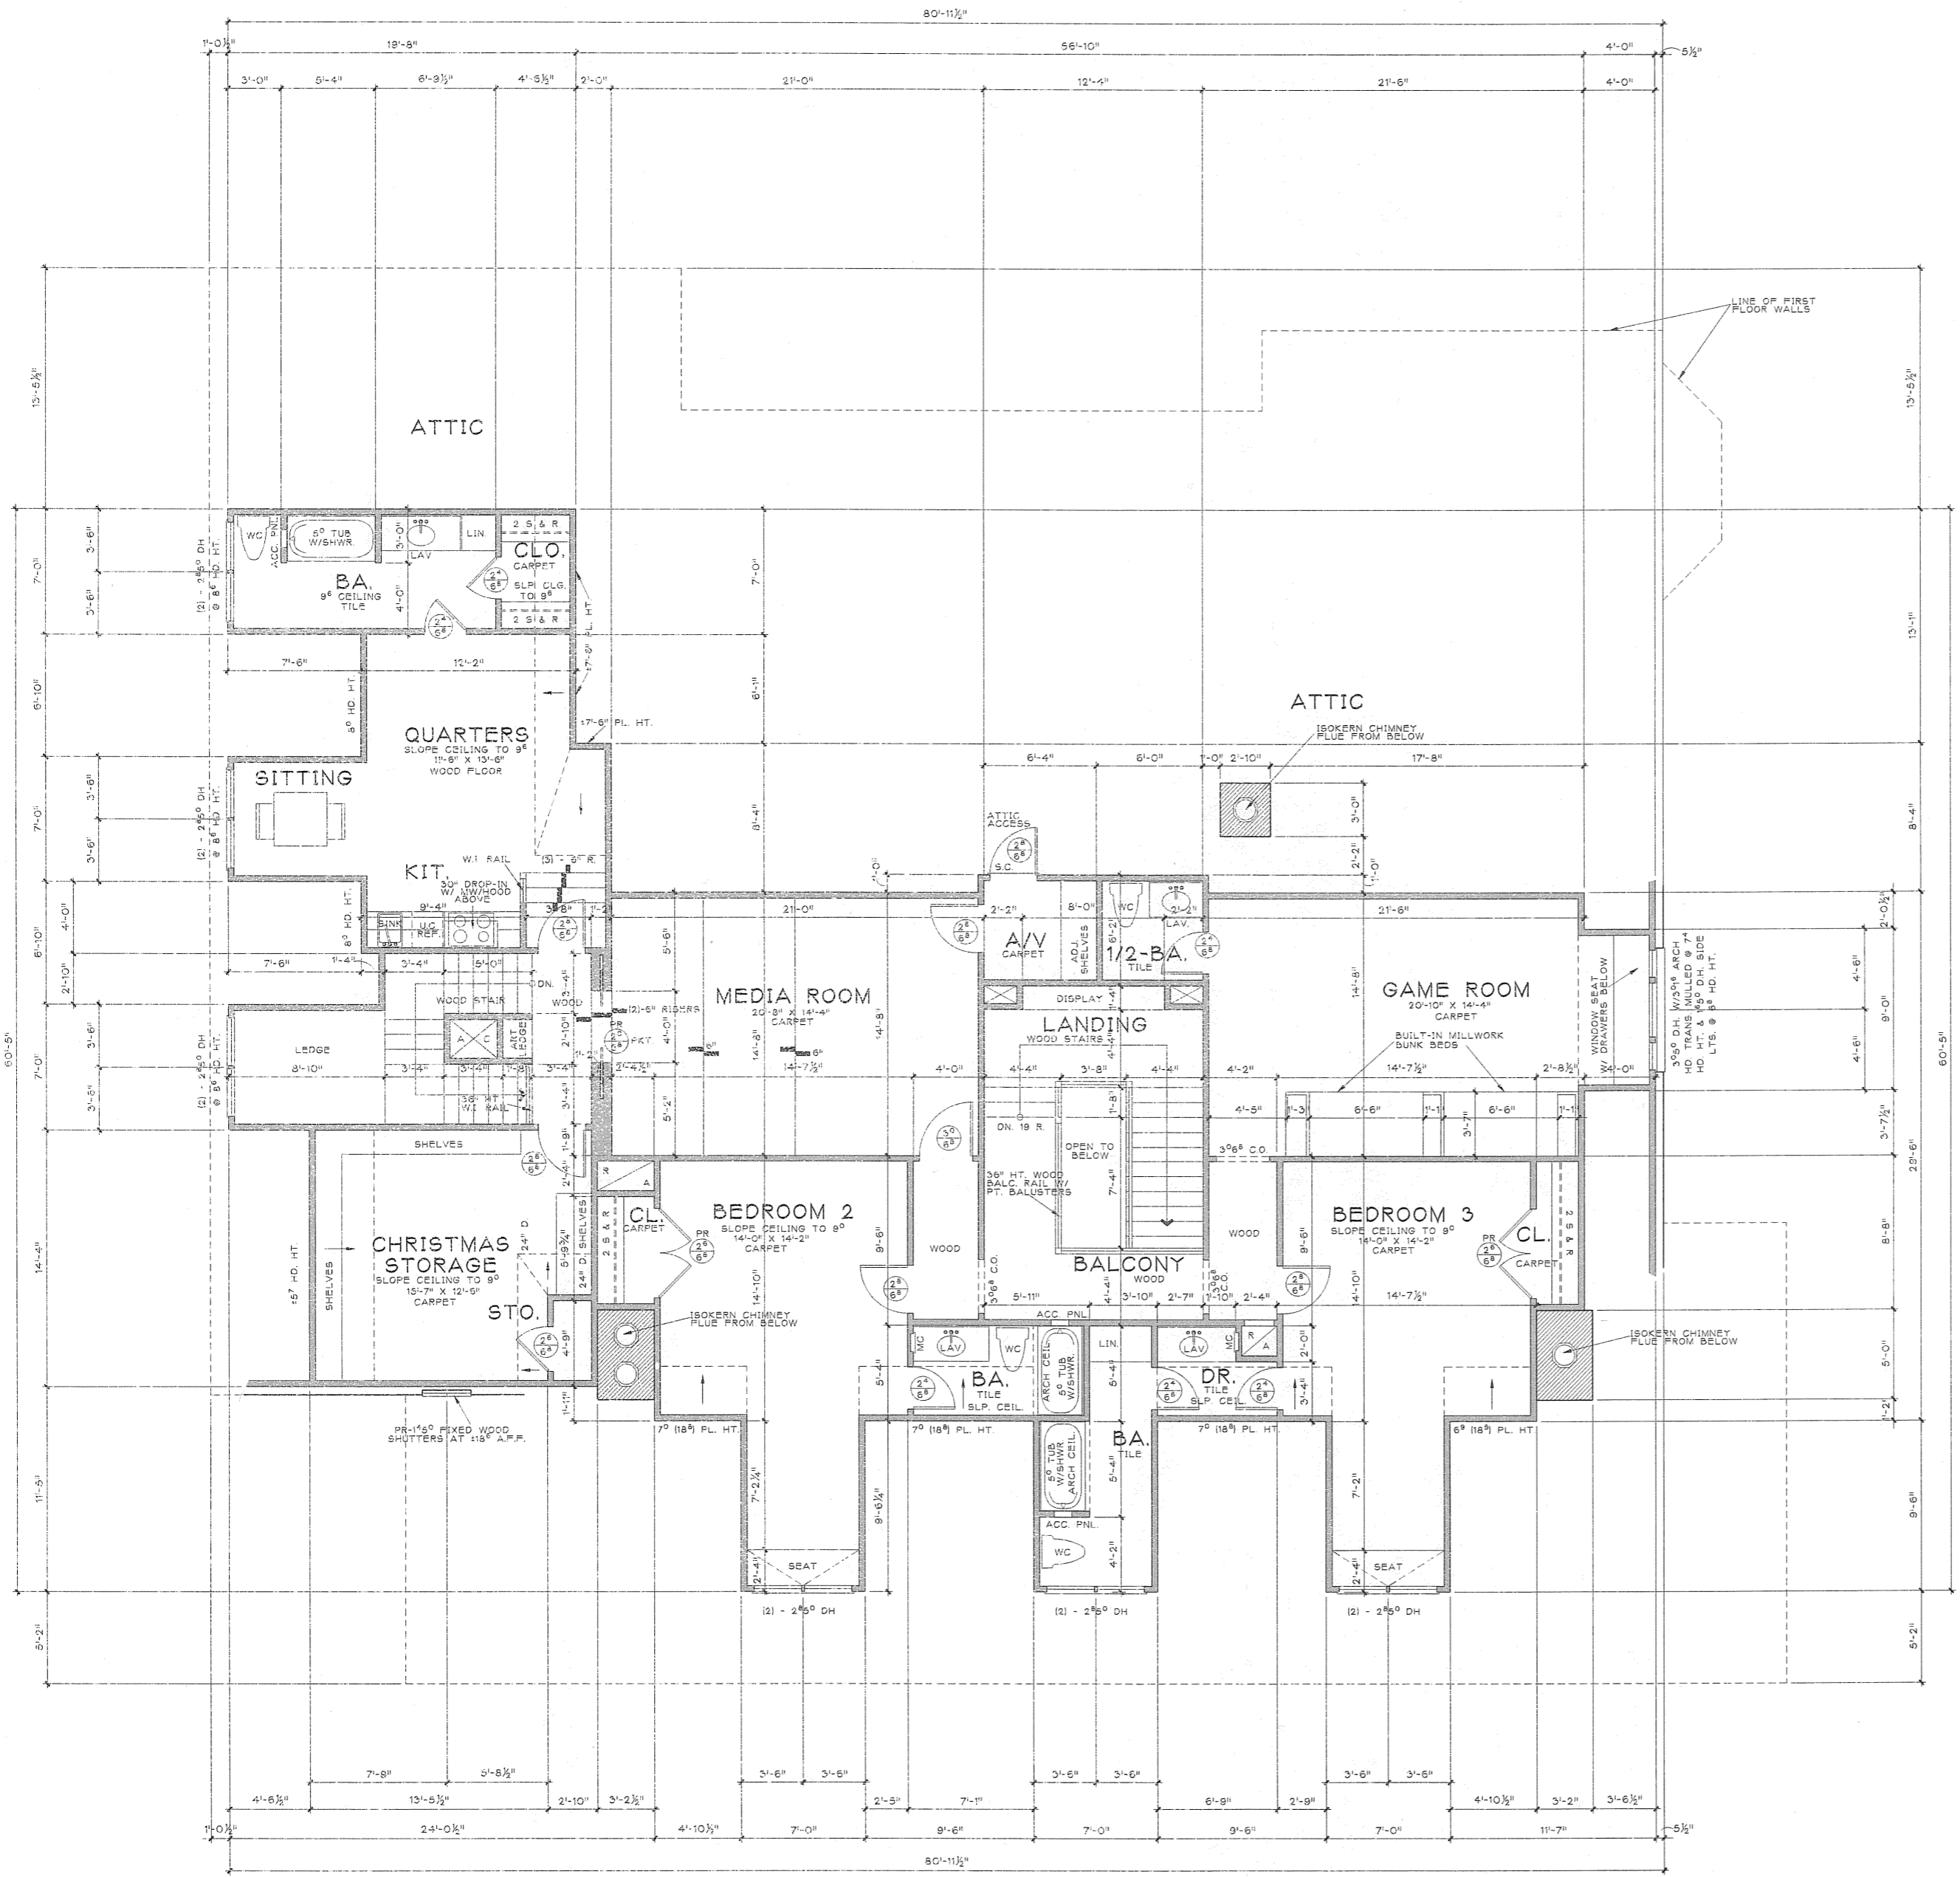

ARCHITECTURAL SOLUTIONS, INC.

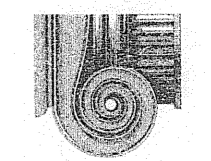

1616 S. Voss, Suite 850
Houston, Texas 77057
Phone: (713)978-6989
Fax: (713)978-7085



DATE: 4-11-06

PROJECT TITLE:
A Custom Residence for:
Lisa and Tom Gladney

PROJECT ADDRESS:
644 Arlington Street
Houston, Texas 77007

PROJECT NUMBER:
051103

PLAN NUMBER:
6681


DRAWN BY: CFC
CHECKED BY: CFC

AREA TABULATION	
FIRST FLOOR	4159 S.F.
SECOND FLOOR	2092 S.F.
QUARTERS	430 S.F.
TOTAL LIVING AREA	6681 S.F.
GARAGE	760 S.F.
REAR COVERED PORCH	227 S.F.
FRONT COVERED PORCH	1915 S.F.
TOTAL COVERED AREA	8693 S.F.

PROJECT TITLE:
SECOND FLOOR PLAN

SCALE:
1/4" = 1'-0"
DATE:
APRIL 11, 2006

A1.20

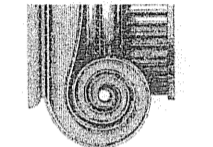

1616 S. Voss, Suite 850
Houston, Texas 77057
Phone: (713)978-6989
Fax: (713)978-7085



DATE: 4-11-06

PROJECT TITLE:
A Custom Residence for
Liso and Tom Gladney

PROJECT ADDRESS:
644 Arlington Street
Houston, Texas 77007

PROJECT NUMBER:
051103

PLAN NUMBER:
6681

DRAWN BY: RJS
CHECKED BY: CBC

AREA TABULATION	SQ. FT.
FIRST FLOOR	4159 S.F.
SECOND FLOOR	2092 S.F.
QUARTERS	430 S.F.
TOTAL LIVING AREA	6681 S.F.
GARAGE	760 S.F.
REAR COVERED PORCH	237 S.F.
FRONT COVERED PORCH	1015 S.F.
TOTAL COVERED AREA	8693 S.F.


SHEET TITLE:
FRONT ELEVATION

SCALE:
1/4" = 1'-0"


DATE:
APRIL 11, 2006

SHEET NUMBER:

A2.10

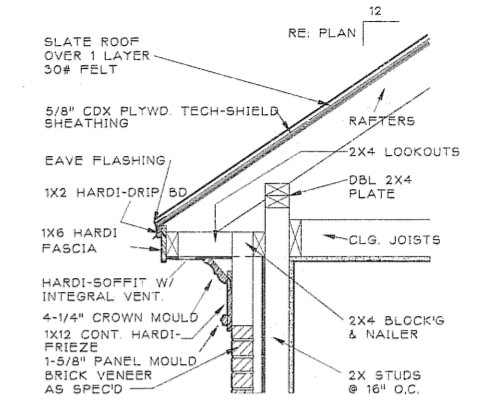


1 TYP. SOFFIT DETAIL
A2.10 SCALE: NONE

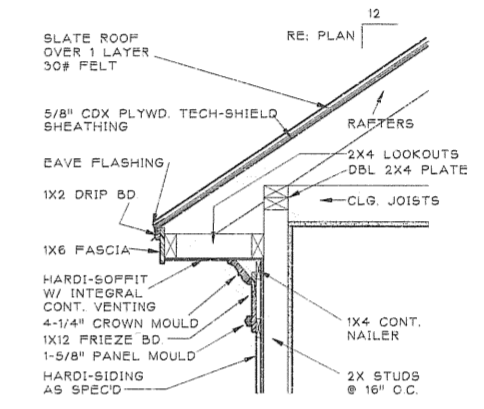

2 TYP. SOFFIT DETAIL
A2.10 SCALE: NONE



FRONT ELEVATION

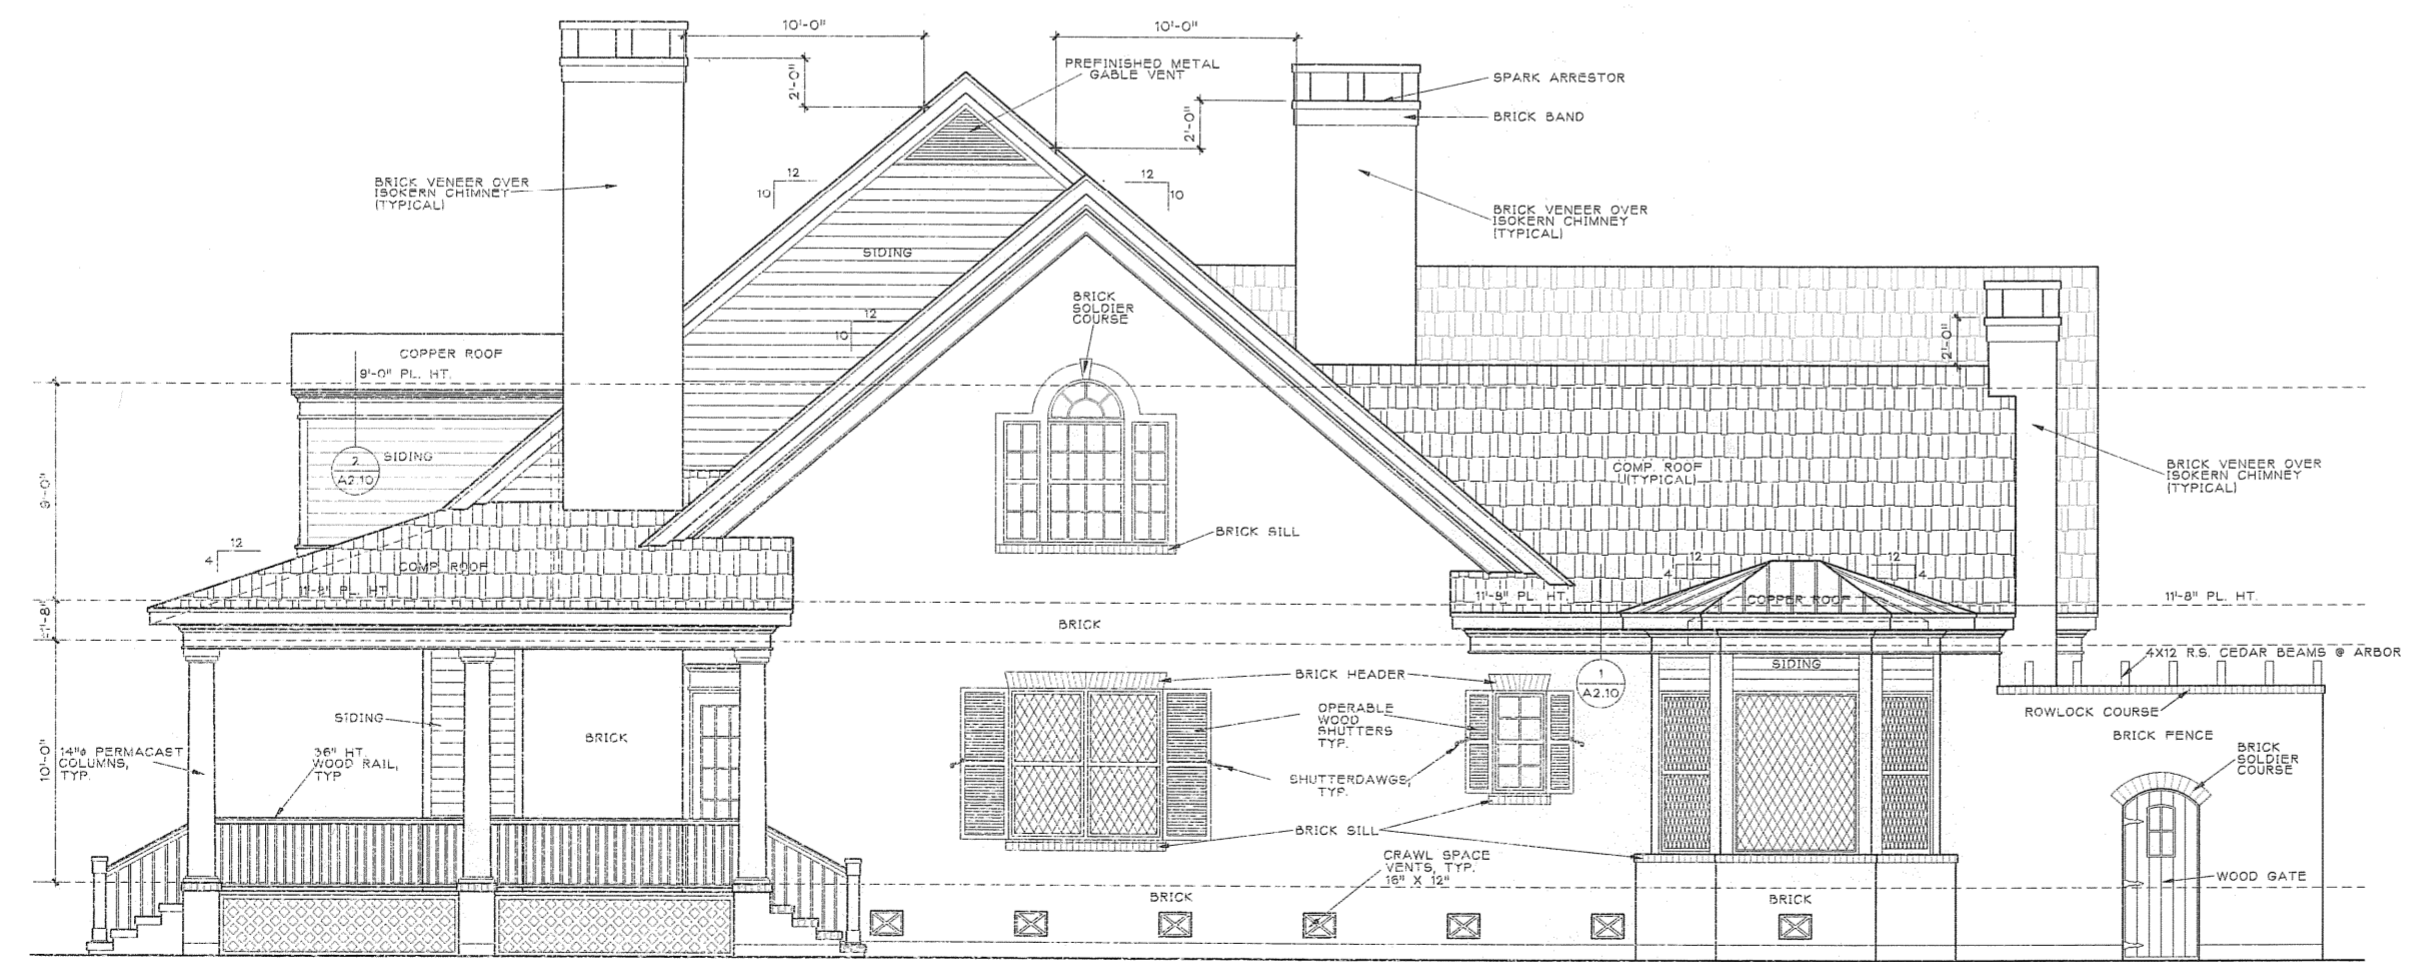

RIGHT SIDE ELEVATION

FLOOD VENT CALCULATIONS

760 S.F. BLDG. AREA SUBJECT TO FLOODING X 1 SQ. IN. / 1 S.F. = 760 SQ. INCHES OF FLOOD VENTING REQ'D.
8 VENTS @ 92 SQ. IN. EA X 75 % EFFICIENCY = 684 SQ. INCHES OF FLOOD VENTING PROVIDED.

CRAWL SPACE VENTILATION

4396 S.F. CRAWL SPACE AREA X 1 S.F. / 150 S.F. = 29.31 S.F. CRAWL SPACE VENTILATION REQ'D.
30 VENTS @ 133 SQ. IN. EA X 75 % EFFICIENCY = 30 S.F. CRAWL SPACE VENTILATION PROVIDED.
IN ADDITION, PROVIDE 2 EXTERIOR & 1 INTERIOR 18\"/>

TOTAL FLOOD AND CRAWL SPACE VENTS PROVIDED = 5472 SQ. INCHES (FREE AREA)
TOTAL FOUNDATION FOOTPRINT = 5156 S.F.

ELEVATION NOTES

- ALL PLATE HEIGHTS MEASURED ABOVE FIRST FLOOR
- OVERHANGS TO BE 1/2\"/>

