

PROPOSED SITE

**LOCATION MAP** N.T.S.

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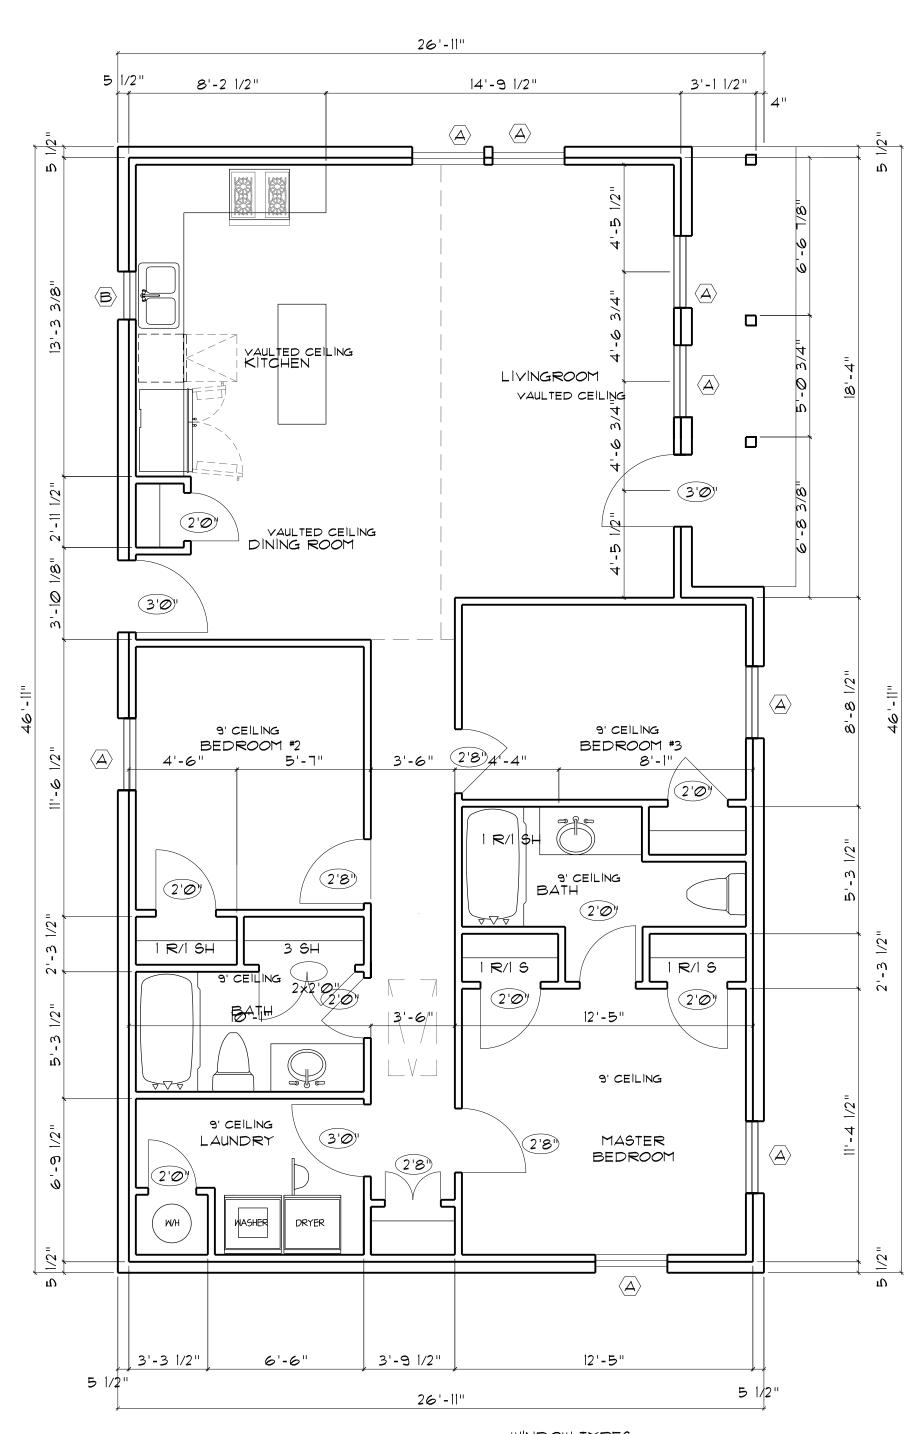
SITE PLAN 1"= 20'-0"

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JOB NUMBER LM-090620A

SHEET NUMBER **A0** 

DATE OF ORIGINAL ISSUE 09/11/20



AREAS

TOTAL LIVING AREA

1,206 SQFT

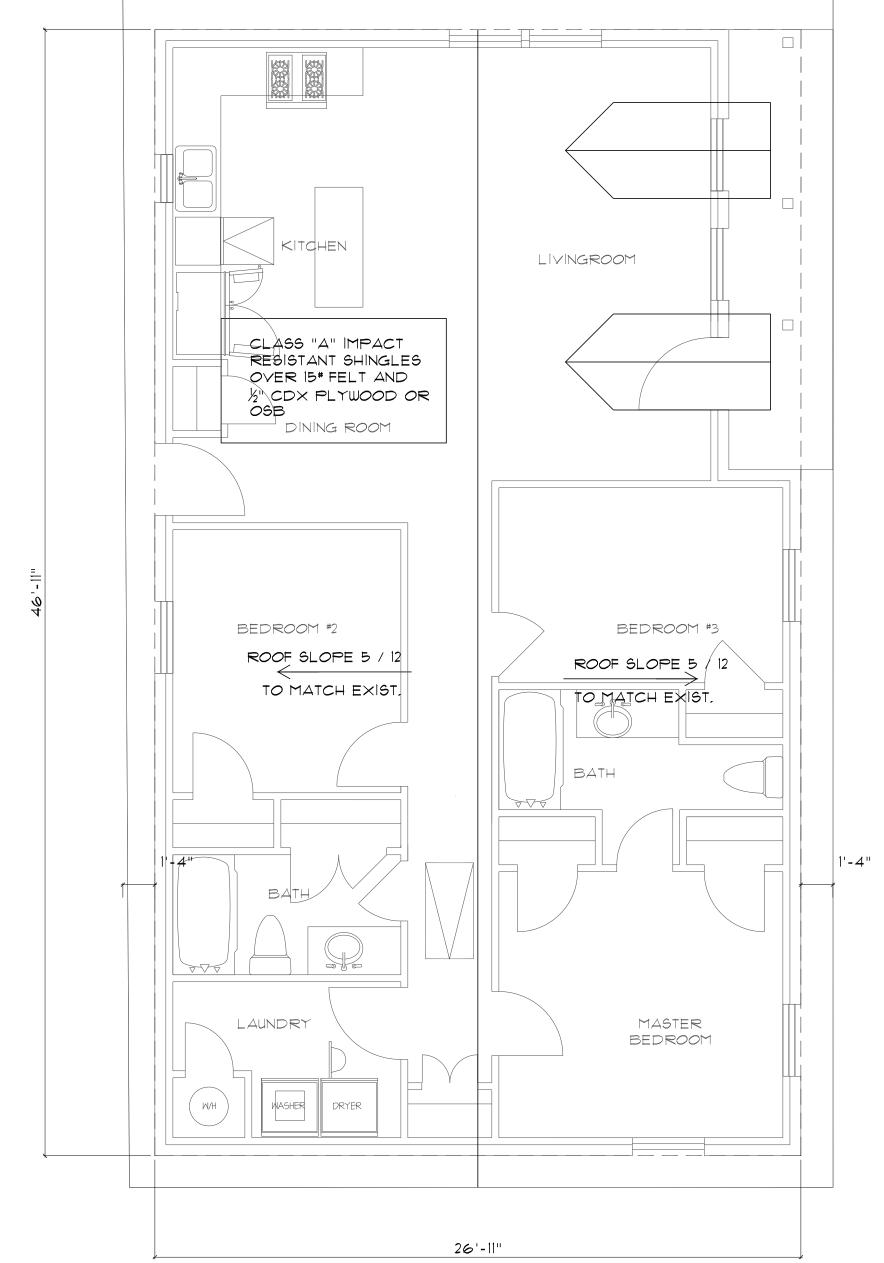
PORCH

63 SQFT

1,269 SQFT

1,269 SQFT

3'X2' SINGLE HUNG INSULATED LOW E GLASS CLEAR/ CLEAR U FACTOR = .45 SHGC = .28



## **ROOFING NOTES:**

- 1. ALL ROOF PITCHES SHALL BE 5 / 12 UNLESS NOTED OTHERWISE
- 2. ROOFING SHALL BE AS SELECTED BY THE OWNER
  3. FINISH POOFING MATERIAL SHALL BE INSTALLED OVER
- 3. FINISH ROOFING MATERIAL SHALL BE INSTALLED OVER
- 30# FELT AND  $\frac{1}{2}$ " PLYWOOD OR OSB DECK 4. ALL ROOF OVERHANGE SHALLBE 1'-4"





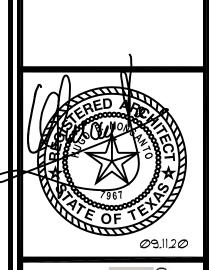
CONTRACTOR SHALL VERIFY ALL CONDITIONS AND DIMENSIONS AT THE JOB SITE AND NOTIFY THE ARCHITECT OF ANY DIMENSIONAL ERRORS, OMISSION BEFORE FABRICATING ANY WORK.

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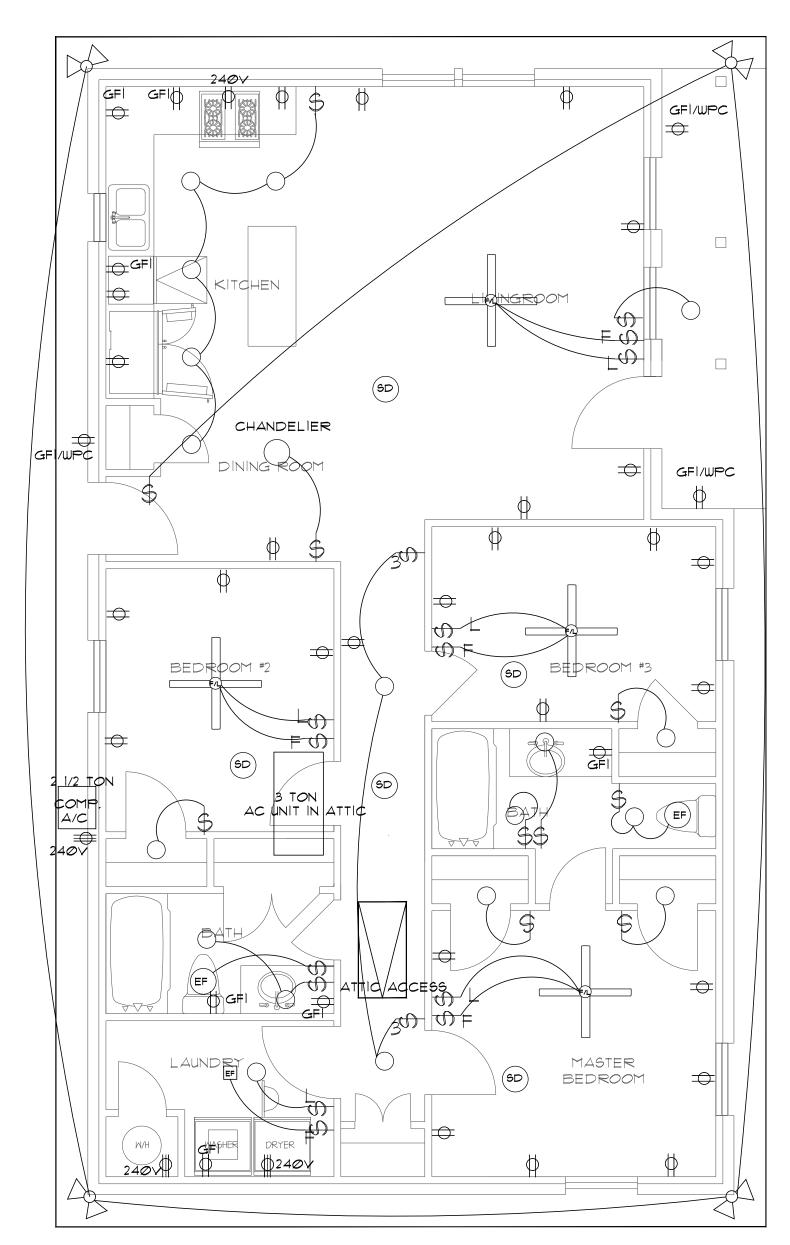
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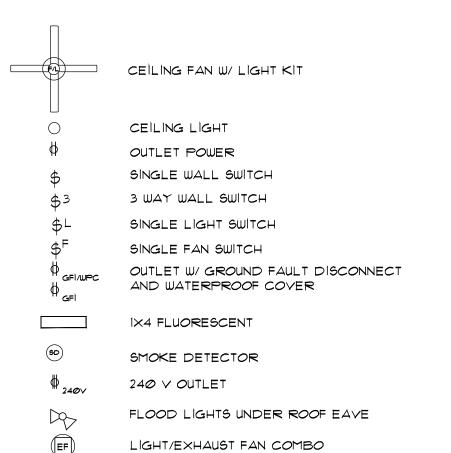


# **ELECTRICAL NOTES:**

- 1. ALL ELECTRICAL WORK SHALL BE DONE ACCORDING TO THE LATEST EDITION OF THE N.E.C.
- 2. PROVIDE UNDER THE COUNTER J BOXES FOR RANGE, DISHWASHER AND DISPOSAL
- 3. PROVIDE GFI OUTLETS IN ALL ELECTRICAL OUTLETS NEAR A SINK OR A WET LOCATION
- 4. ALL LIGHT FIXTURES SHALL BE UL APPROVED
- 5. PROVIDE WATERPROOF COVERS FOR ALL EXTERIOR OUTLETS
- 6. PROVIDE BUTTON, BELL AND CHIMES AT FRONT DOOR 1. VERIFY WATER HEATER AND HVAC BEFORE CONSTRUCTION
- STARTS
- 8. CENTER EACH LIGHT FIXTURE IN EACH ROOM

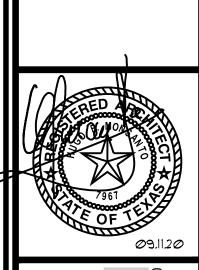


# **ELECTRICAL SYMBOLS:**



1. ALL ELECTRICAL WORK SHALL CONFORM TO THE LOCAL BUILDING CODE, ORDINANCES AND TO THE NEC.

NOTES:



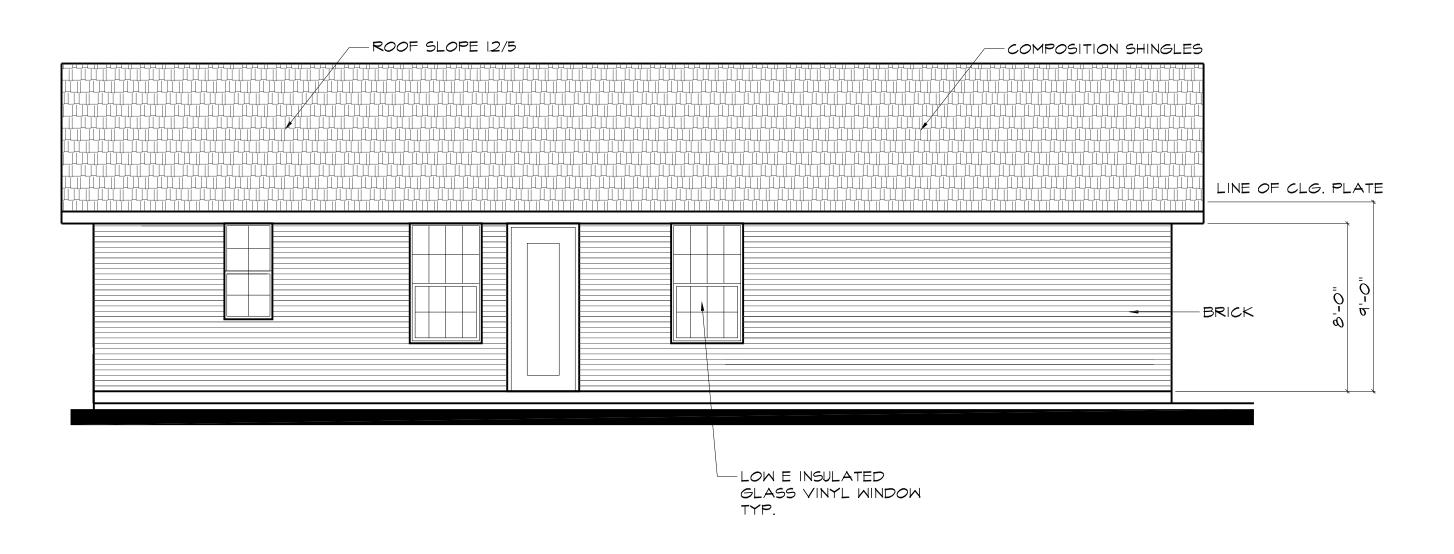
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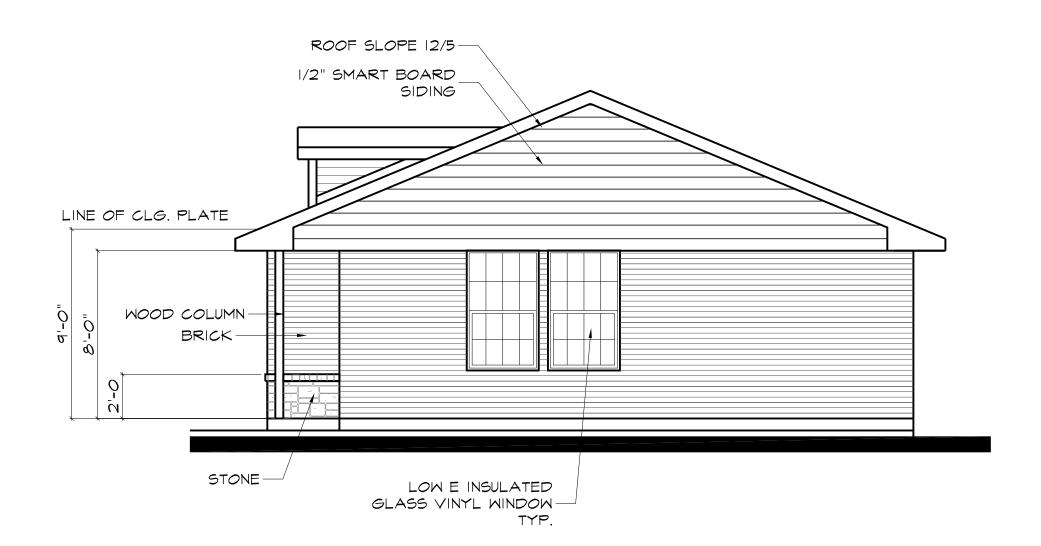
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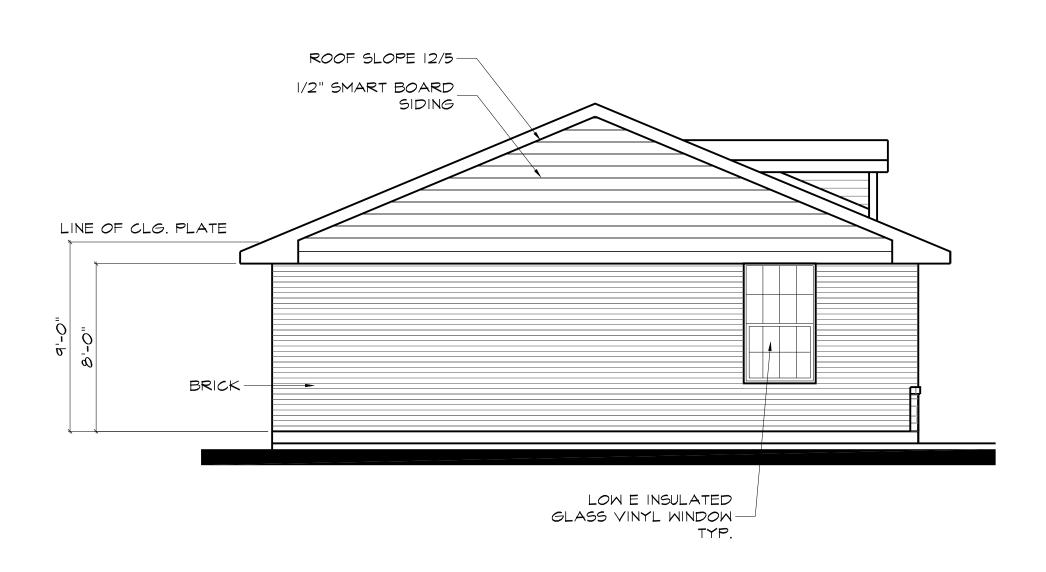
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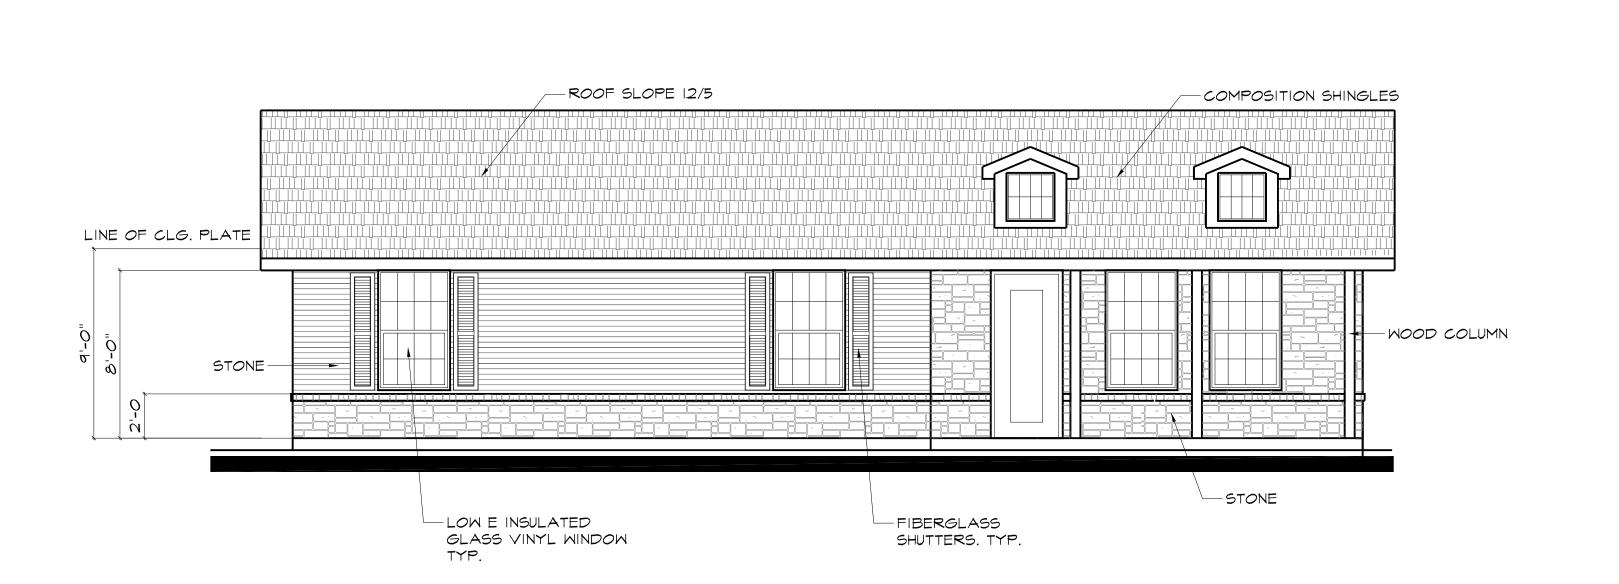
REAR ELEVATION
1/4" = 1'-0"



LEFT SIDE ELEVATION
1/4" = 1'-0"



RIGHT SIDE ELEVATION
1/4" = 1'-0"



FRONT ELEVATION 1/4" = 1'-0"

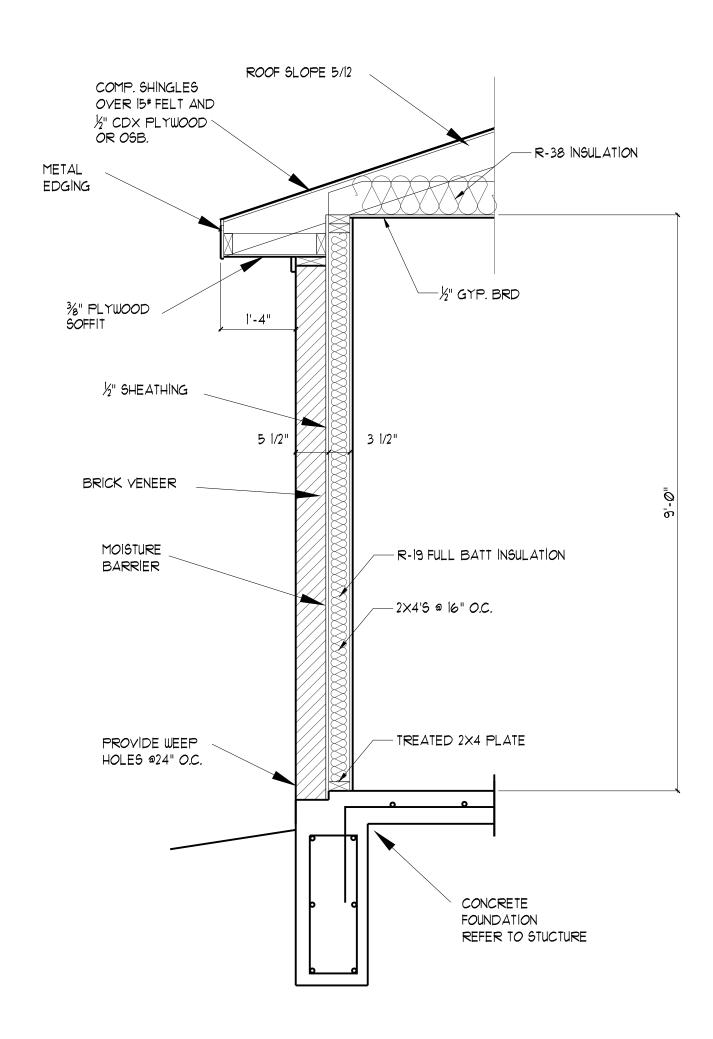
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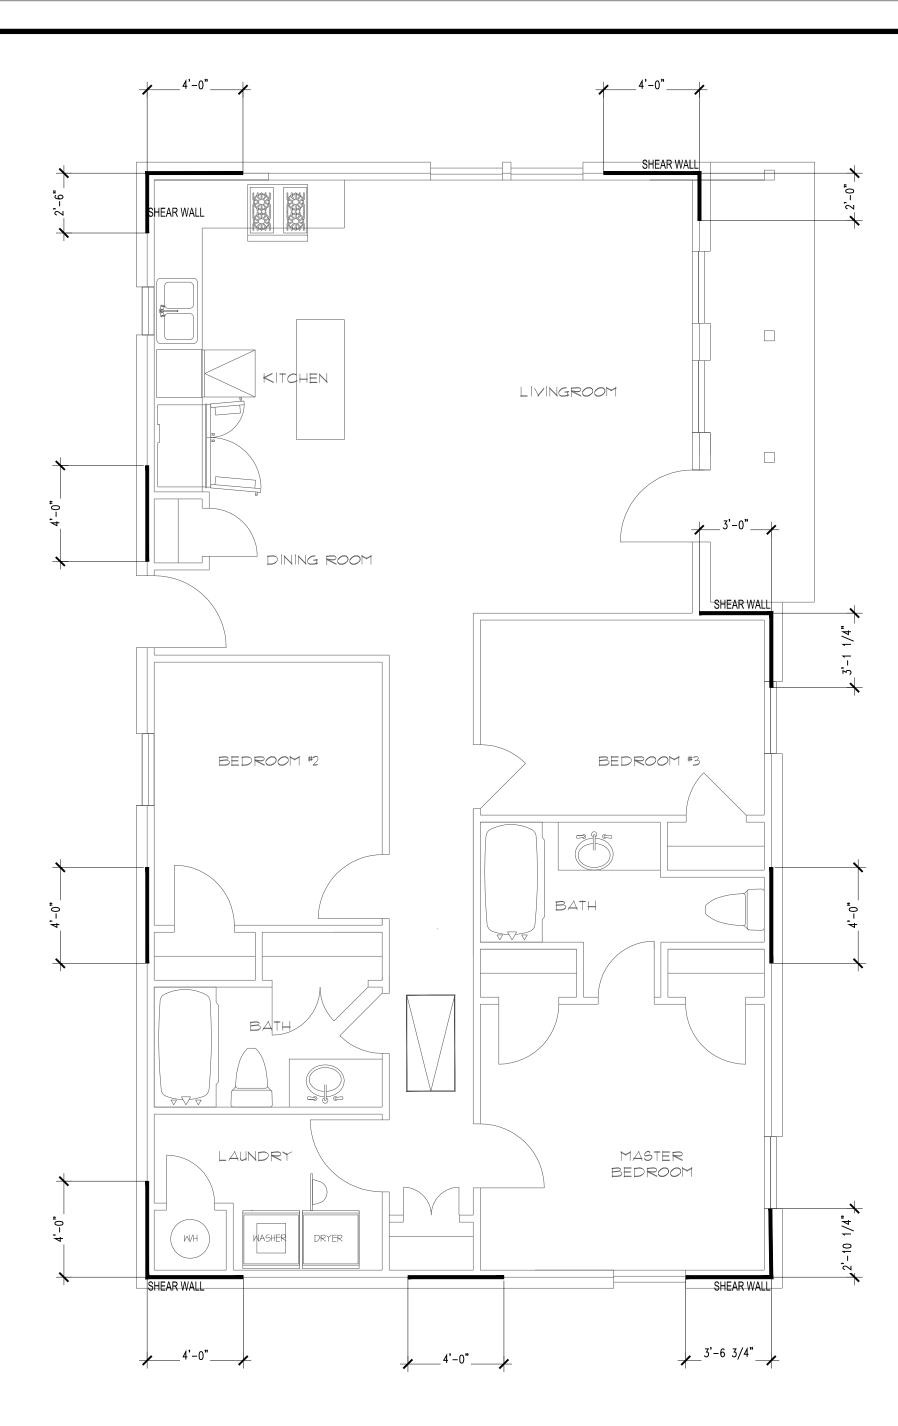
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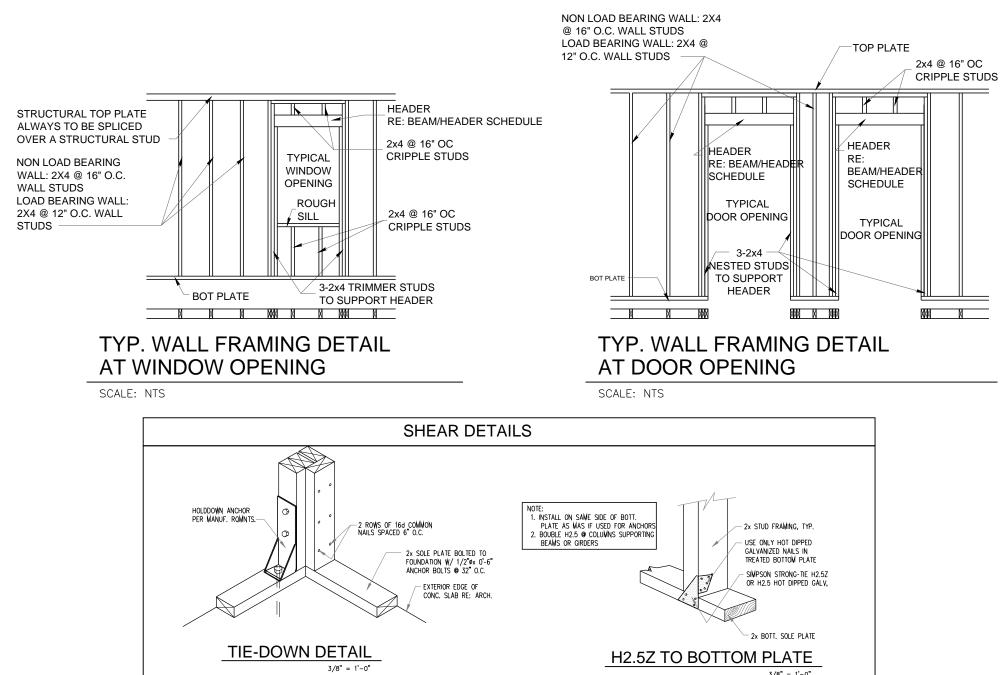


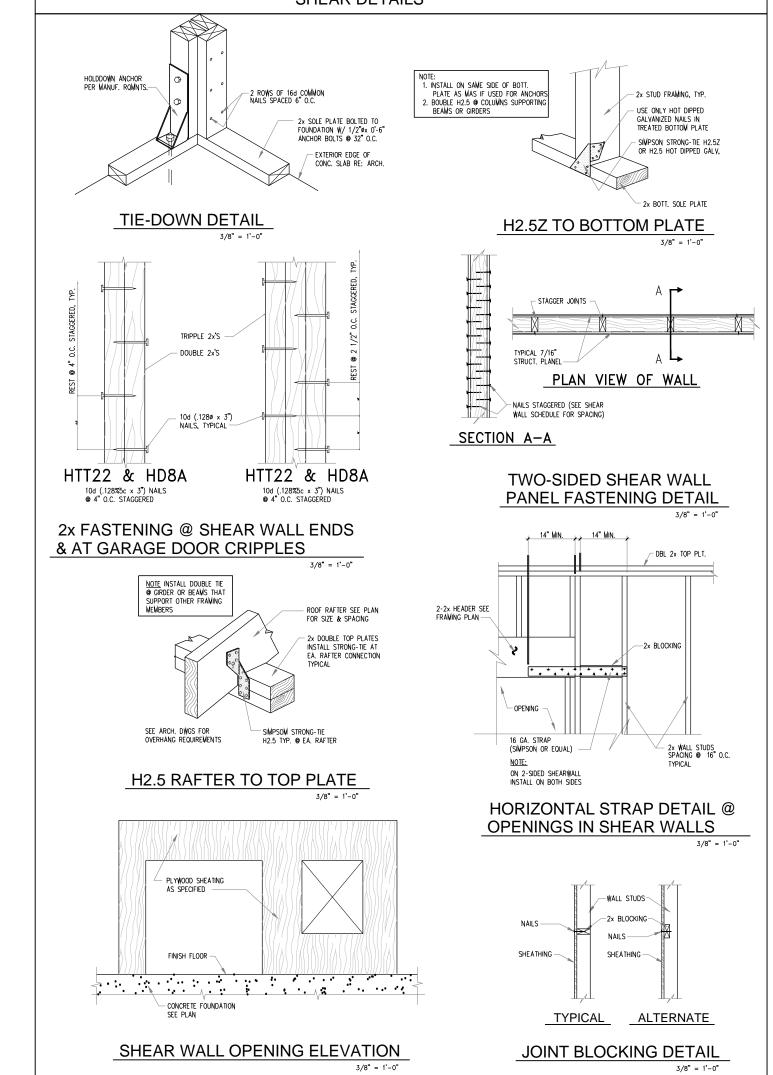
# SHEAR WALL NOTES

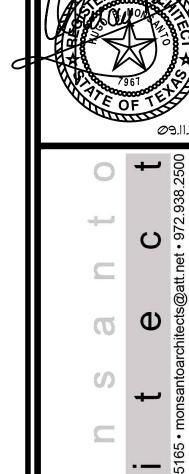
- 1. REFER TO SHEET A.4 FOR TIE-DOWNS AND SHEAR WALL DETAILS. 2. ALL SHEAR WALLS TO BE CONSTRUCTED WITH 1 LAYER OF 7/16" APA RATED
- SHEATHING EXP. I W/ 8d NAILS @ 6" O.C. ALL EDGES.
- 3. DOUBLE 2x4/2X6 STUDS SHALL BE INSTALLED AT THE END OF EACH SHEAR WALL 4. FOR ALL SHEAR WALLS, USE SIMPSON HOLD DOWN 5/8" HTT16 EMBEDDED 12" W/ SSTB16 ANCHOR BOLTS.
- 5. APPLICABLE CODE: 2009 IRC W/ AMENDMENTS AND DELETIONS ORD 12-020



SHEAR WALLS 1/4" = 1'-0"





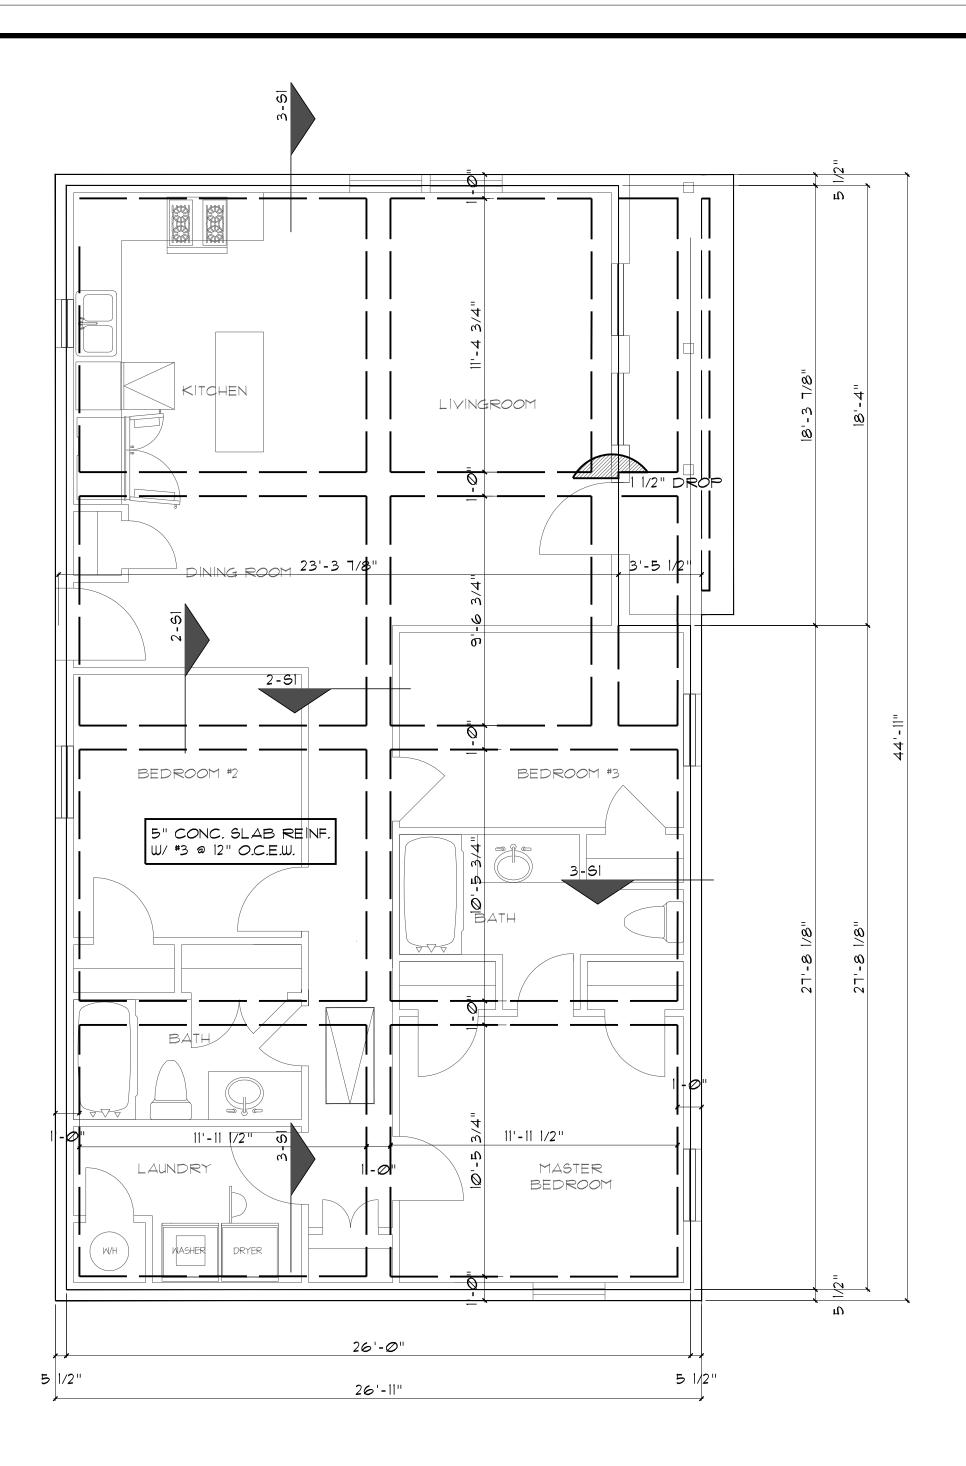


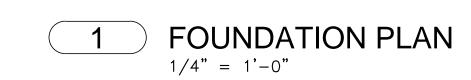
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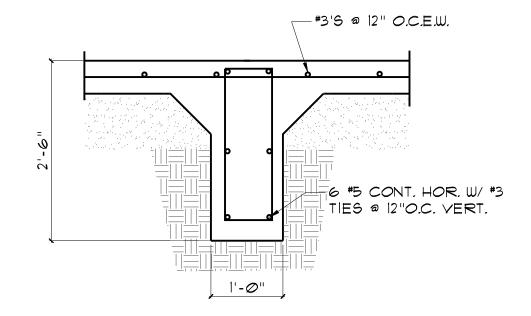
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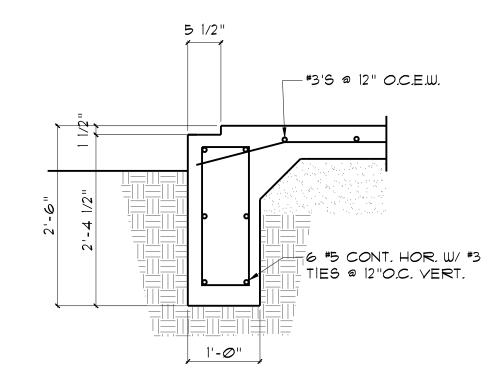


## REINFORCED CONCRETE

- ALL DETAILING, FABRICATION AND PLACING OF REINFORCING STEEL SHALL CONFORM TO THE "MANUAL OF STANDARD PRACTICE FOR DETAILING REINFORCED CONCRETE STRUCTURES", ACI 315, UNLESS OTHERWISE NOTED.
- ALL CONCRETE SHALL DEVELOP A MINIMUM 28 DAYS WORKING STRENGTH OF 3500 PSI, UNLESS NOTED OTHERWISE.
- 3. ALL REINFORCING STEEL SHALL MEET ASTM A-615, GRADE 60, SPECIFICATIONS.
- 4. ALL SLABS AND CORRESPONDING BEAMS, CURBS OR APRONS SHALL BE POURED MONOLITHICALLY.
- ALL LAPING, BENDING AND PLACING OF REINFORCEMENT SHALL BE DONE IN ACCORDANCE WITH ACI
   318 BUILDING CODE.
- 6. THE CONTRACTOR SHALL TAKE PRECAUTIONS TO PRODUCE CORRECTLY ALIGNED CONCRETE CONSIDERING AMONG OTHER THINGS, THE ELASTIC DEFORMATION OF THE STRUCTURAL MEMBERS.



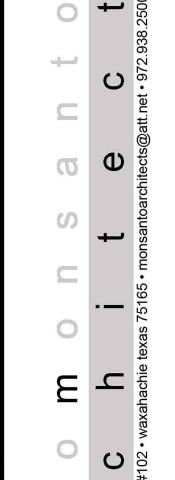
2 INTERIOR GRADE BEAM DETAIL
3/4" = 1'-0"



3 PERIMETER GRADE BEAM DETAIL

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