Mark	WIDTH	HEIGHT	Hand	Hardware	COMMENTS
102	16'-0''	8'-0''			OVERHEAD GARAGE DOOR
103	3'-0"	8'-0''	RIGHT	DEADBOLT/LOCKSET	TEMPERED/THRESHOLD / WEATHERSTRIF
104	2'-8''	8'-0''	RIGHT	DEADBOLT/LOCKSET	
105	2'-0"	8'-0''	LEFT	Passage	
106	2'-8''	8'-0''	RIGHT	Passage	
108	2'-8''	8'-0''	RIGHT	PRIVACY	
109	2'-0''	8'-0''	LEFT	Passage	
110	2'-0''	8'-0''	LEFT	PRIVACY	
202a	2'-0''	8'-0''	RIGHT	PRIVACY	
202в	2'-0''	8'-0''			
203	2'-8''	8'-0''	RIGHT	Passage	
205	2'-0''	8'-0''	RIGHT	Passage	
302	2'-8''	8'-0''	RIGHT	Passage	
303	2'-8''	8'-0''	RIGHT	PRIVACY	
304	2'-0''	8'-0''	LEFT	PRIVACY	
305	2'-0''	8'-0''	RIGHT	Passage	
306	2'-8''	8'-0''			CASED OPENING
307	2'-0''	8'-0''	LEFT	Passage	
308	5'-0''	8'-0''			
309	3'-0"	8'-0''	Double	Passage	
310a	2'-8''	8'-0''	LEFT	PRIVACY	
310в	2'-8''	8'-0''			CASED OPENING
311	2'-0''	8'-0''	RIGHT	PRIVACY	
312	2'-0''	7'-0''	RIGHT	Passage	TEMPERED SHOWER DOOR
313	2'-0''	8'-0''	RIGHT	PRIVACY	
402	2'-8''	8'-0''	RIGHT	Passage	
403	3'-0''	5'-0''	RIGHT	Passage	
404	3'-0''	5'-0''	RIGHT	DEADBOLT/LOCKSET	THRESHOLD / WEATHERSTRIP
405	3'-0"	8'-0"	RIGHT	DEADBOLT/LOCKSET	TEMPERED/THRESHOLD / WEATHERSTRIF
406	6' - 10''	8'-0"			

3 Second Floor Plan 1/4" = 1'-0"

			V	VINDOW SC	CHEDULE	
N /	Llerore	14/	SILL	HEAD	0==========	C 0.1 11 11 11 11 11 11 11 11 11 11 11 11 1
Mark	HEIGHT	Width	HEIGHT	HEIGHT	OPERATION	COMMENTS
101	5' - 6''	3'-0''	5' - 9''	11'-3"	FIXED	TEMPERED (HEADER/SILL HT FROM 1ST FLR)
102	5'-0''	3'-0''	3'-0''	8' - 0''	SINGLE HUNG	Egress
103	5' - 0''	3'-0''	3'-0''	8' - 0''	SINGLE HUNG	Egress
201	6' - 6''	4' - O''	1'-6''	8' - 0''	FIXED	
202	6' - 6''	3'-0''	1'-6''	8' - 0''	FIXED	
203	6' - 6''	4' - 0''	1'-6''	8' - 0''	FIXED	
204	6' - 0''	3'-0''	2'-0''	8' - 0''	SINGLE HUNG	
205	6' - 0''	3'-0''	2'-0"	8' - 0''	SINGLE HUNG	
206	6' - 0''	3' - O''	2'-0"	8' - 0''	SINGLE HUNG	
207	6' - 0''	3'-0"	2'-0''	8' - 0''	SINGLE HUNG	
208	5' - 6''	3'-0"	9' - 6''	15'-0''	FIXED	TEMPERED (HEADER/SILL HT FROM 1ST FLR)
209	5' - 6''	3' - 0''	17'-8''	23' - 2''	FIXED	TEMPERED (HEADER/SILL HT FROM 1ST FLR)
301	6' - 0''	2' - 6''	3'-0"	9' - 0''	FIXED	
302	6'-0''	2' - 6''	3'-0"	9' - 0''	Fixed	
303	6'-0''	2'-8''	3'-0"	9' - 0''	SINGLE HUNG	Egress
304	6'-0''	2'-8''	3'-0"	9' - 0''	SINGLE HUNG	Egress
305	6'-0''	2' - 6''	3'-0"	9' - 0''	FIXED	Tempered
306	6' - 0''	2'-6''	3'-0"	9' - 0''	FIXED	Tempered
307	1'-6''	3'-0''	7'-6''	9' - 0''		
308	1'-6''	3'-0"	7'-6''	9' - 0''		
309	5' - 6''	3'-0"	21'-6"	27' - 0''	FIXED	TEMPERED (HEADER/SILL HT FROM 1ST FLR)
310	5' - 6''	3'-0''	29' - 7''	35' - 1''	FIXED	TEMPERED (HEADER/SILL HT FROM 1ST FLR)
311	6' - 0''	3' - 0''	2'-0"	8' - 0''	SINGLE HUNG	Egress
312	6' - 0''	3'-0"	2'-0"	8' - 0''	SINGLE HUNG	Egress
401	5' - 6''	3'-0"	33' - 6"	39' - 0''	Fixed	TEMPERED (HEADER/SILL HT FROM 1ST FLR)

EMERGENCY ESCAPE AND RESCUE OPENINGS

1. Basements and every sleeping room shall have at least one operable emergency escape and rescue opening. 2. Where emergency escape and rescue openings are provided they shall have a sill height of not more than 44 inches above the floor.

3. ALL EMERGENCY ESCAPE AND RESCUE OPENINGS SHALL HAVE A MINIMUM NET CLEAR OPENING OF 5.7 SQUARE FEET. EXCEPTION: GRADE FLOOR OPENINGS SHALL HAVE A MINIMUM NET CLEAR OPENING OF 5 SQUARE FEET.

4. THE MINIMUM NET CLEAR OPENING HEIGHT SHALL BE 24 INCHES. 5. THE MINIMUM NET CLEAR OPENING WIDTH SHALL BE 20 INCHES.


6. EMERGENCY ESCAPE AND RESCUE OPENINGS SHALL BE OPERATIONAL FROM THE INSIDE OF THE ROOM WITHOUT THE USE OF KEYS, TOOLS OR SPECIAL KNOWLEDGE.

Name	AREA
1st Floor	456 SF
2nd Floor	884 SF
3rd Floor	946 SF
4th Floor	165 SF
FLOOR AREA	2451 SF
2nd Floor Balcony	Not
	PLACED
A/C DECK	99 SF
Garage	362 SF
МЕСН ROOM	210 SF
ROOFTOP DECK	410 SF
Exterior Area	1080 SF
GRAND TOTAL	3531 SF

AREA SCHEDULE

Name	AREA	1/2	
ST FLOOR	456 SF	J	
ID FLOOR	884 SF	-	
RD FLOOR	946 SF	3	
H FLOOR	165 SF	2	
OOR AREA	2451 SF	14:	
		20	land Planning
ID FLOOR BALCONY	Not	10	5
	PLACED		5
C Deck	99 SF		7
ARAGE	362 SF	- 0	-
ECH ROOM	210 SF	7	
OOFTOP DECK	410 SF	<i>"</i>	_
TERIOR AREA	1080 SF	02	7
RAND TOTAL	3531 SF	1/0	Commercial
		2).	5.
		6.0	
		1/1/2	
		$\mathcal{M}(\mathcal{U})$	i+
		\bigcirc	sidentia
			Sic



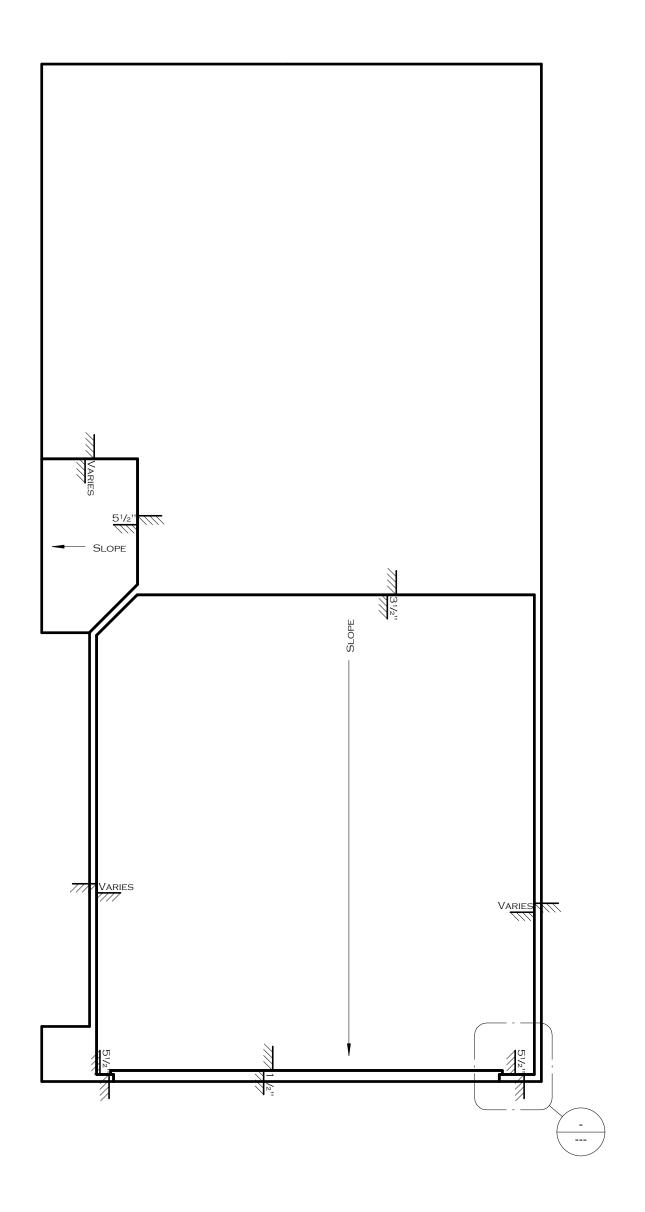

Anno-Foundation
1/4" = 1'-0"


Last Modified: 11/24/2015 1:06:39 PM Last Plot:
C:Uberti/RickDroptox (RSDesigns)/RSDesigns Team Folder/RSDI - 2019;2015.0012 - Nicholson Townhomes/Drawingsi/13 Nicholson Plan Buvt Job Number: 2015-0012 Floor Plans


NICHOL

 \mathfrak{C}

A1.1



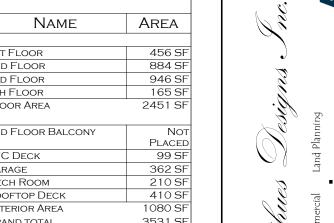

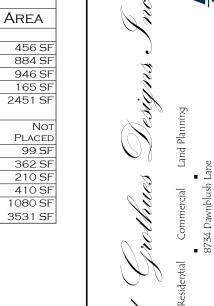



NICH

Last Modified: 11/24/2015 1:06:40 PM Last Plot:
C:\Users\Fick\Droptox (RGDesigns)RGDesigns Team Folder\RGDI - 2019;2015.0012 - Nicholson Townhomes\Drawings\713 Nicholson Plan
B.rvt 2015-0012 Floor Plans

A1.2



13 NICHOL NICHO

mercial Land Planning
wmblush Lane
nn, TX 77095
1991 Fax: 743.893.6901
Intesdesigns.com


Sheet Number:

Last Modified: 11/24/2015 1:06:44 PM

Last Plot:
CilbergReidburgton (ROSsegge)ROSsegger Ferrir Felder ROSt. 2015/2015 0012 - Heindelson Toerformer Elbaurger/13 Nicholson Plan
Brit

Job Number:
2015-0012

Building Elevations

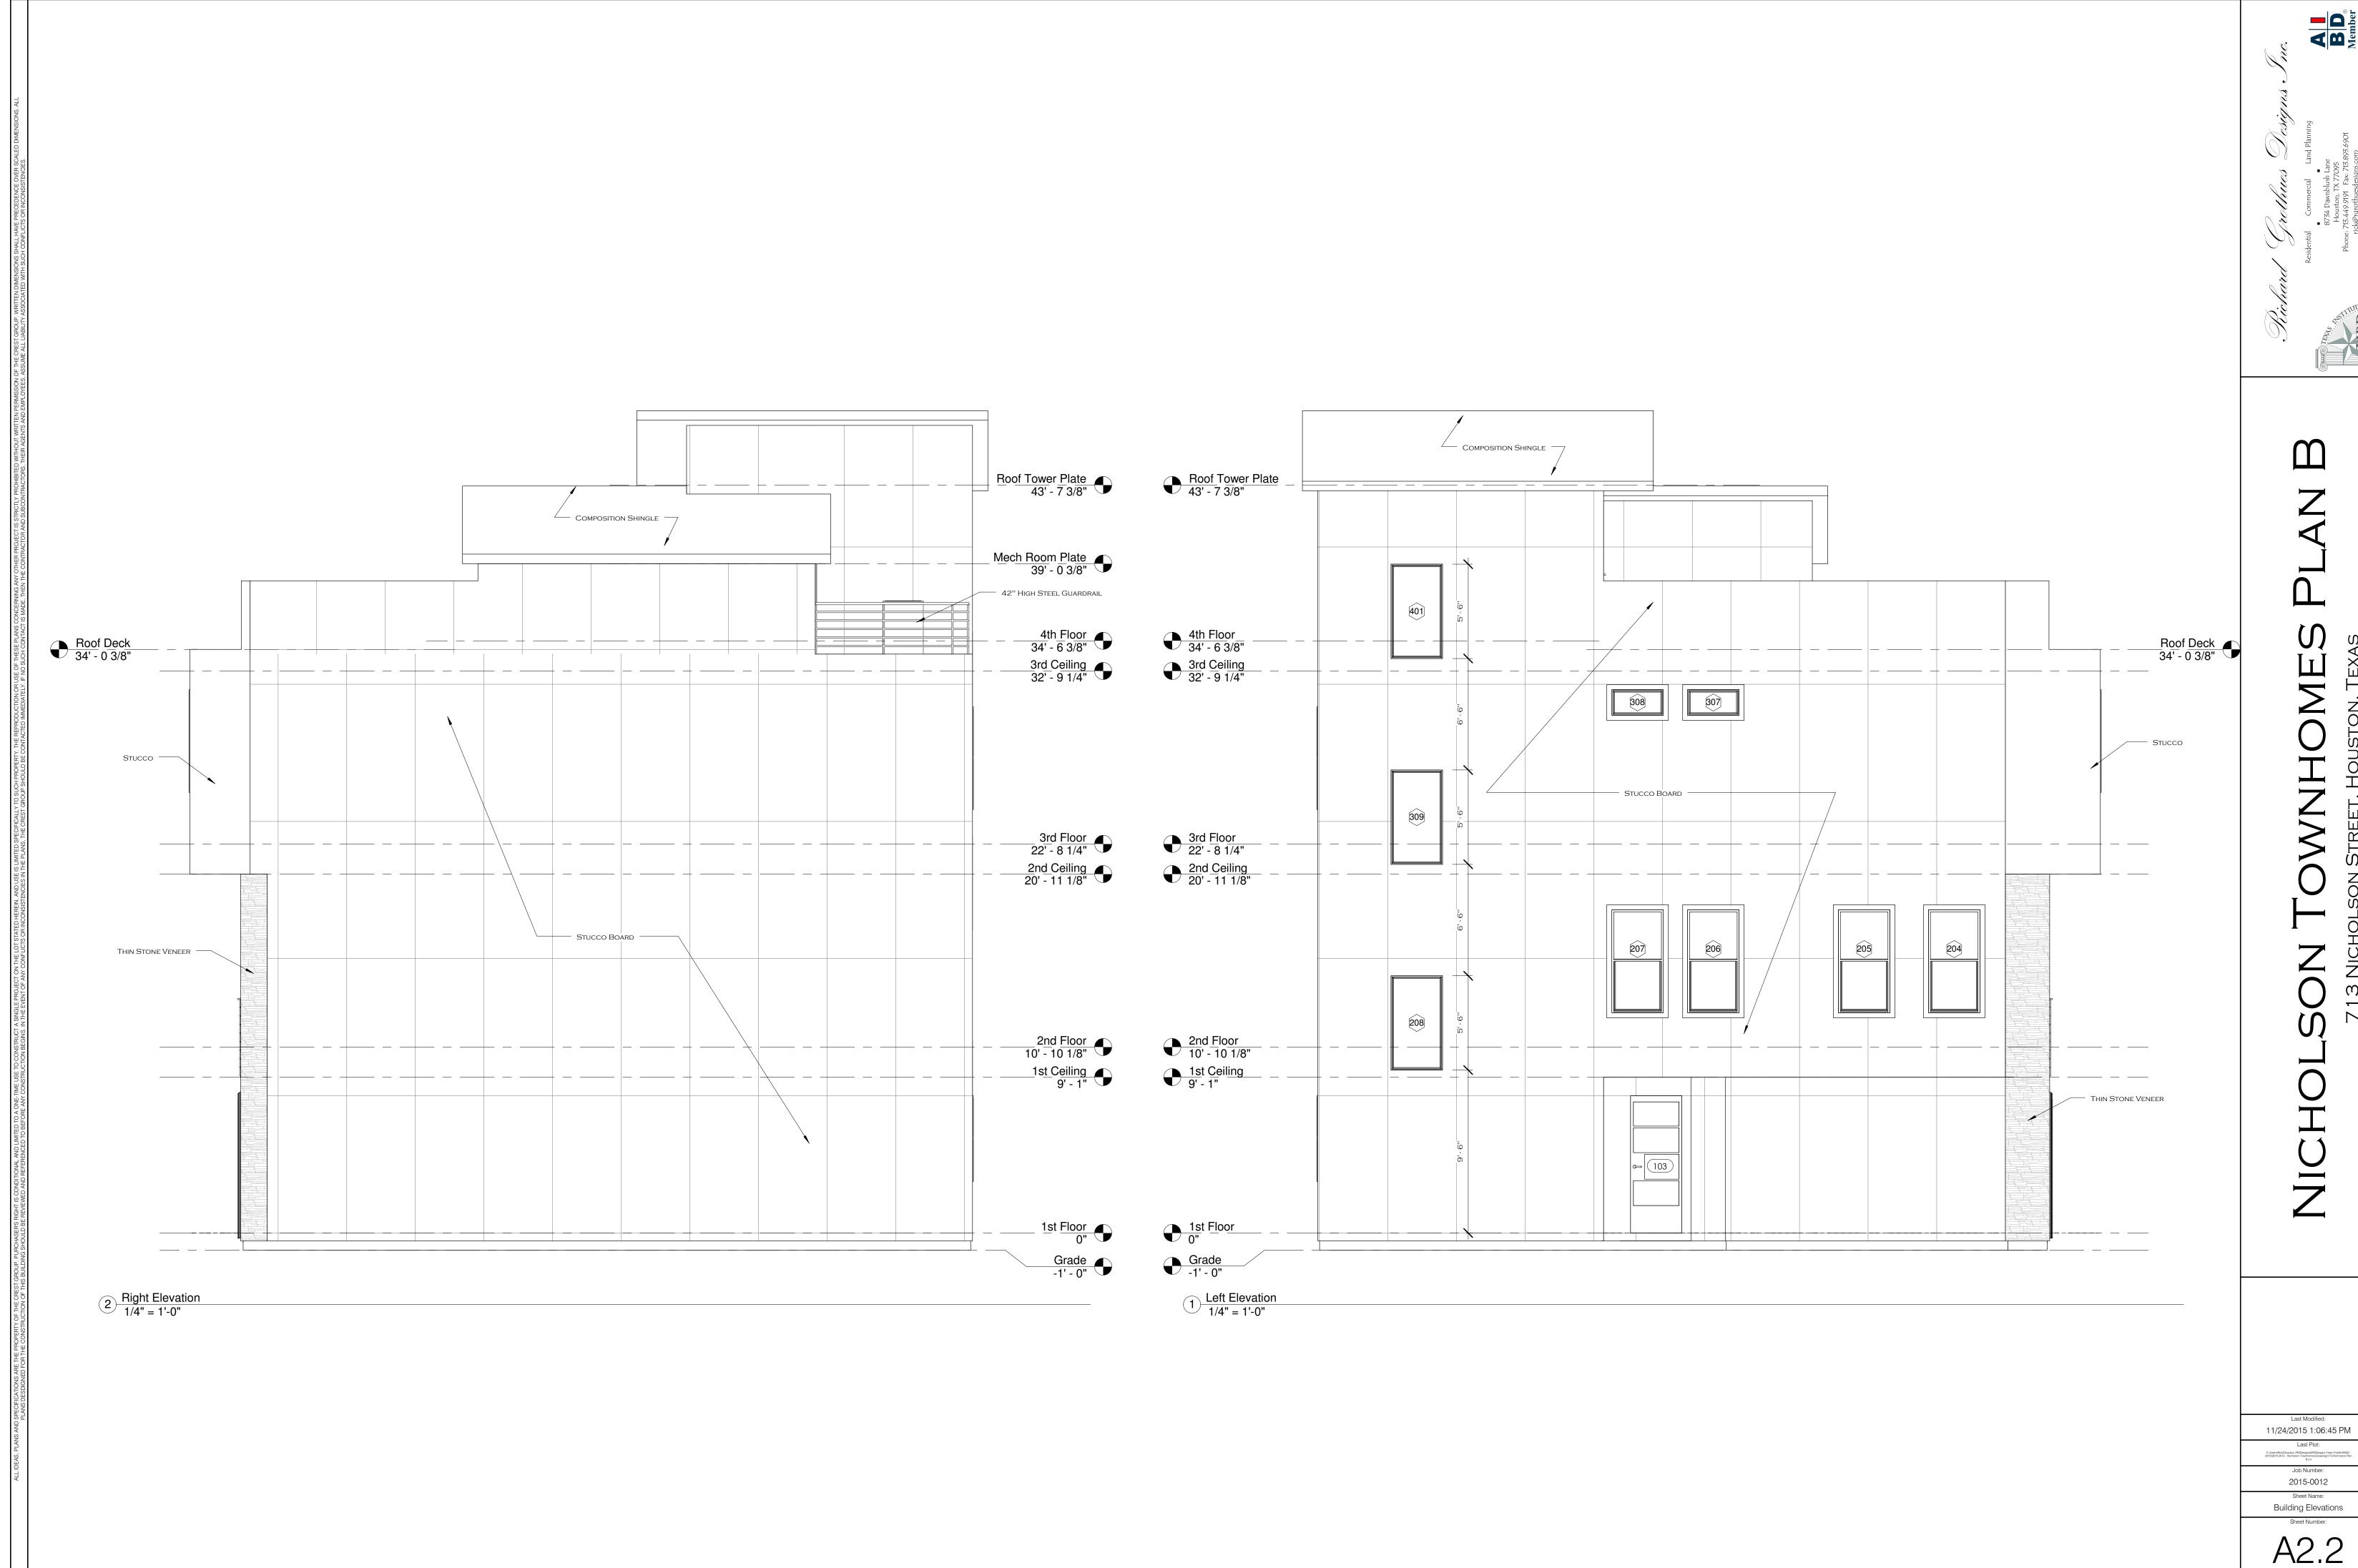

13 NICHOL