

- ANALYSIS**
1. TO BE: SEE REQUIREMENTS WITHIN OVERLAYS HAVE PRECEDENCE. CONTRACTOR TO VERIFY AND THE RESPONSIBILITY FOR ALL DIMENSIONS AND CONFORMANCE ON THE CONTRACTOR'S PART. PROVIDER OF MEASUREMENTS SHALL BE RESPONSIBLE FOR THE ACCURACY OF THE MEASUREMENTS. ALL DIMENSIONS SHALL BE TO FACE UNLESS OTHERWISE NOTED.
 2. ALL WRITTEN NOTES ON THIS DRAWING SHALL TAKE PRECEDENCE OVER THE DIMENSIONS AND DIMENSIONS SHALL TAKE PRECEDENCE OVER THE DIMENSIONS UNLESS OTHERWISE NOTED ON THE DRAWING.
 3. ALL FLOOR FINISHES TO BE DETERMINED BY THE ARCHITECT. ALL FLOOR FINISHES TO BE DETERMINED BY THE ARCHITECT. ALL FLOOR FINISHES TO BE DETERMINED BY THE ARCHITECT.
 4. ALL WALLS TO BE CONCRETE BLOCK OR BRICK. ALL WALLS TO BE CONCRETE BLOCK OR BRICK. ALL WALLS TO BE CONCRETE BLOCK OR BRICK.
 5. ALL CEILING FINISHES TO BE DETERMINED BY THE ARCHITECT. ALL CEILING FINISHES TO BE DETERMINED BY THE ARCHITECT. ALL CEILING FINISHES TO BE DETERMINED BY THE ARCHITECT.
 6. ALL DOORS TO BE 1-3/4" MIN. THICK. ALL DOORS TO BE 1-3/4" MIN. THICK. ALL DOORS TO BE 1-3/4" MIN. THICK.
 7. ALL WINDOWS TO BE 1/2" MIN. THICK. ALL WINDOWS TO BE 1/2" MIN. THICK. ALL WINDOWS TO BE 1/2" MIN. THICK.
 8. ALL GLASS AT DECK AND PORCHES SHALL BE TEMPERED SAFETY GLASS AND 1/2" MIN. THICK. ALL GLASS AT DECK AND PORCHES SHALL BE TEMPERED SAFETY GLASS AND 1/2" MIN. THICK.
 9. SEE STATE NOTES AND DETAILS. LAST SHEET COMPLY WITH N.T.S.C. 1001.1008.

GENERAL NOTES

1. PROVIDE FINISHES TO FILL OUT THE FOLLOWING: DOOR SCHEDULE, WINDOW SCHEDULE, ROOF SCHEDULE, FLOOR SCHEDULE, CEILING SCHEDULE, FINISH SCHEDULE, AND PAINT SCHEDULE.
2. PROVIDE FINISHES TO FILL OUT THE FOLLOWING: DOOR SCHEDULE, WINDOW SCHEDULE, ROOF SCHEDULE, FLOOR SCHEDULE, CEILING SCHEDULE, FINISH SCHEDULE, AND PAINT SCHEDULE.
3. PROVIDE FINISHES TO FILL OUT THE FOLLOWING: DOOR SCHEDULE, WINDOW SCHEDULE, ROOF SCHEDULE, FLOOR SCHEDULE, CEILING SCHEDULE, FINISH SCHEDULE, AND PAINT SCHEDULE.
4. PROVIDE FINISHES TO FILL OUT THE FOLLOWING: DOOR SCHEDULE, WINDOW SCHEDULE, ROOF SCHEDULE, FLOOR SCHEDULE, CEILING SCHEDULE, FINISH SCHEDULE, AND PAINT SCHEDULE.
5. PROVIDE FINISHES TO FILL OUT THE FOLLOWING: DOOR SCHEDULE, WINDOW SCHEDULE, ROOF SCHEDULE, FLOOR SCHEDULE, CEILING SCHEDULE, FINISH SCHEDULE, AND PAINT SCHEDULE.

AREAS #1	
FIRST FLOOR LIVING	418
SECOND FLOOR LIVING	162
THIRD FLOOR LIVING	162
TOTAL LIVING	742
ROOF TERRACE LIVING	--
ROOF TERRACE ACCESS	--
GARAGE & STORAGE	478
PORCHES & CARPORT	148
LOT AREA	2260
TOTAL COVERED AREA	3668

AREAS #2	
FIRST FLOOR LIVING	574
SECOND FLOOR LIVING	178
THIRD FLOOR LIVING	178
TOTAL LIVING	930
ROOF TERRACE LIVING	--
ROOF TERRACE ACCESS	--
GARAGE & STORAGE	398
PORCHES & CARPORT	162
LOT AREA	1846
TOTAL COVERED AREA	3428

AREAS #3	
FIRST FLOOR LIVING	574
SECOND FLOOR LIVING	178
THIRD FLOOR LIVING	178
TOTAL LIVING	930
ROOF TERRACE LIVING	--
ROOF TERRACE ACCESS	--
GARAGE & STORAGE	398
PORCHES & CARPORT	162
LOT AREA	1846
TOTAL COVERED AREA	3428

AREAS #4	
FIRST FLOOR LIVING	574
SECOND FLOOR LIVING	178
THIRD FLOOR LIVING	178
TOTAL LIVING	930
ROOF TERRACE LIVING	--
ROOF TERRACE ACCESS	--
GARAGE & STORAGE	398
PORCHES & CARPORT	162
LOT AREA	1846
TOTAL COVERED AREA	3428

FIRST FLOOR PLAN

SCALE: 1/4" = 1'-0" FIN. CEILING: 9'-0"

- LOU FIRE NOTE:**
1. PROVIDE 200 PSI WATER TIGHTNESS TO ALL HALLS AND CEILING IN GARAGE AREA.
 2. INSTALL 200 PSI WATER TIGHTNESS TO ALL HALLS AND CEILING IN GARAGE AREA.
 3. PROVIDE 200 PSI WATER TIGHTNESS TO ALL HALLS AND CEILING IN GARAGE AREA.
 4. PROVIDE 200 PSI WATER TIGHTNESS TO ALL HALLS AND CEILING IN GARAGE AREA.
 5. PROVIDE 200 PSI WATER TIGHTNESS TO ALL HALLS AND CEILING IN GARAGE AREA.

ALL BID

ARCHITECT

PRESTON WOOD & ASSOCIATES, L.L.C.

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BLOCK 2
UNIT 201

PROJECT: D5237

DATE: 15 APR 2006

DRAWN BY: [Signature]


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SCALE: 1/4" = 1'-0"

SHEET: 2 OF 15

PROJECT: D5237

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EGRESS NOTE:
 TO MEET EGRESS REQUIREMENTS BEDROOM WINDOW SILLS
 ARE TO BE A MAXIMUM OF 44" ABOVE FINISHED FLOOR.
 THE MINIMUM CLEAR OPENINGS ARE 20" HIGH, 20" WIDE AND
 A MINIMUM 5.7 SQ. FT. NET CLEAR OPENING.

SECOND FLOOR PLAN

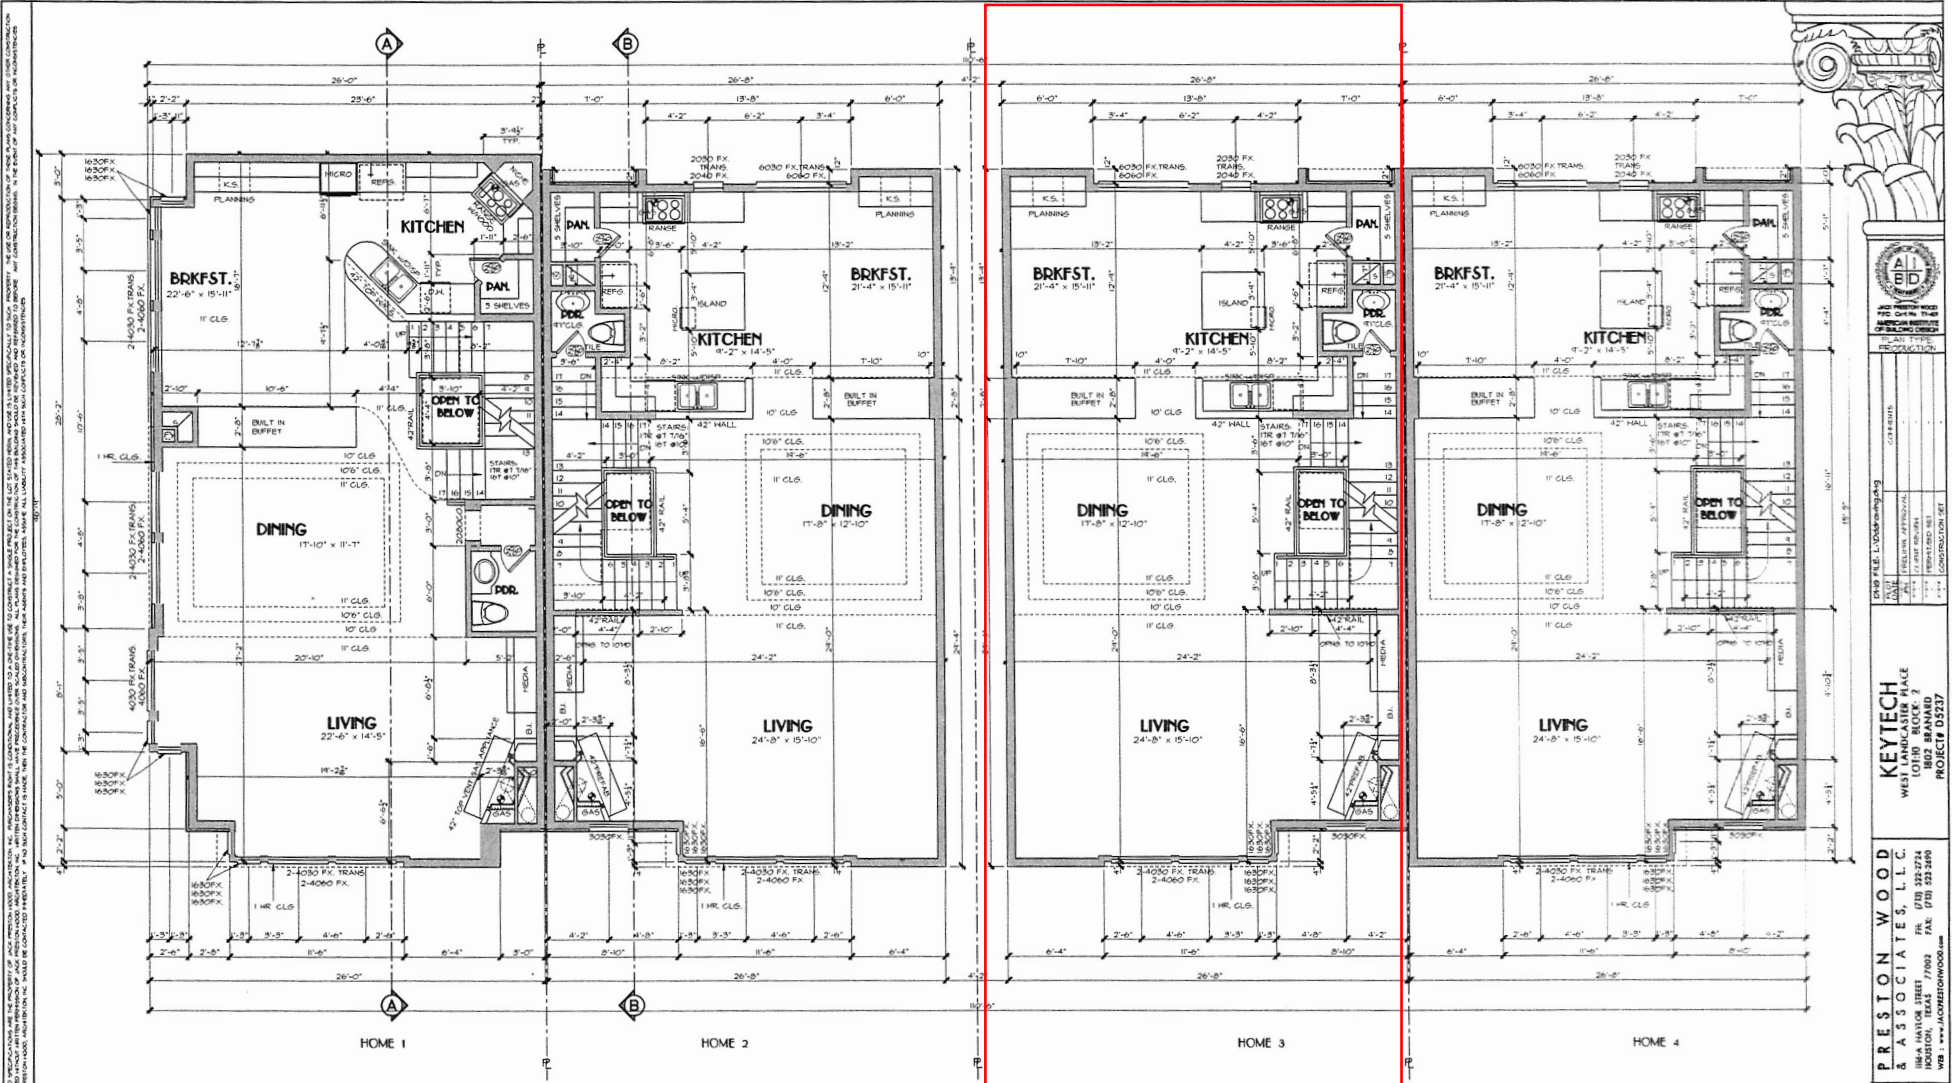SCALE: 1/4" = 1'-0"
 1" = 12" CEILING SING.
 PRIMARY FLOOR COVERING: HOOD UNO
 SUGGESTED FLOOR SYSTEM: 4" OPEN HEEL JOISTS




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 TO MEET EGRESS REQUIREMENTS BEDROOM WINDOW SILLS ARE TO BE A MINIMUM OF 44" ABOVE FINISHED FLOOR. THE MINIMUM CLEAR OPENINGS ARE 24" HIGH 20" WIDE AND A MINIMUM 5.7 SQ. FT. NET CLEAR OPENING.

THIRD FLOOR PLAN

SCALE: 1/8" = 1'-0"

9'-0" CEILINGS UNTO
 PRIMARY FLOOR COVERINGS (CARP. INCL.)
 SUGGESTED FLOOR SYSTEM: 4" GYPSUM CORE FRISAB
 PROVIDE METAL PAN IN 2" RELIEF LINE TO OUTSIDE
 IN ALL UTILITY AREAS
 PROVIDE METAL PAN IN 2" RELIEF LINE TO OUTSIDE
 IN ALL HVAC & WATER HEATER CLOSETS
 WATER PROOF ALL HALLS & WATER HEATER CLOSETS

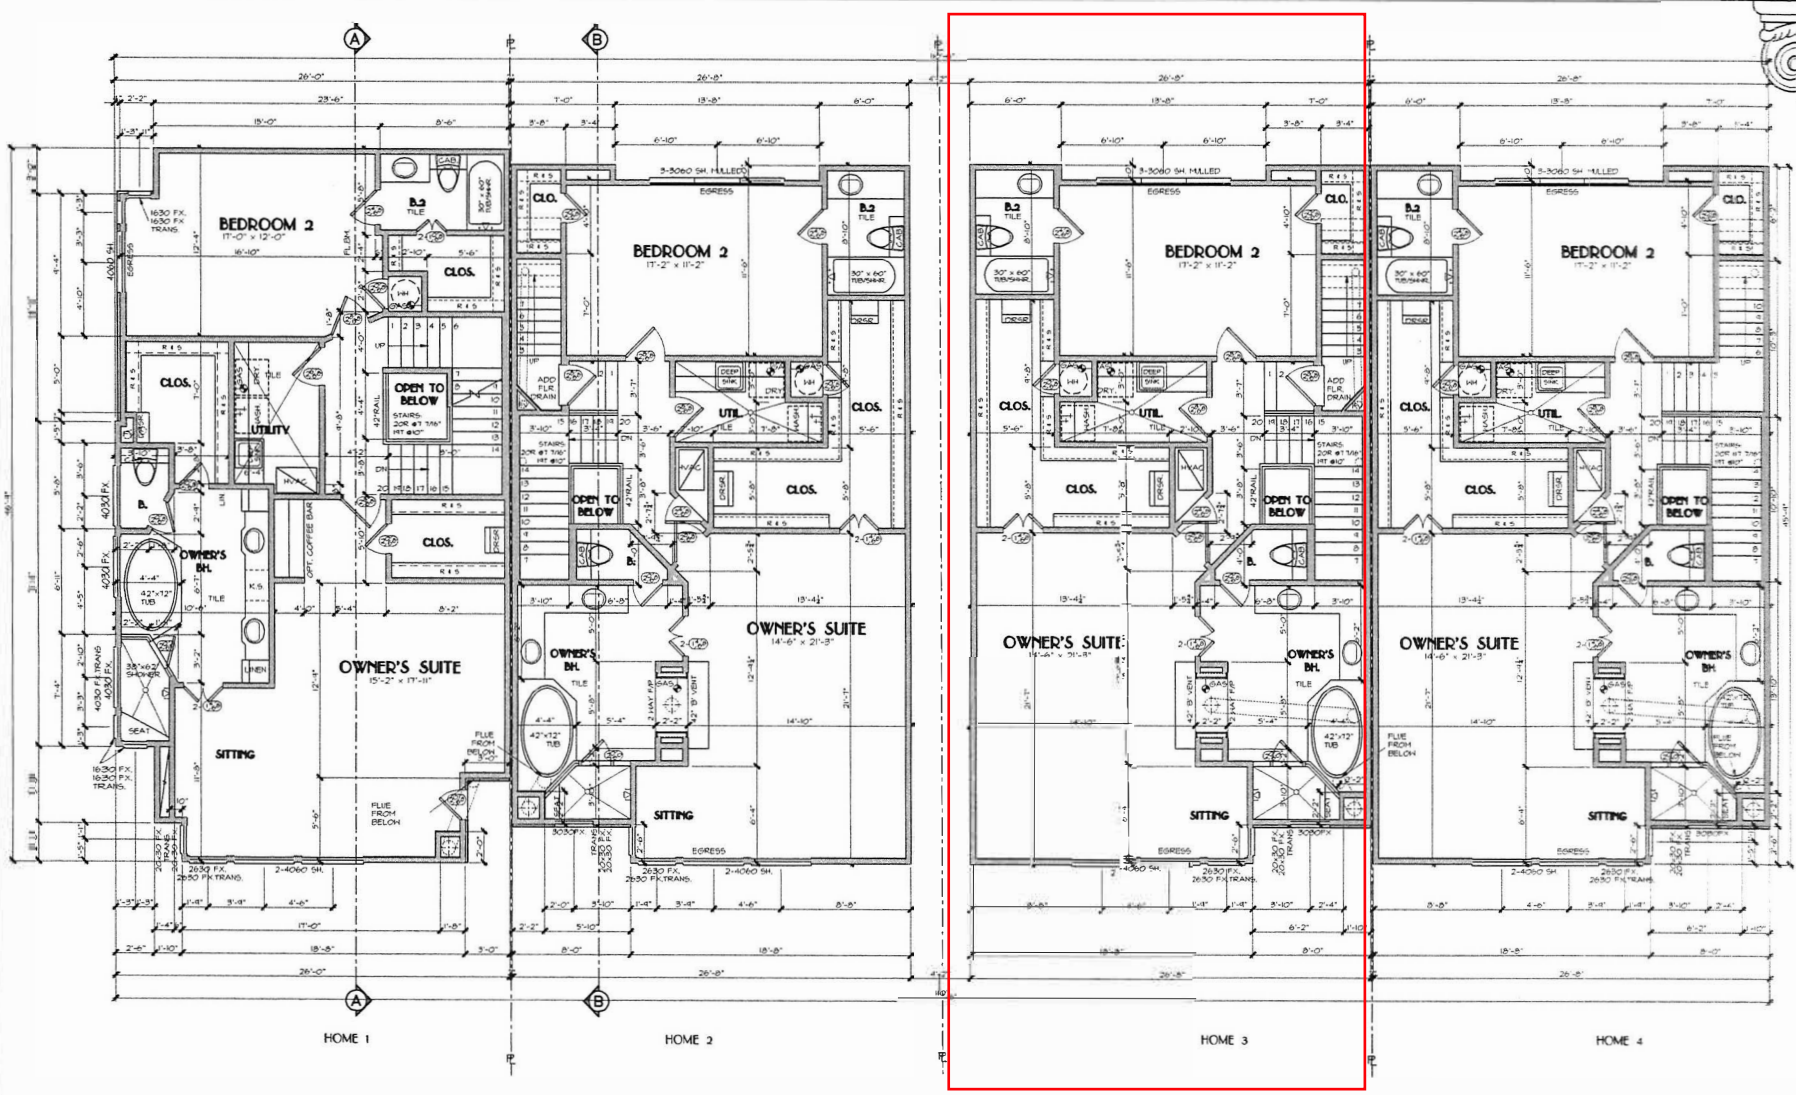

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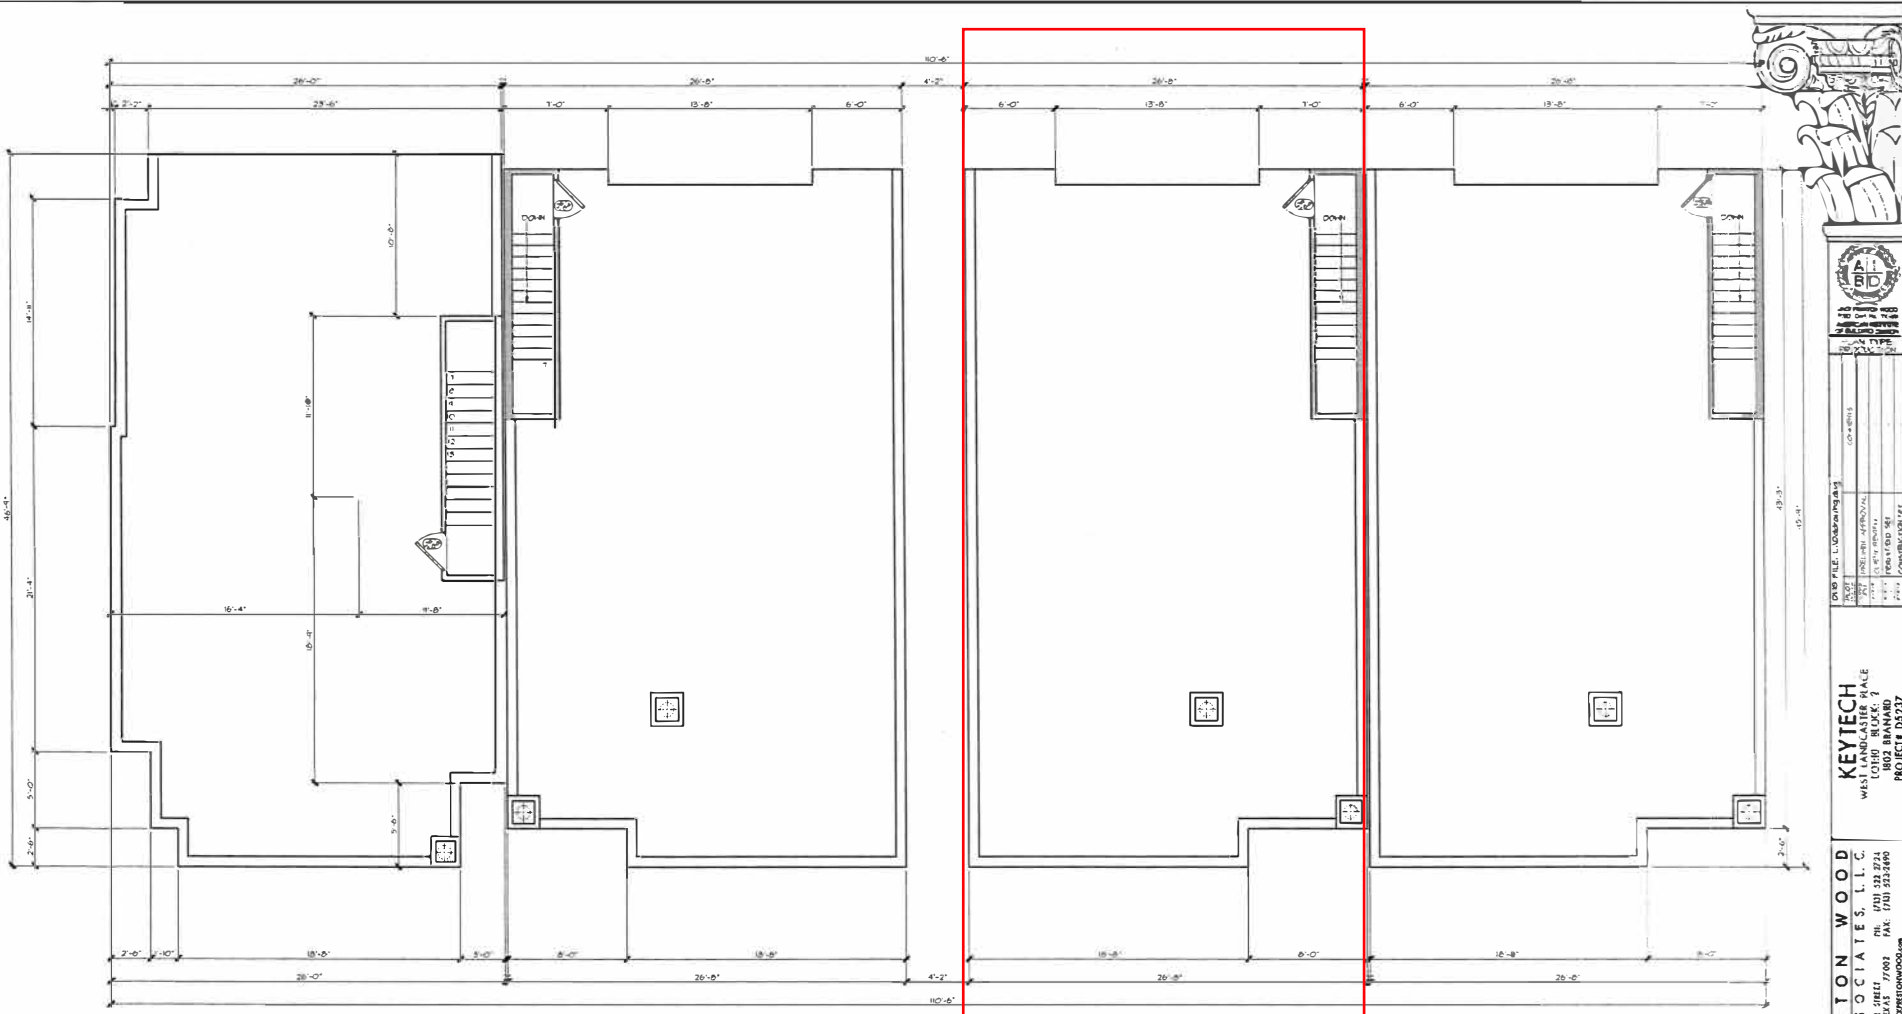
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 JOB: D5237

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DATE	08-15-02
BY	L. WOODWARD
CHKD BY	L. WOODWARD
APP'D BY	L. WOODWARD
PROJECT	CONSTRUCTION SET



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