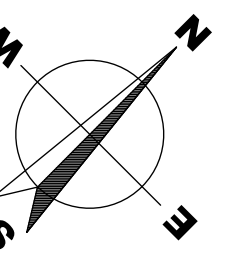


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77096**

FIRST FLOOR :	4,090	SQ. FT.
SECOND FLOOR :	2,806	SQ. FT.
TOTAL A/C :	6,896	SQ. FT.
GARAGE :	539	SQ. FT.
BACK PORCH :	421	SQ. FT.
FRONT PORCH :	73	SQ. FT.
2nd FLR TERRACES :	60	SQ. FT.
TOTAL SLAB :	5,183	SQ. FT.
TOTAL FRAME :	7,989	SQ. FT.

MARK DATE DESCRIPTION

PROJECT NO: # SCALE: 1"=0'-1/2"

CAD DWG FILE: 3115 ABERDEEN WAY.DWG

DRAWN BY: ISAAC



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SECOND FLOOR PLAN

A2.2



- GENERAL NOTES / REFER TO IRC 2012 and City of HOUSTON, Code of Ordinance:
- DO NOT SCALE DRAWINGS, WRITTEN DIMENSIONS TAKE PRECEDENCE. CONTRACTOR TO VERIFY AND BE RESPONSIBLE FOR ALL DIMENSIONS AND CONDITIONS ON THE JOB.
 - ALL WRITTEN NOTES ON THESE DRAWINGS SHALL TAKE PRECEDENCE OVER THE MINIMUM STANDARD NOTES DETAILED ON THE LAST SHEET OF THESE DRAWING.
 - BUILDER TO APPROVE LOCATION OF HOUSE ON LOT, AND TO VERIFY ALL UTILITY LOCATIONS, ALL EASEMENTS, BUILDING AND SETBACK LINES, AND TO OBSERVE ALL DEED RESTRICTIONS PRIOR TO CONSTRUCTION.
 - ALL BEDROOM WINDOW SILLS TO BE A MAXIMUM OF 44" ABOVE FINISHED FLOOR MINIMUM OPENINGS ARE 24" HIGH, 20" WIDE AND MINIMUM OF 5.7 SQ. FT. OF NET CLEAR.
 - ALL PRE-FAB FIREPLACES TO BE BUILT AND INSTALLED PER 2012 IRC ECT 3102 AND BE UL AND I.C.B.O. APPROVED
 - A COPY OF THE MANUFACTURER INSTALLATION MANUAL WILL BE AVAILABLE IN SITE FOR INSPECTOR REVIEW.
 - STAIRWAYS SHALL COMPLY WITH 2012 IRC MINIMUM WIDTH BETWEEN HANDRAILS SHALL BE 30"
 - HANDRAILS TO BE 34 TO 38" ABOVE NOSING OF TREADS.
 - GUARDRAILS TO BE 42" ABOVE FINISHED FLOOR WITH BALUSTERS AT 4" O.C. MAX. NEVEL POST SHALL NOT BE LOCATED ABOVE FIRST TREAD.
 - HANDGRIPPING PORTION OF HANDRAIL SHALL NOT BE LESS THAN 1 1/4" NOR MORE THAN 2" IN CROSS SECTION.
 - PROVIDE UNDERSIDE OF ALL STAIRWELLS WITH 5/8" TYPE "X" FIRE RATED GYPSUM WHICH UNDERSIDE CAN BE CLOSED OFF.
 - SMOKE DETECTORS REQUIRE 115 VOLT CONNECTION TO HOUSE WIRING WITH BATTERY BACKUP.
 - ALL FLOOR DRAINS TO HAVE OVERFLOW PAN WITH RELIEF LINE TO OUTSIDE OR STORM SEWER (NOT SANITARY SEWER LINE).
 - PROVIDE PLUMBING ACCESS PANEL AT ALL TUBS BY PLUMBING CODE CHAPTER 4 SECTIONS 405, 405.8.
 - ALL GLASS AT TUBS AND SHOWERS SHALL BE TEMPERED SAFETY GLASS.
 - PROVIDE VENTILATION AT ALL BATHS AND UTILITY ROOMS THROUGHOUT NATURAL OR MECHANICAL MEANS.
 - ATTIC ACCESS IS PROVIDED ON PLANS TO SERVICE MECHANICAL EQUIPMENT AND LIMITED LIGHT STORAGE BUT IN NO CASE SHALL THE COMBINED DECKED ATTIC AREAS EXCEED 500 SQ. FT.
 - LOCATE WATER HEATER(S) IN ATTIC ABOVE LOAD-BEARING PARTITION IN A PAN, WITH RELIEF DRAIN LINE TO OUTSIDE OR STORM SEWER LINE.
 - CHIMNEYS TO BE MINIMUM 24" ABOVE ANY ROOF LINE.

S42°36'37" W
3' B.L.
(See Note 10)

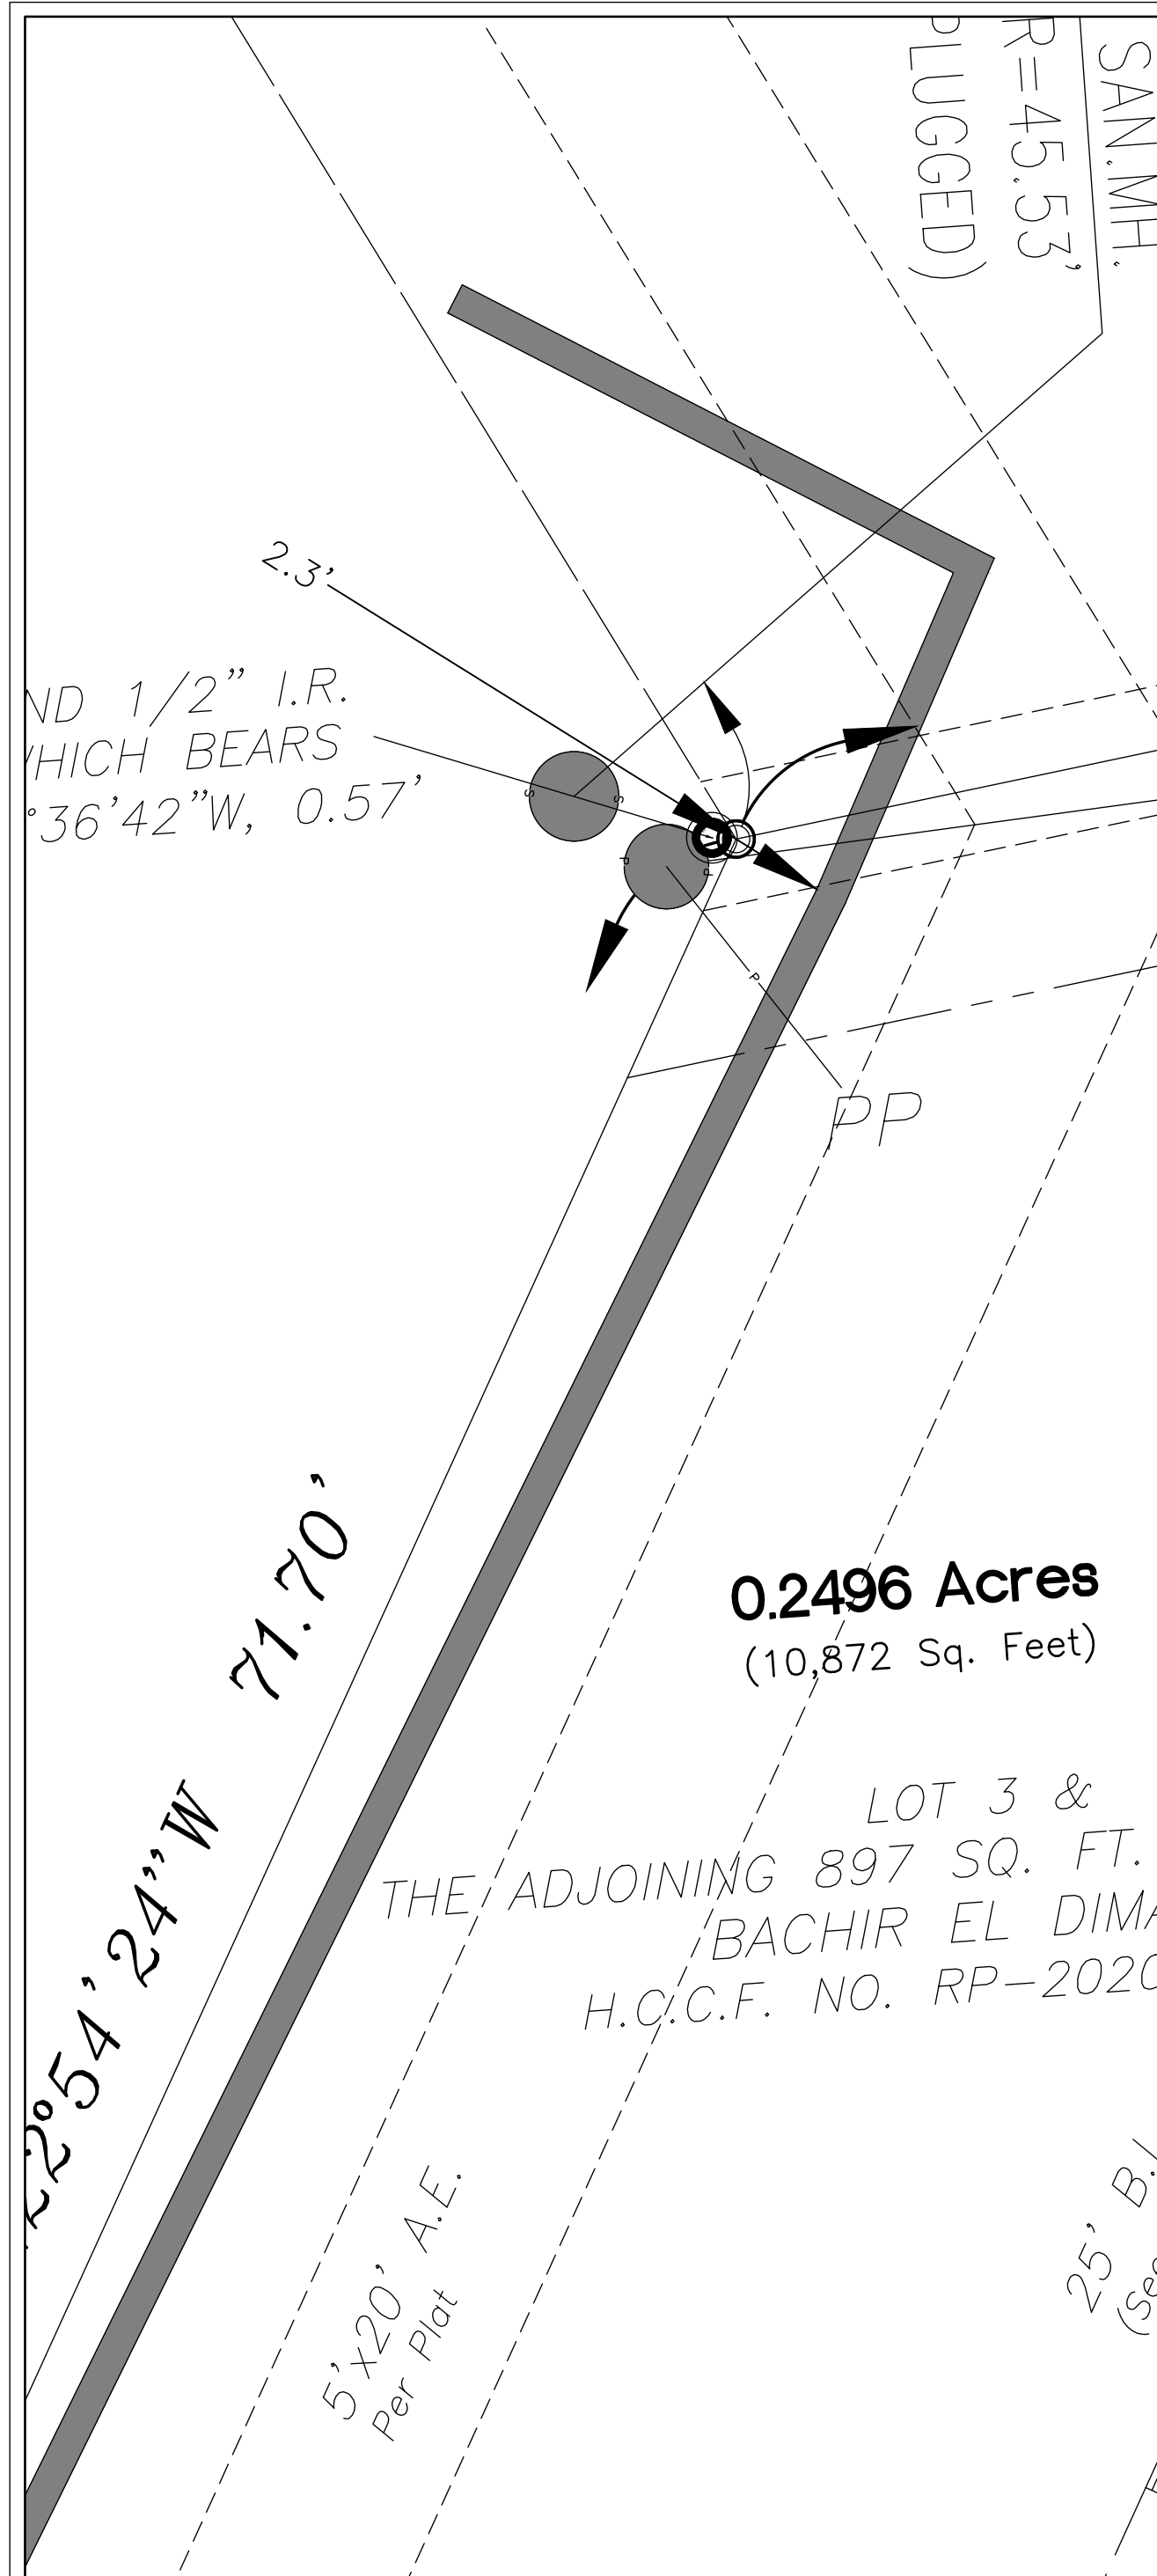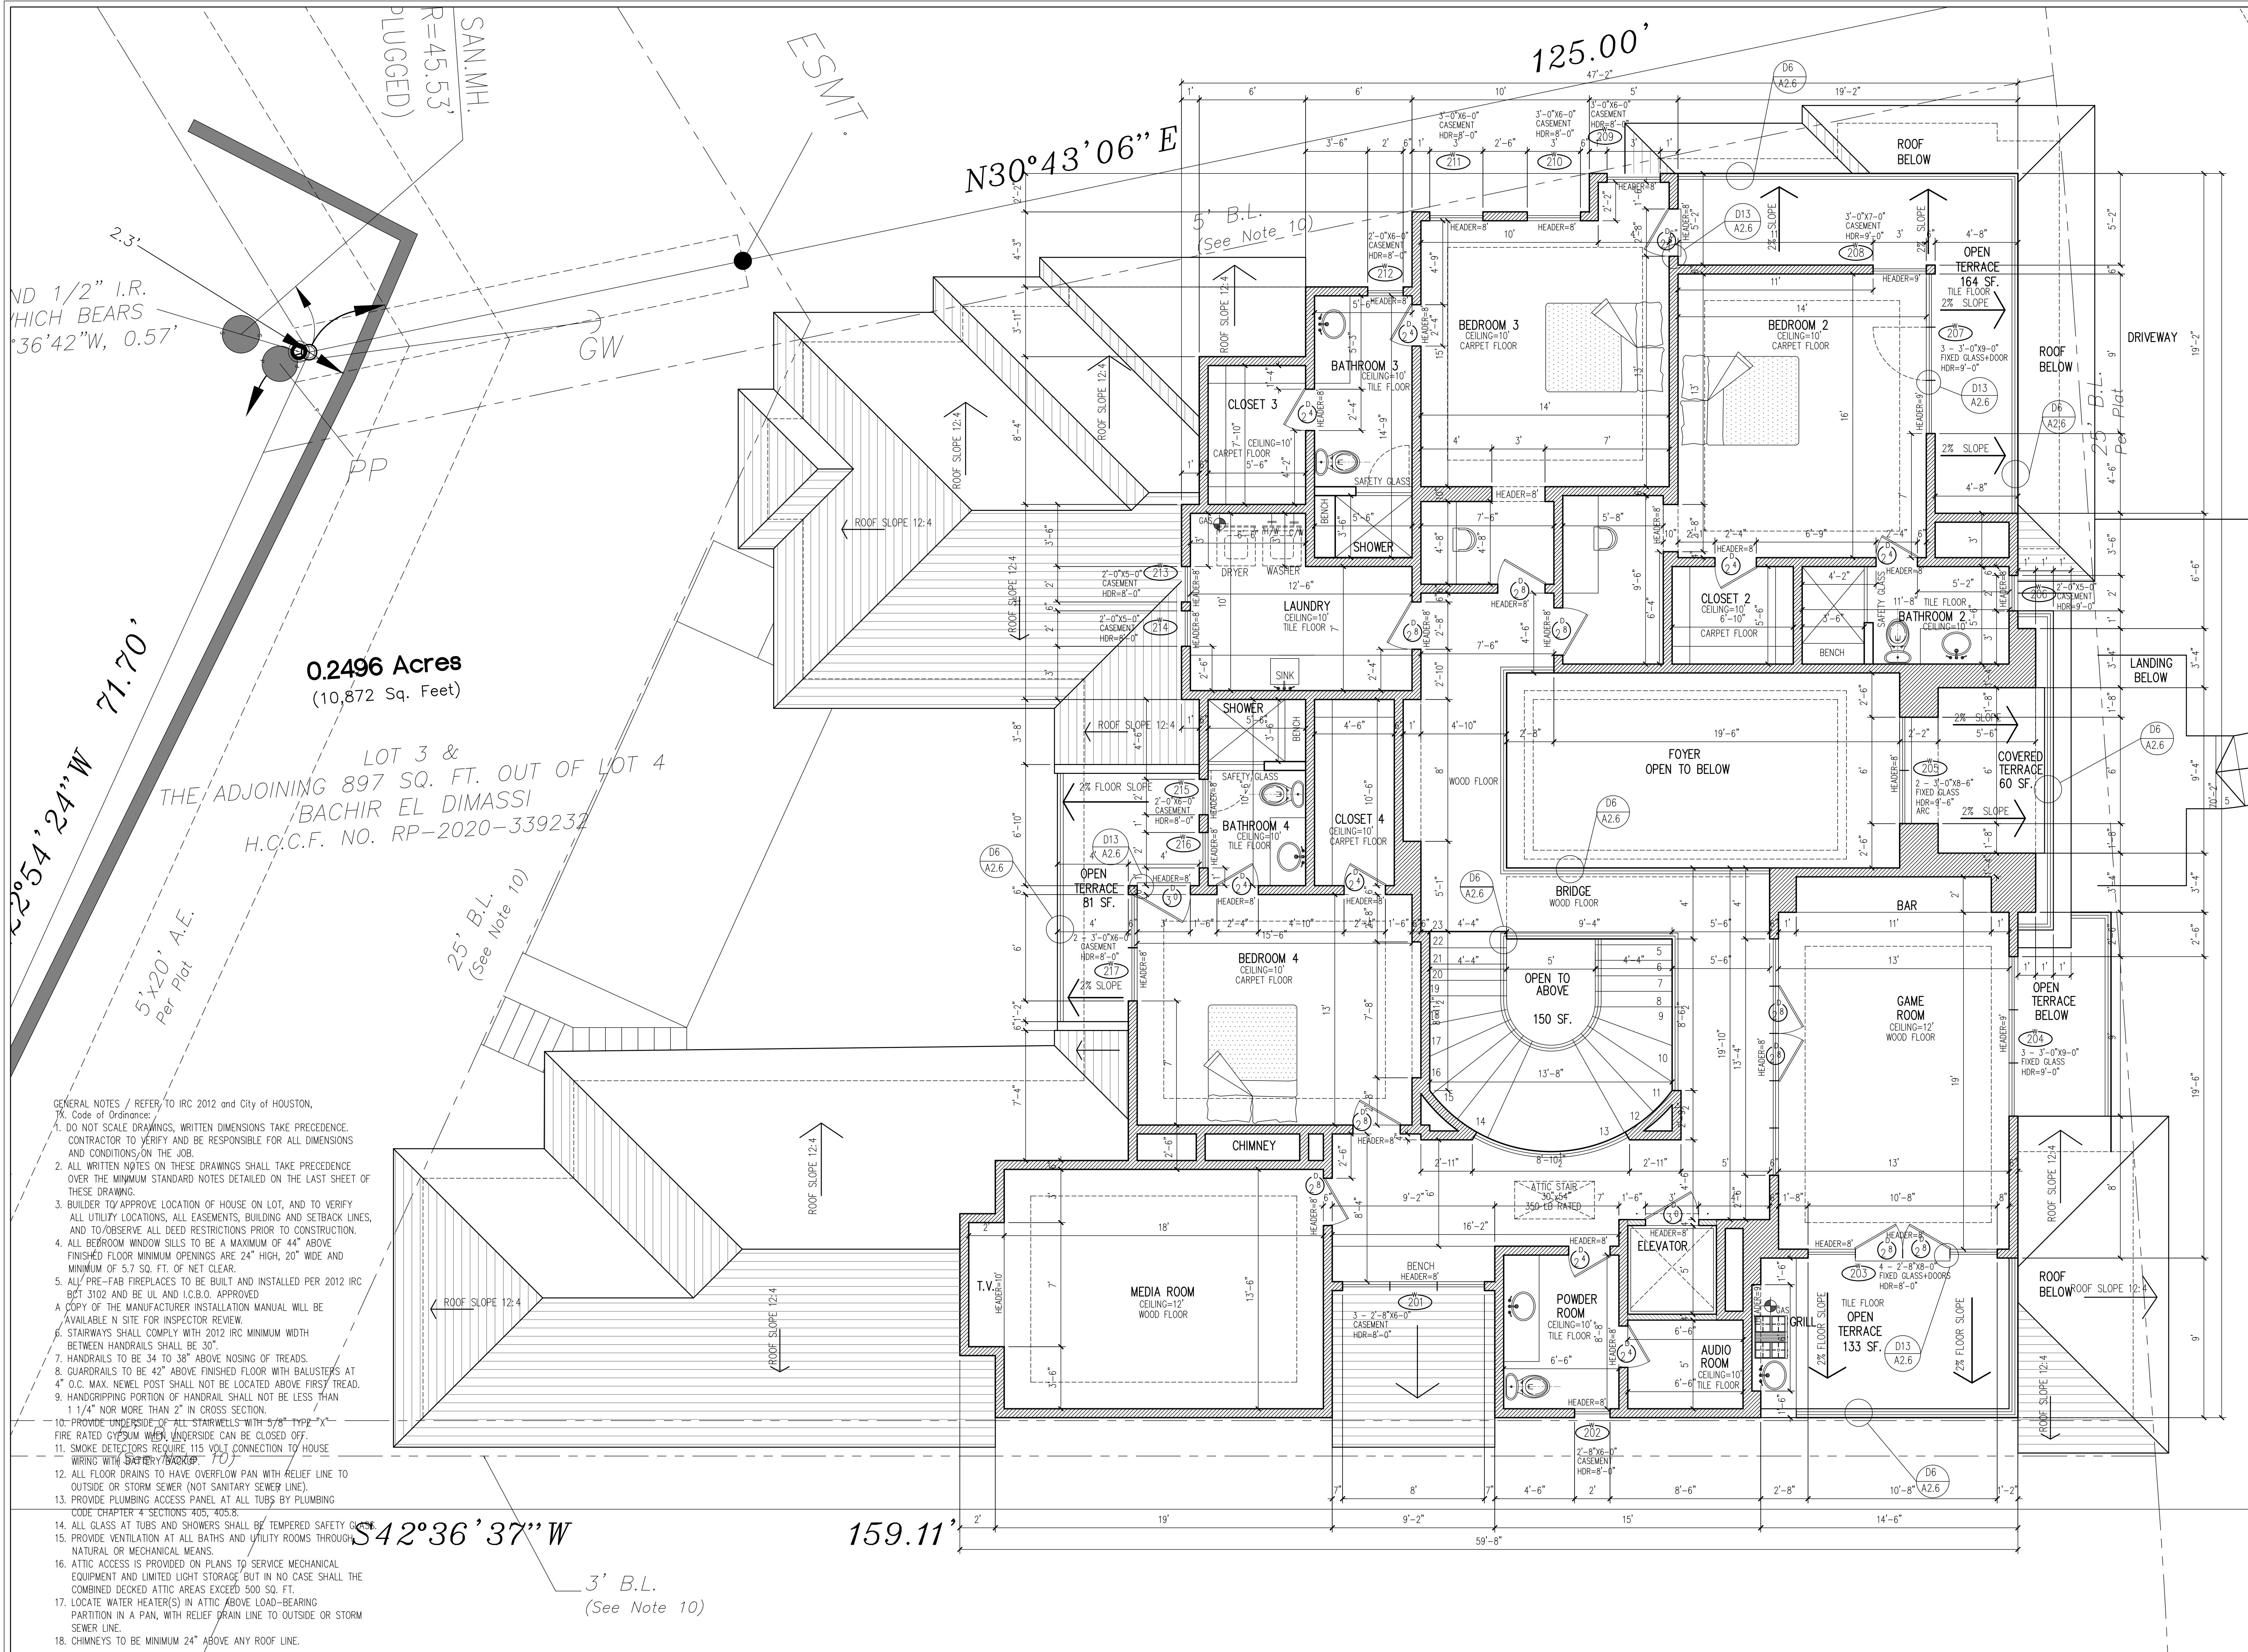159.11'

125.00'

N30°43'06" E

AND 1/2" I.R.
HIGH BEARS
36'42"W, 0.57'

71.70'
72°54'24" W
5'x20' A.E.
Per Plat

0.2496 Acres
(10,872 Sq. Feet)

LOT 3 &
THE ADJOINING 897 SQ. FT. OUT OF LOT 4
BACHIR EL DIMASSI
H.C.C.F. NO. RP-2020-339232

25' B.L.
(See Note 10)

5' B.L.
(See Note 10)

25' B.L.
Per Plat

ROOF SLOPE 12:4

ROOF SLOPE 12:4

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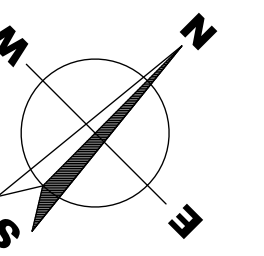
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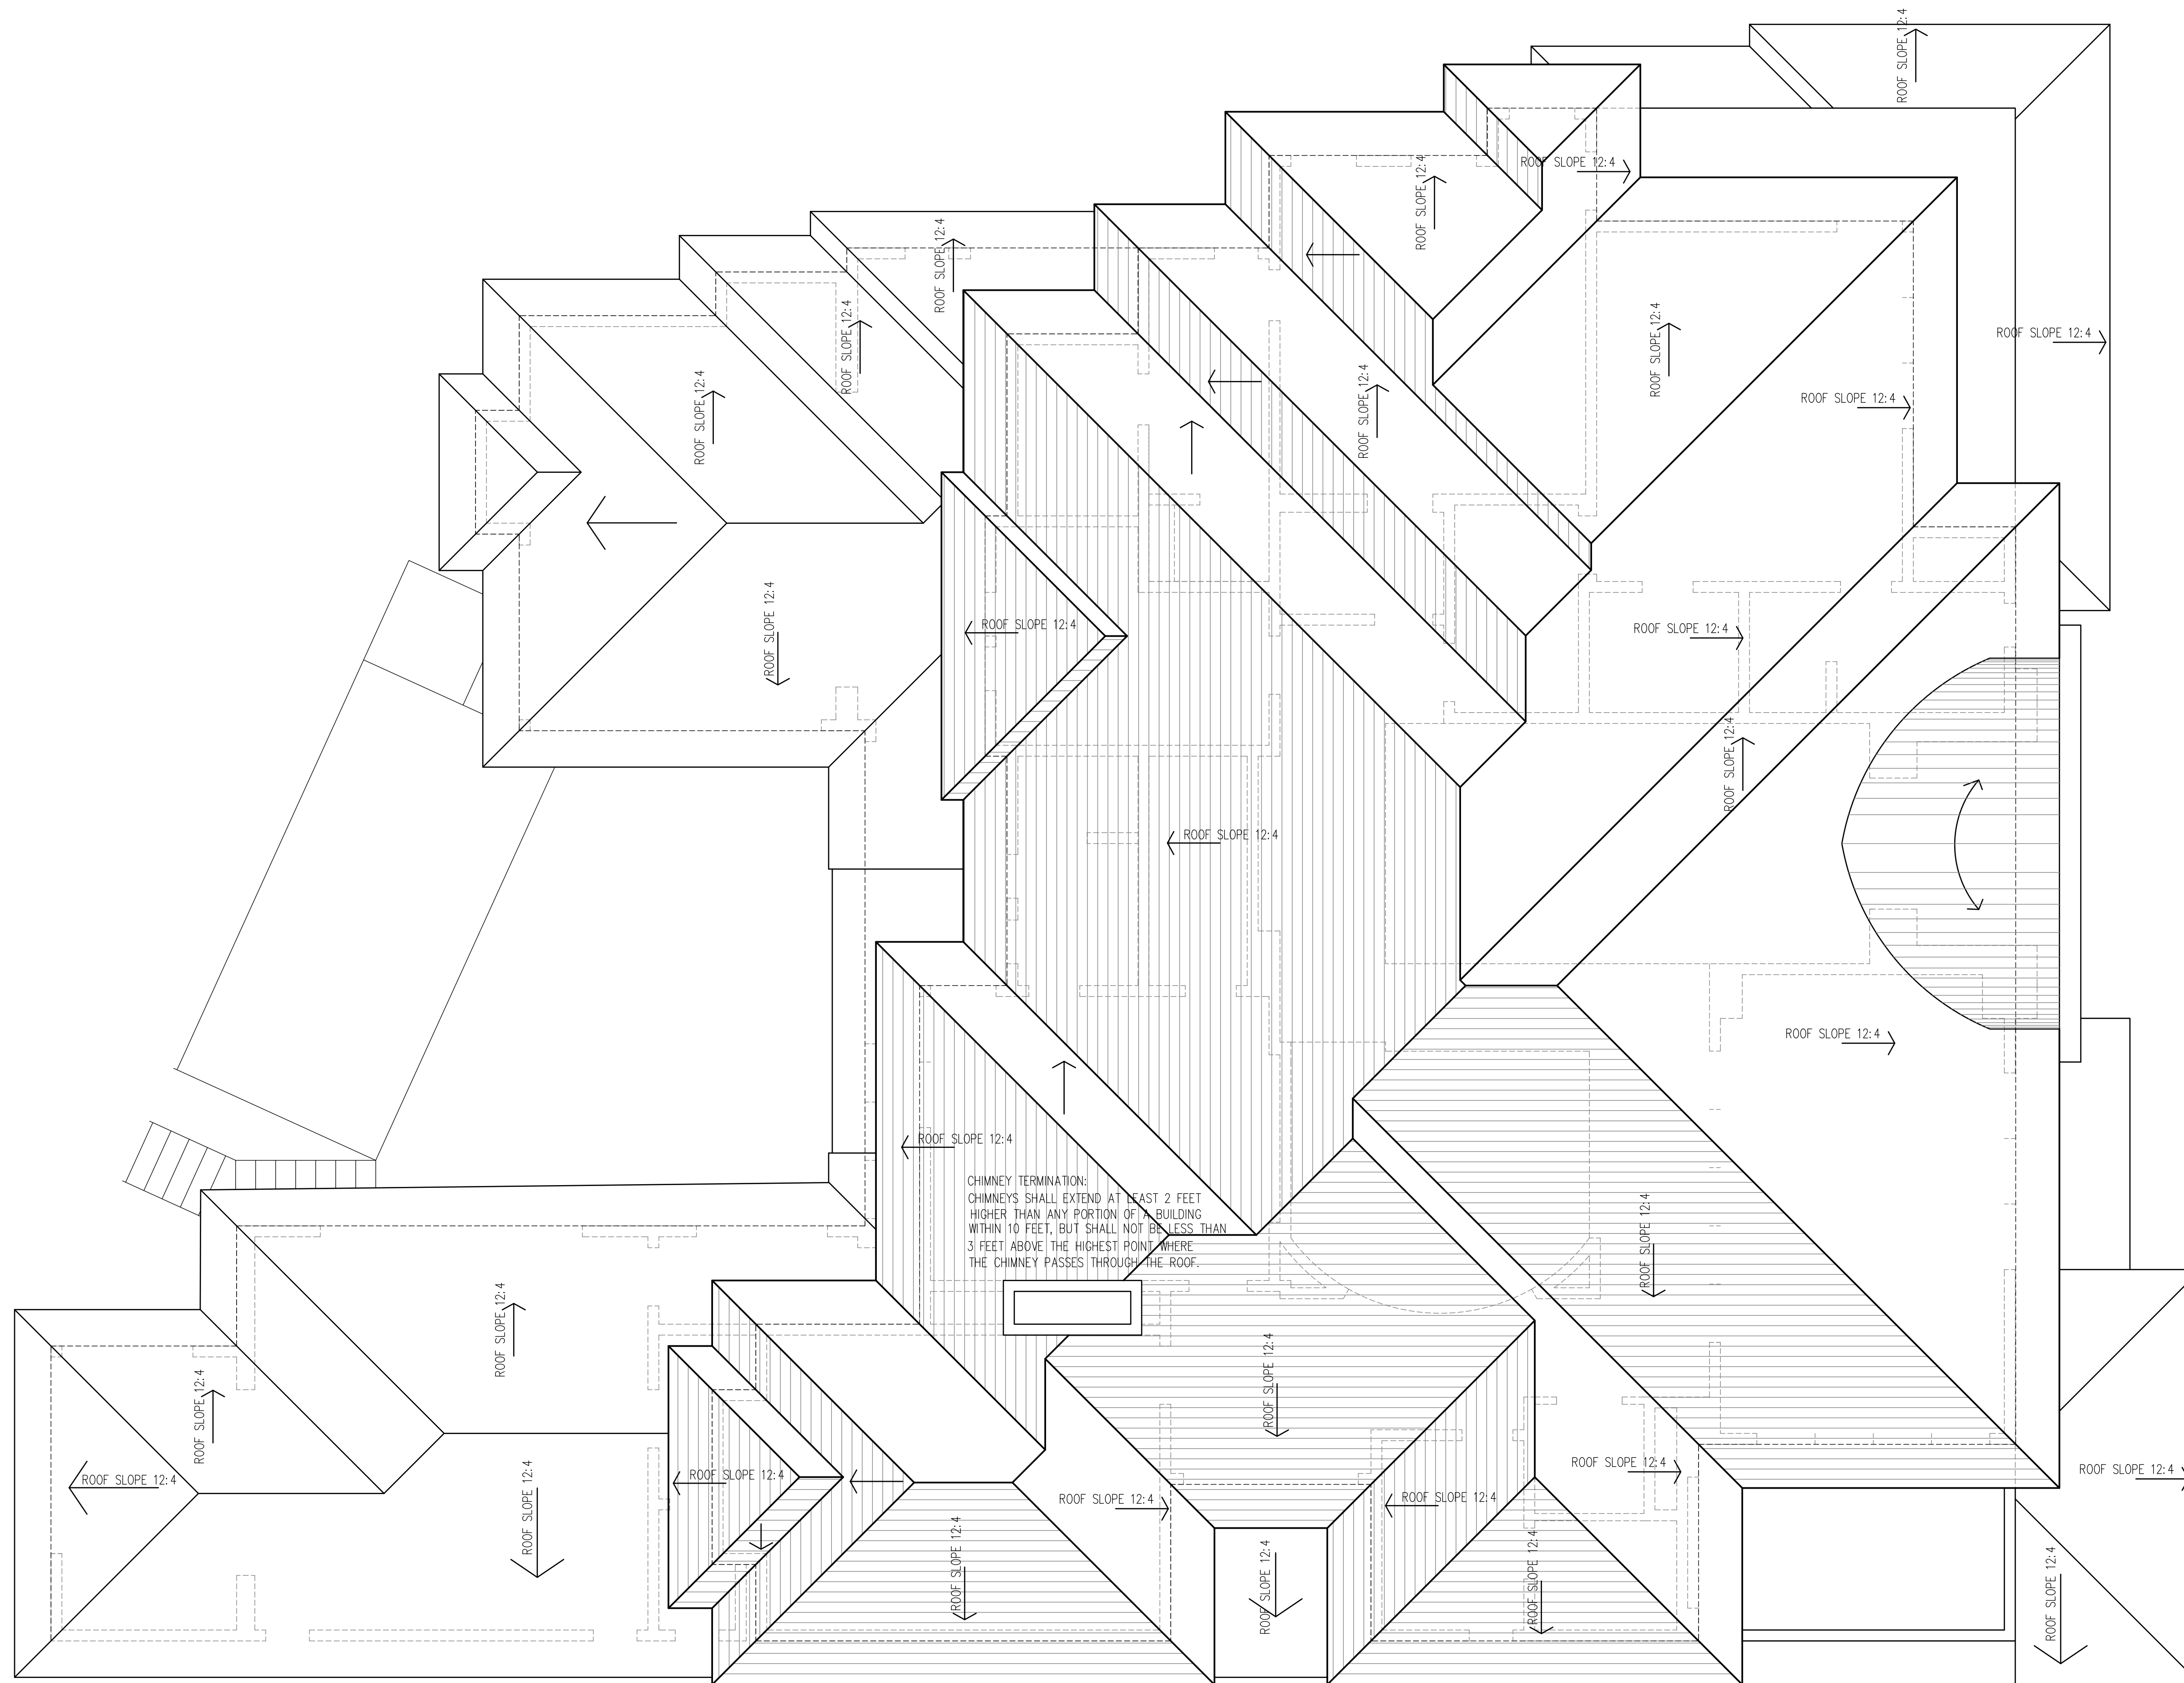
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CHIMNEY TERMINATION:
CHIMNEYS SHALL EXTEND AT LEAST 2 FEET
HIGHER THAN ANY PORTION OF A BUILDING
WITHIN 10 FEET, BUT SHALL NOT BE LESS THAN
3 FEET ABOVE THE HIGHEST POINT WHERE
THE CHIMNEY PASSES THROUGH THE ROOF.

1. 1/2" CDX PLYWOOD DECKING OR EQUAL.
2. CONTINUOUS 'HARDIE' VENTED SOFFIT AND RIDGE VENTS BE USED.
3. FULL GUTTERING WITH DOWNSPOUTS TO PROPERTY DRAINAGE.

MARK	DATE	DESCRIPTION
PROJECT NO: #	SCALE:	1"=0'-1/4"
CAD DWG FILE:	3115 ABERDEEN WAY.DWG	
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CHK'D BY: ###	DATE:	08.12.2020

SHEET TITLE

ROOF PLAN

A2.3

ELECTRICAL NOTES:

- a) NEPA 70 NEC 2017 Texas adopted and CITY OF HOUSTON ORDINANCE. "VERIFY AT INSPECTION"
- b) RECEPTACLES PER ARTICLE 210.52. (VERIFY BY INSPECTION)
1. Receptacles shall be installed so that no point along the floor line in any wall space is more than 6 ft. from an outlet, including any wall space 2 ft. wide or greater.
 2. In kitchens and dining rooms, counter space receptacles shall be installed:
 - At each wall counter space that is 12 in. or greater;
 - No more than 48 in. oc.;
 - On island counter spaces (one receptacle min.);
 - On peninsular counter spaces (one receptacle min.);
 - Not more than 18 in. above the counter top.
 3. In bathrooms, at least one wall receptacle shall be within 36 in. of each basin.
 4. In laundry rooms, at least one receptacle shall be provided.
 5. In garages, at least one receptacle shall be provided.
 - 6- In hallways of 10 ft. or more in length, at least one receptacle shall be provided.
- c) ARC-FAULT CIRCUIT INTERRUPTER
Branch circuits that supply dwelling unit bedrooms shall be protected by Arc-Fault Circuit Interrupters.
- d) ARC-FAULT CIRCUIT INTERRUPTERS. PER ARTICLE 210.12(B) (VERIFY BY INSPECTION)
Ground-Fault Circuit-Interrupter protection shall be installed in:
 - Bathrooms and shower area
 - Garages and accessory buildings
 - At all exterior locations
 - In crawl spaces
 - Kitchen
 - Within 6 ft. of wet bar sinks.
- e) ENERGY
1. All general lighting in kitchens shall be fluorescent (40 lumens per watt).
Lighting shall:
 - Provide a uniform pattern of lighting, and a light level sufficient for performing basic kitchen tasks;
 - Be controlled on a readily accessible switch at an entrance to the kitchen;
 - Not contain medium-base incandescent lamp sockets.
 2. All bathrooms containing a shower or bathtub shall have fluorescent lighting (40 lumens per watt).
- f) LIGHTING
Switched lighting shall be installed:
 - In all habitable rooms and in bathrooms;
 - In hallways and stairways;
 - In garages;
 - At all outdoor entrances and exits.
- g) FANS
In bathrooms containing tubs and showers;
 - 1- A fan capable of providing 5 air changes per hour shall be installed when exterior openings for natural ventilation are provided;
 - 2- A fan capable of providing 7.5 air changes per hour shall be installed when no exterior openings for natural ventilation are provided.
- H) open incandescent luminaires shall not be install in closets. (Article 410.16(B))


ELEC. SYMBOL SCHEDULE

- ⊕ 110V OUTLET
- ⊕ 220V OUTLET
- ⊕ CAT. 5 INTERNET
- ☎ TELEPHONE
- ☎ SMOKE DETECTOR HARD-WIRED W/ BATTERY BACK-UP
- ☎ RECESSED LIGHT
- ☎ 110V PENDANT LIGHT FIXTURE
- ☎ FLOOD LIGHT
- ☎ CEILING FAN
- ☎ ESHAUST FAN
- ☎ 110V CHANDELIER LIGHT FIXTURE
- ☎ 110V WALL LIGHT FIXTURE
- ☎ 110V OUTDOOR WALL LIGHT FIXTURE
- ☎ 110V DUPLEX RECEPTACLE W/ WEATHERPROOF COVER
- ☎ 110V DUPLEX RECEPTACLE GROUND FAULT INTERRUPTED
- ☎ 220V RECEPTACLE
- ☎ WATER PROOF SWITCH
- ☎ J BOX

SMOKE DETECTORS: (SD)
smoke detectors shall be hard-wired and inter-connected with battery backup.

C.O. DETECTORS: (CO)
INSTALL carbon monoxide detectors shall be hard-wired and inter-connected with battery backup.

NOTES:
1. ARC FAULT PROTECTION IS REQUIRED THROUGHOUT

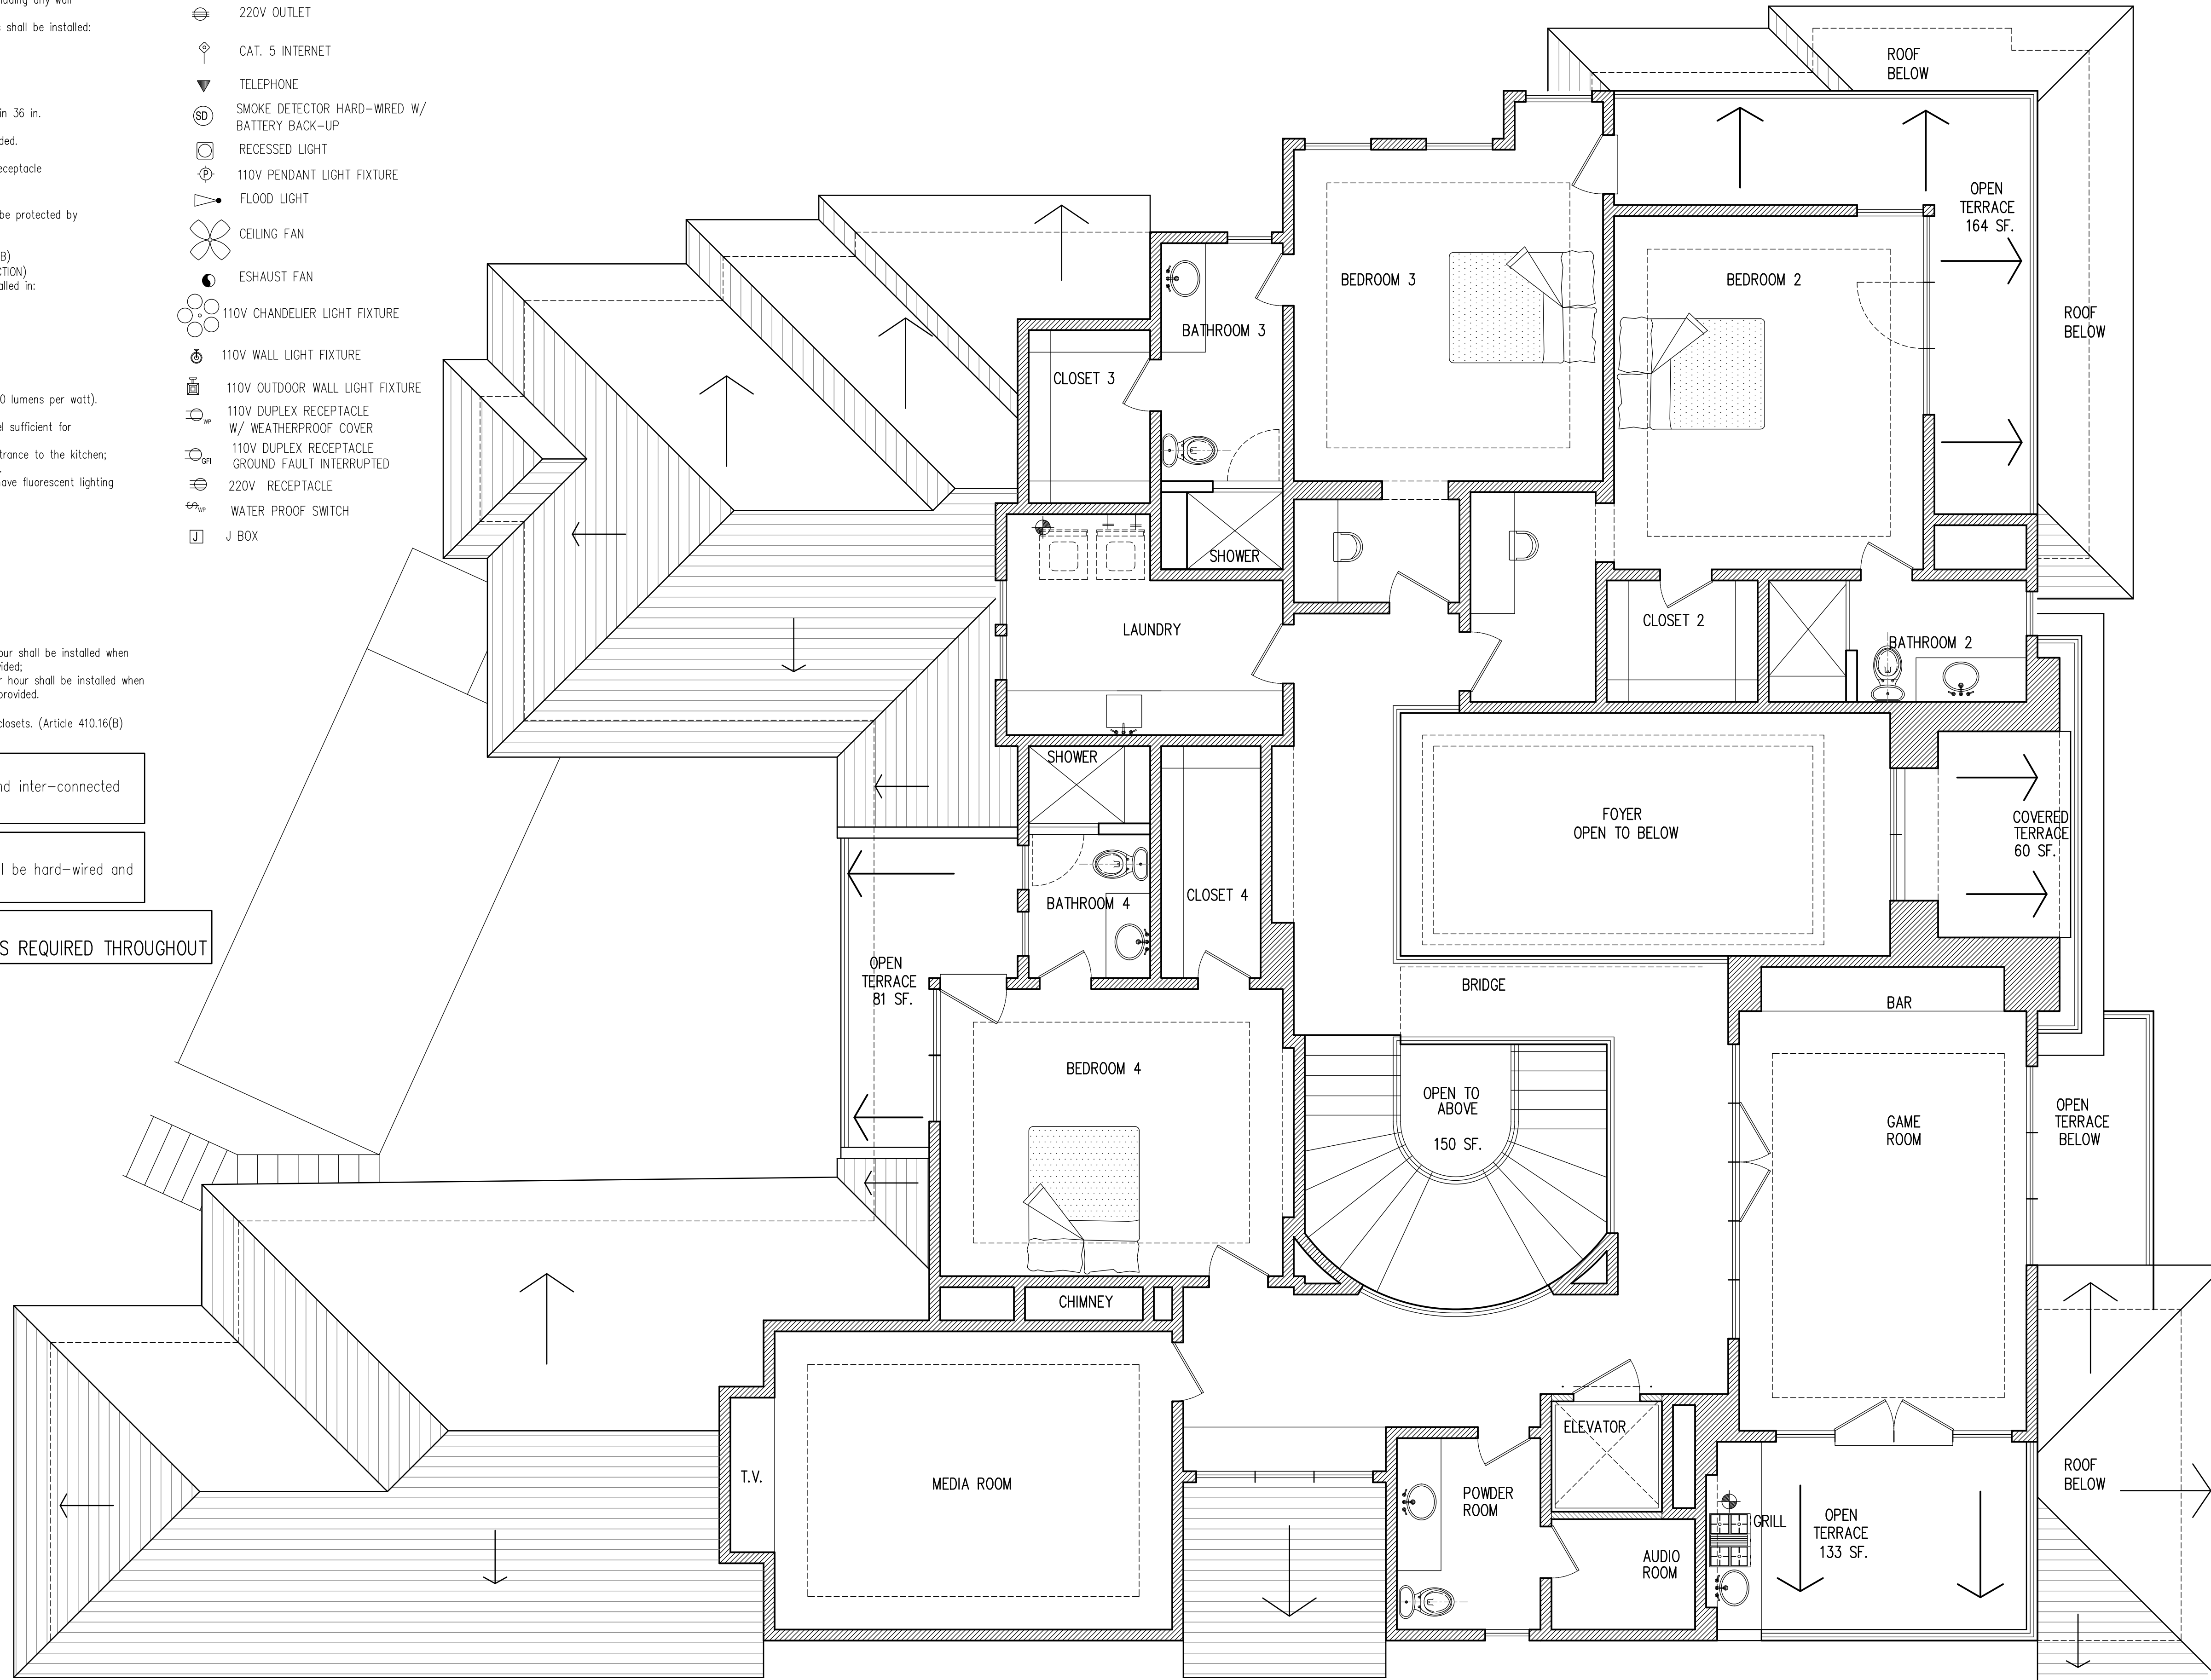

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ELECTRICAL PLAN