

DESCRIPTION

01 | 19-05-2021 | CITY OF HOUSTON

REVISIIONS:

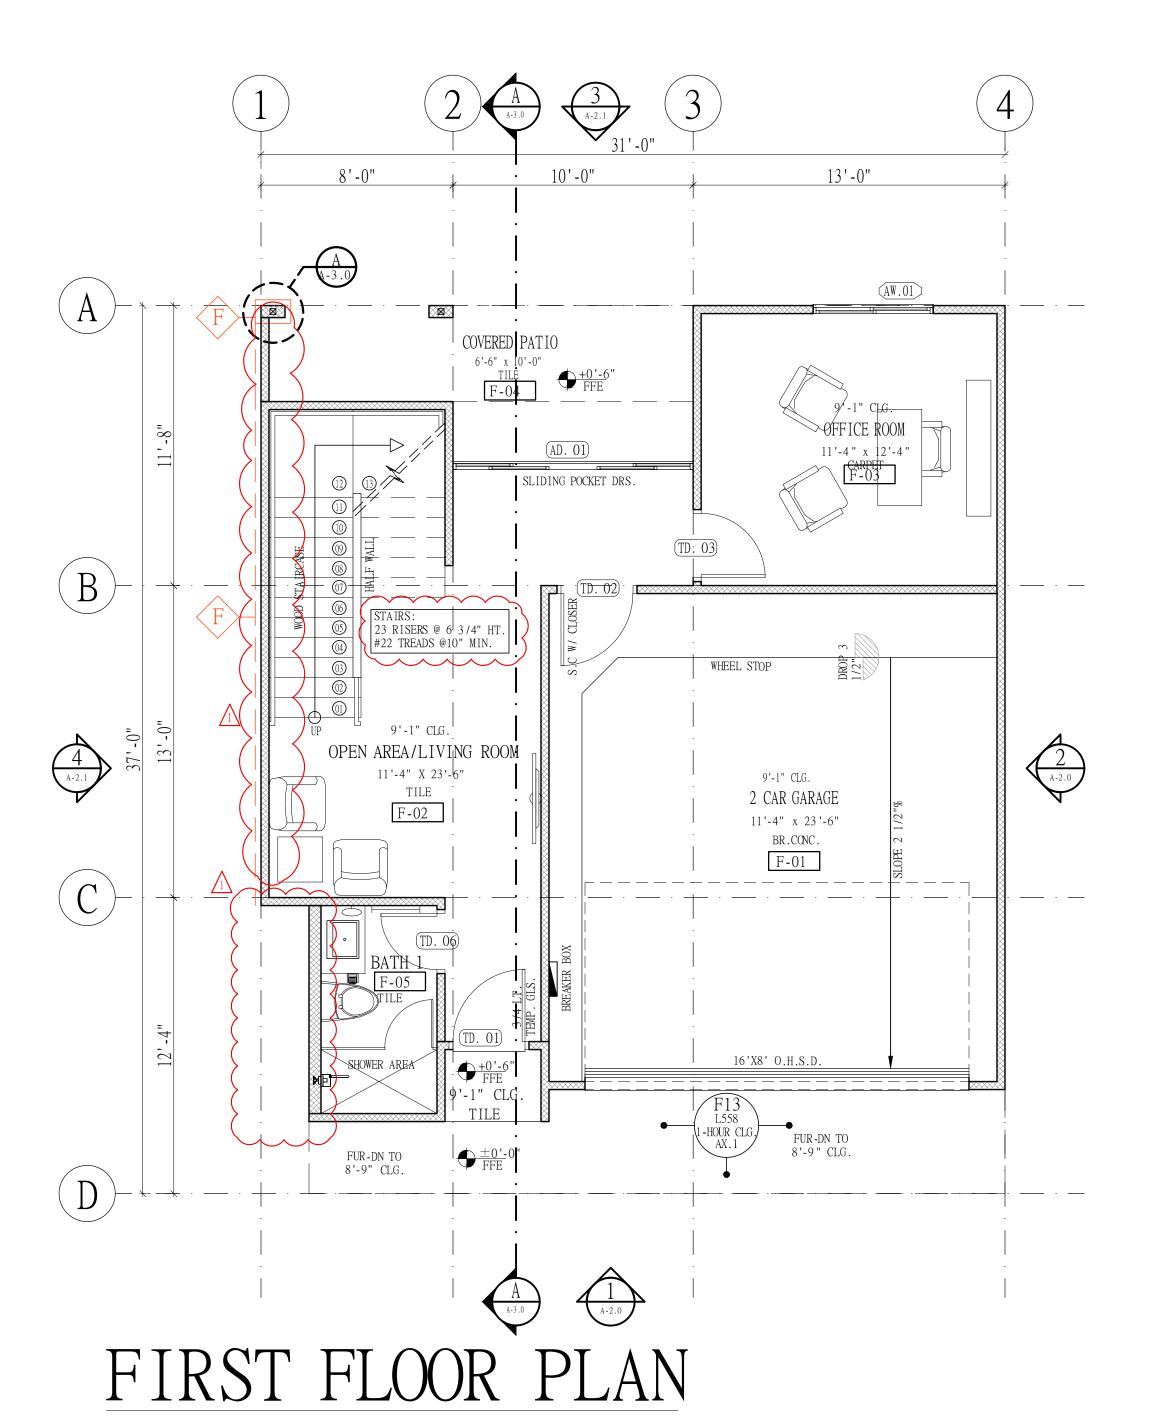

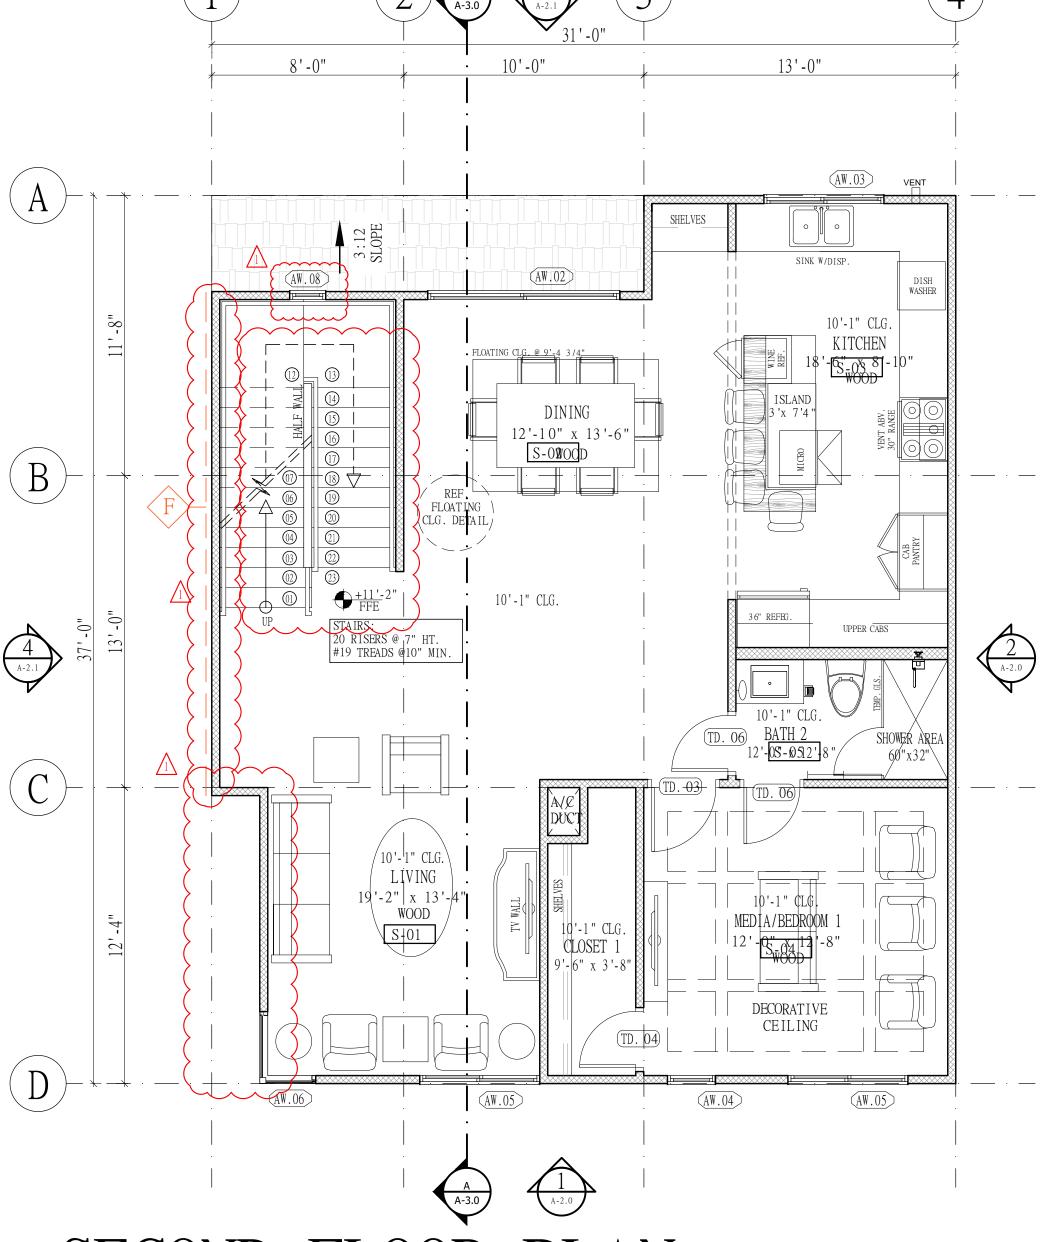

SECOND FLOOR PLAN

Scale: 1/4"=1'-0"

PLAN NOTES: REFERENCING THE 2012 IRC & CITY OF HOUSTON AMENDMENTS

Scale: 1/4"=1'-0"

MAKMO DESIGN- DESIGNWITH A DIFFERENT APPROACH:

1. ALL WRITTEN NOTES ON THESE DRAWINGS SHALL TAKE PRECEDENCE OVER THE MINIMUM STANDARD NOTES DETAILED ON THE LAST SHEET OF THESE DRAWINGS.

2. CEILING HEIGHTS TAKEN FROM WHERE THE NOTES IS LOCATED ON THE PLAN

3. ALL FLOOR DRAINS TO HAVE OVERFLOW PAN WITH RELIEF LINE TO OUTSIDE OR STORM SEWER (DO NOT CONNECT TO SANITARY SEWER) 4. PROVIDE PLUMBING ACCESS PANEL AT ALL BATHTUBS PER IRC 2012 SECT. P2704.1

5. ALL GLASS AT TUBS AND SHOWERS SHALL BE TEMPERED SAFETY GLASS AND TO COMPLY WITH IRC 2012 SECT. R308

6. SEE STAIR NOTES AND DETAILS - LAST SHEET. CONFIRM TO IRC 2012, SECTIONS R314, R315, R316 AND CITY OF HOUSTON AMMENDMENTS, SECTION 1003.3.311, EXCEPTION: PROVIDE CONTINUOUS RAILING WHEN THERE ARE FOUR OR MORE RISERS.

7. PROVIDE ATTIC ACCESS WITH A MINIMUM CLEAR OPENING OF 22"X30". PROVIDE MINIMUM HEAD CLEARENCE OF 30". WHERE SERVICING MECHANICAL EQUIPMENT, THE MINIMUM SIZE OF A PULL-DOWN STAIRS IS 30"X54", AND HAVE A MINIMUM LOAD CAPACITY OF 350 LBS. SEE IRC 2012 SECT. R807 AND SECT, M1305.1.3 8. LOCATE WATER HEATER(S) IN ATTIC ABOVE A LOAD BEARING PARTITION, IN A PAN, WITH A RELIEF LINE TO OUTSIDE OR STORM LINE INSTALLATION TO CONFIRM

WITH IRC 2012 SECT. P2803 9. LOCATE H.V.AC. EQUIPMENT IN ATTIC, OR IN DESIGNATED MECHANICAL ROOM.

10. PROVIDE 24" WIDE PLYWOOD WALKWAY TO ACCESS ALL MECHANICAL EQUIPMENT LOCATED IN ATTIC. MAXIMUM DISTANCE FROM ATTIC ACCESS TO EQUIPMENT SHALL

NOT EXCEED 20'-0". PROVIDE A 30" WIDE SERVICE PLATFORM AT SERVICE SIDE OF ALL EQUIPMENT IN ATTIC

11.ALL INSULATION SHALL HAVE A FLAME SPREAD RATING NOT OT EXCEED 75 AND A SMOKE DENSITY RATING NOT TO EXCEED 450. SEE IRC 2012 SECT. R316.3. 12. PROVIDE ADEQUATE FURRING SO VENT AND SOIL PIPES DO NOT PENETRATE PLATES. ALL PLUMBING VENTS SHALL EXIST THROUGH A ROOF PLANE THAT SLOPES TO THE BACK.

BATHROOM SYMBOLS

----- TOWEL BAR

TOWEL RING

FIREWALL NOTE:

5/8" SHEETROCK TO BE INSTALLED BEFORE BUILDING STAIR STRINGER OR TUB INSTALL

- PROVIDE 5/8" TYPE 'X' GYPSUM BOARD TO THE GARAGE (& CARPORT) SIDE OF STUDS AND JOISTS.
- PROVIDE 5/8" TYPE 'X' GYPSUM BOARD TO ENCLOSED AREAS LOCATED UNDER ALL
- DOOR, SOLID OR HONEYCOMB STEEL DOOR 1-3/8 IN. THICK, OR 20 MIN. FIRE RATED DOOR WITH SELF CLOSING HARDWARE FROM GARAGE AREA TOO CONDITIONED AREA. R302.5.1

NEEDS TO BE STEEL, COPPER, IRON PIPE OR CONDUIT WITH THE ANNULAR SPACE AROUND THE PENETRATION FILLED WITH AN APPROVED FIRE-CAULK.

CEILINGS

WALL CLOSETS

CABINETS
UPPER CABINET
COUNTER TOP

DOUBLE ROD & SHELF

AC CHASE

SQUARE FOOTAGES FIRST FLOOR: 508 2 X 4 WALLS PORTE COCHERE/PORCH: 110 2-2 X 4 WALLS GARAGE: 393 2 X 6 WALLS APPLIED BRICK/STONE 1051 SECOND FLOOR: DESIGNATION FOR CHASE ABOVE 1051 THIRD FLOOR: DESIGNATION FOR CHASE ABOVE TOTAL LIVING: 2610 S.F SINGLE ROD & SHELF

NOTE; - ANY PLUMBING OR MECHANICL FIXTURES

000 BALCONIES: TOTAL COVER: 3113 S.F

TOWN ∞

ASHLEY BICE

	21.
DATE:	11/06/20
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PROJECT NUMBER	:	20-037
SCALE	:	1/4''=1'-0
DRAWNBY	:	A.Z
CHECKEDBY	:	A.Z
SHEET TITLE	:	

1st & 2nd **FLOOR PLAN**

DRAWING NUMBER: A-1.1

ABBREVIATIONS BR. CONC. BRUSHED CONCRETE CASED OPENING

CSMNT. CASEMENT WINDOW D.B. DROP BEAM D.H. DOUBLE HUNG WINDOW FX. FIXED WINDOW HOSE BIB

HDR. HEADER HEADER HEIGHT MAGAZINE RACK MEDICINE CABINET OVER HUNG

SOLID CORE DOOR SINGLE HUNG WINDOW SHEET ROCK OPENING RETURN AIR RAIN HEAD FIXTURE


HDR. HT. S.H.

UNLESS NOTED OTHERWISE

R.H. U.N.O

M.C. О.Н. O.H.S.D. OVER HEAD SECTIONAL DOOR

- INSTALL MINIMUM 1-3/8 IN. SOLID CORE

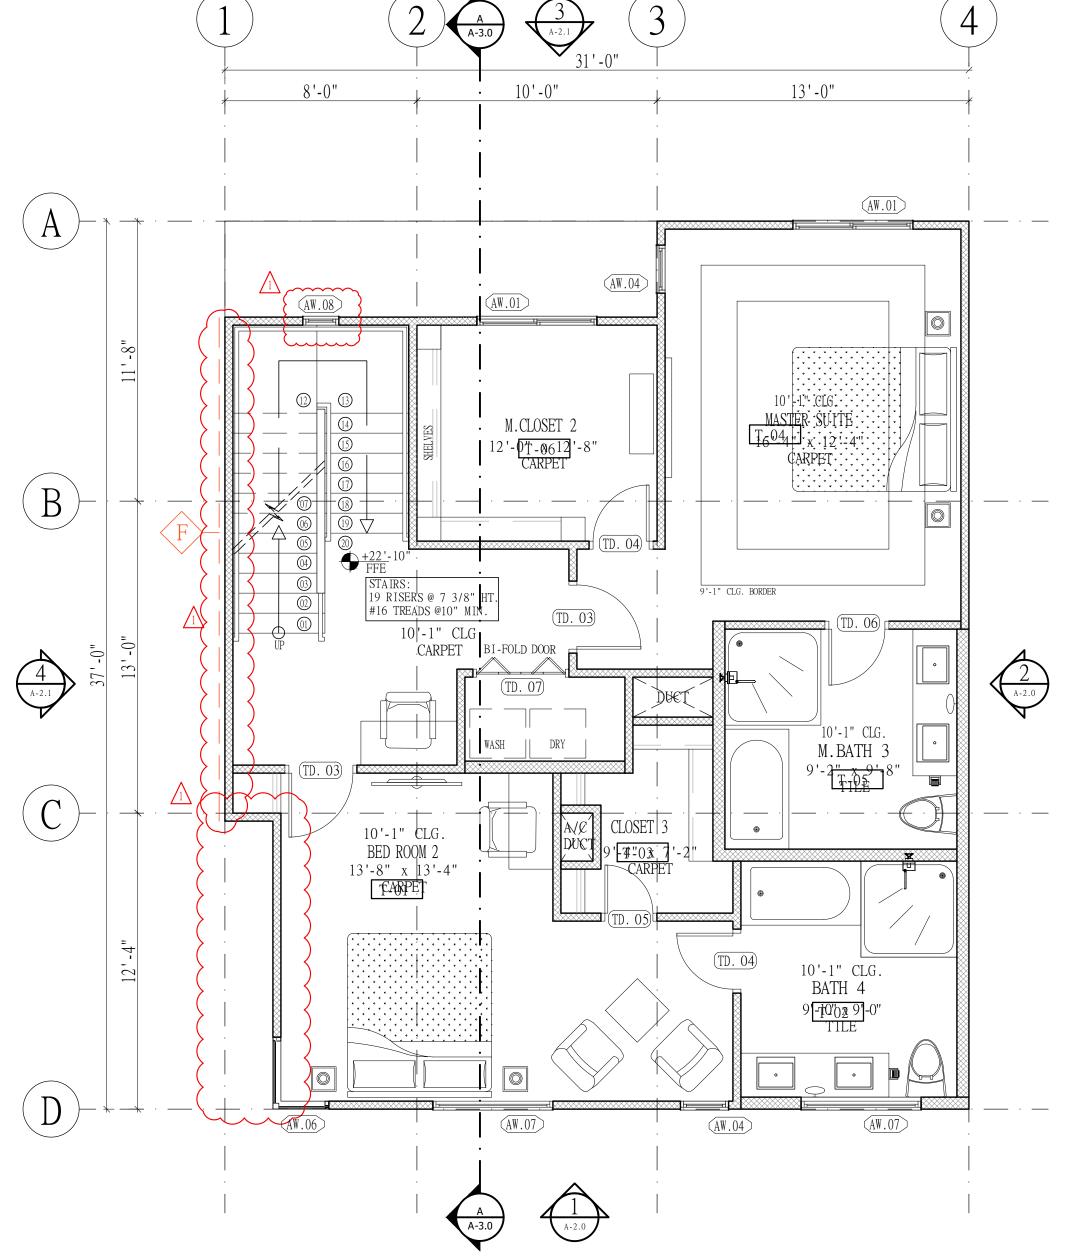

THIRD FLOOR PLAN


Scale: 1/4"=1'-0"

33'-5" PL.HT • OPEN TERRACE +34'-6" FFE

ROOF FLOOR PLAN

Scale: 1/4"=1'-0"

FLOATING CEILING DETAIL

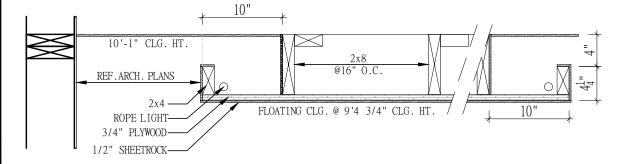

FLOATING CEILING EXAMPLE ISLAND DETAIL

EGRESS REQUIREMENTS

R310.1 IRC 2012 EMERGENCY ESCAPE AND RESCUE REQUIRED

BASEMENTS W/ HABITABLE SPACE AND EVERY SLEEPING ROOM SHALL HAVE ATLEAST ONE OPENABLE EMERGENCY ESCAPE AND RESCUE WINDOW OR EXTERIOR DOOR OPENING FOR EMERGENCY ESCAPE AND RESCUE. WHERE OPENINGS ARE PROVIDED AS A MEANS OF ESCAPE AND RESCUE, THEY SHALL HAVE A SILL HEIGHT OF NOT MORE THAN 44 INCHES (1118mm) ABOVE THE FLOOR. R310.1.1 IRC 2012 MINIMUM OPENING AREA

ALL EMERGENCY ESCAPE AND RESCUE OPENING SHALL HAVE A MINIMUM NET CLEAR OPENING OF 5.7 SQ.FT. EXCEPTION: GRADE FLOOR OPENINGS SHALL HAVE A MINIMUM NET CLEAR OPENING OF 5 SQUARE FEET.

R310.1.2 IRC 2012 MINIMUM OPENING HEIGHT
THE MINIMUM NET CLEAR OPENING HEIGHT SHALL BE 24 INCHES (610 mm).

R310.1.3 IRC 2012 MINIMUM OPENING WIDTH

THE MINIMUM NET CLEAR OPENING WIDTH SHALL BE 20 INCHES (508 mm). R310.1.4 IRC 2012 OPERATIONAL CONSTRAINTS

EMERGENCY ESCAPE AND RESCUE OPENINGS SHALL BE OPERATIONAL FROM THE INSIDE OF THE ROOM WITHOUT THE USE OF KEYS OR TOOLS

WINDOW SILLS R313.2 IRC 2012

In dwelling units, where the opening of an operable window is located more than 72 inches above the finished grade or surface below, the lowest part of the clear opening of the window shall be a height not less than 24 inches above the finished floor surface of the ROOM IN WHICH THE WINDOW IS LOCTED.

DIRECT VENT TERMINATION

EXCEPT A PUBLIC WAY.

PER SECTION 806.6.1 OF THE 1997 I.C.B.O.
MECHANICAL CODE. VENTING SYSTEMS SHALL
TERMINATE AT LEAST 3 FEET ABOVE AN OUTSIDEOR MAKEUP - AIR INLET LOCATED WITHIN 10 FEET
AND AT LEAST 4 FEET FROM A PROPERTY LINE

EXCEPTION: VENT TERMINATIONS OF DIRECT VENT APPLIANCES WITH INPUTS NOT EXCEEDING 50,000 BTU/H SHALL BE PERMITED TO TERMINATE AT LEAST 2 FEET FROM A PROPERTY LINE EXCEPT A PUBLIC WAY.

EFFECTIVE DATE: 24 AUGUST 2000 - CITY OF HOUSTON PLANNING & DEVELOPMENT MECHANICAL SECTION POLICY & PROCEDURE.

<u>GLAZING NOTE:</u>

GLAZING (HAZARDOUS LOCATION) R308.4 2012 IRC.

HAZARDOUS LOCATION FOR GLAZING SHALL COMPLY WITH SECTION R308.4 OF THE 2012 IRC. USE SAFETY GLASS IN THESE LOCATIONS: FRENCH DOOR, BATHTUB ENCLOSURES, SHOWER DOORS, LARGE GLASS AREAS AND SUCH. SEE GLAZING NOTES ON PLANS OR DETAIL SHEET.

WINDOW MANUFACTURER TO VERIFY ALL TEMPERED GLASS LOCATIONS

TEMPERED WINDOWS MUST BE INSTALLED IN THE FOLLOWING LOCATIONS:

- WITHIN 24" OF AN DOOR
 WITHIN 60" OF A STAIR LANDING
- . WITHIN 60" OF A STAIR LANDING / TREAD
 . WITHIN 60" OF BOTTOM OF TUB OR SHOWER
- REQUIRED FOR WALK-THRU HAZARD WHEN ALL 4 EXISTS:
 (1) > 9 s.f., (2) LOWER EDGE < 18 in. ABOVE

SURFACE, (3) UPPER EDGE > 36 in. ABOVE WALKING SURFACE & (4) WITHIN 36 in. HORIZONTAL WALKING

BATHTUB & SHOWERS

BATHTUB AND SHOWER FLOORS AND WALLS ABOVE BATHTUBS WITH INSTALLED SHOWER HEADS AND IN SHOWER COMPARTMENTS SHALL BE FINISHED WITH A NONABSORBENT SURFACE. SUCH WALL SURFACE SHALL EXTEND TO A HEIGHT NOT LESS THAN 6 FT. ABOVE THE FLOOR. R307.2 IRC 2012

GUARDRAIL NOTE:

DESIGN LOAD TABLE R301.5 AND FOOTNOTE D, 2012 IRC. HANDRAIL & GUARDRAILS SHALL BE DESIGNED FOR A MINIMUM 200 LB LIVE LOAD AND A SINGLE CONCENTRATED LOAD APPLIED IN ANY DIRECTION AT ANY POINT ALONG THE TOP.

WATER HEATER NOTE

WATER HEATER LOCATED IN ATTIC, UNLESS NOTED OTHERWISE.

ATTIC ACCESS

ATTICS CONTAINING APPLIANCES SHALL BE PROVIDED WITH A PULL DOWN STAIRWAY WITH A CLEAR OPENING NOT LESS THAN 22 INCHES IN WIDTH AND A LOAD CAPACITY OF NOT LESS THAN 350 POUNDS.

NOTE; - ANY PLUMBING OR MECHANICL FIXTURES NEEDS TO BE STEEL, COPPER, IRON PIPE OR CONDUIT WITH THE ANNULAR SPACE AROUND THE PENETRATION FILLED WITH AN APPROVED FIRE-CAULK.

REVISIONS:


NO. DATE DESCRIPTION

01 19-05-2021 CITY OF HOUSTON

FOR INTER REVIEW ONLY

CONSTRUCTION SET

BID ONLY PERMITS SET

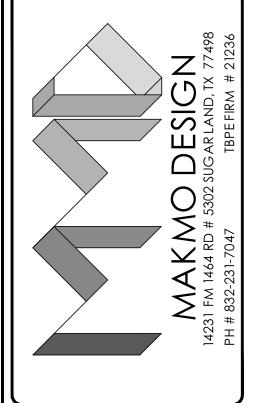

288 TOWN HOUSE -1
LOCATED AT
LOCATED AT
TW 770

ASHLEY BICE

ASHLEY BICE

134060

CENSE

DNALL

13 23

ATE: 11/06/2021

PROJECT NUMBER : 20-037

SCALE : 1/4"=1'-0"


DRAWN BY : A.Z

CHECKED BY : A.Z

SHEET TITLE :

3rd & ROOF FLOOR PLAN

DRAWING NUMBER: A-1.2

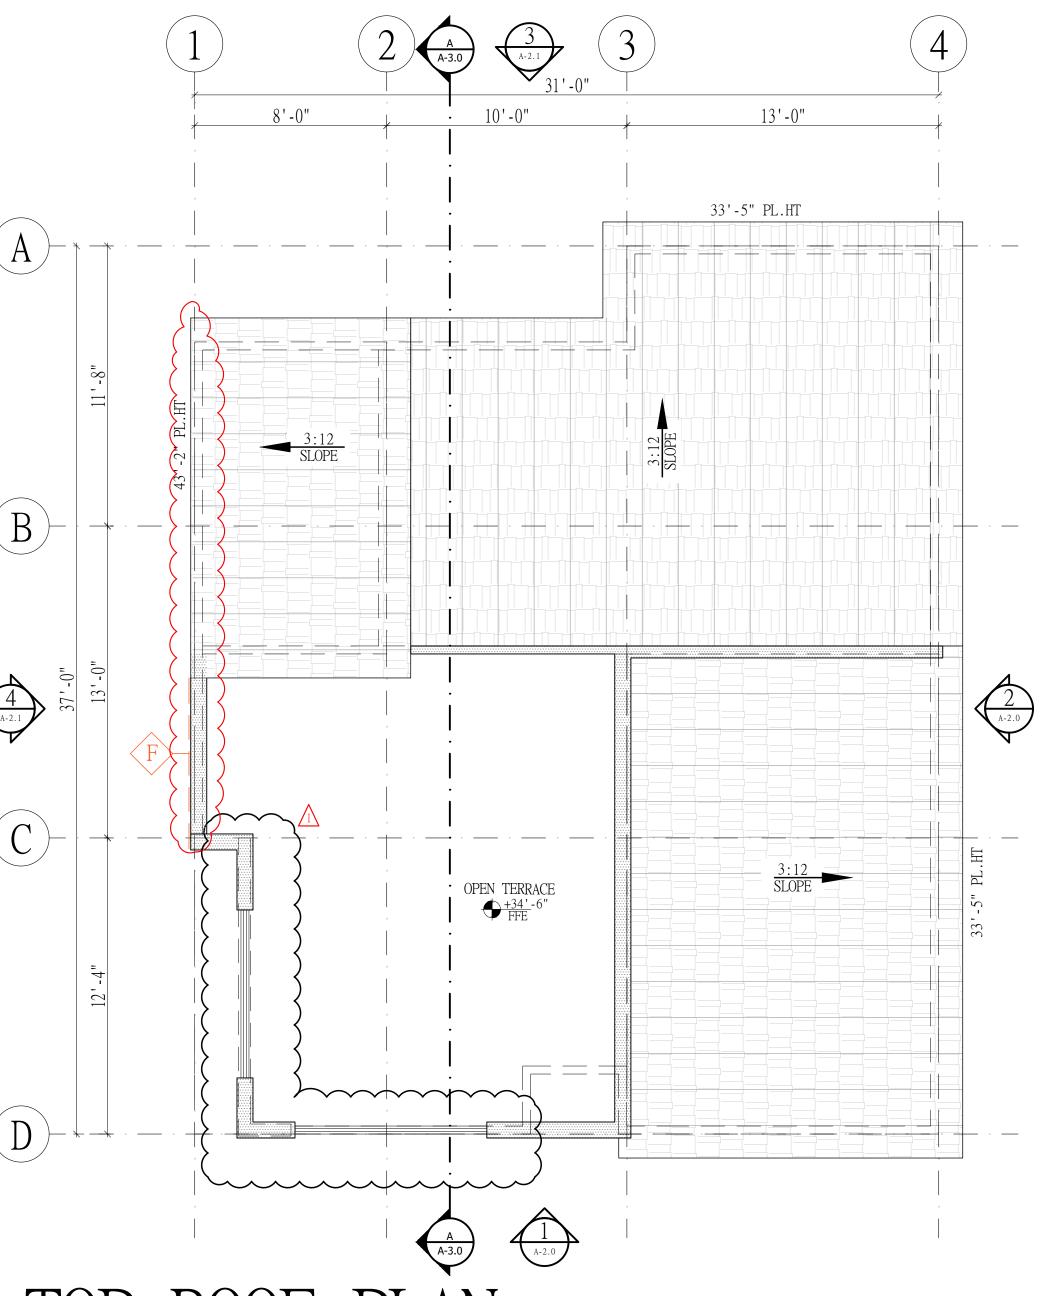

TOP ROOF PLAN

Scale: 1/4"=1'-0"

<u>LEGEND</u>

MAKMO DESIGN - DESIGN WITH A DIFFERENT APPROACH —

PARAPET WALLS
RAFTER LAYOUT
WALL BELOW

WALL BELOW

VERTICAL SUPPORT
RIDGE/HIP/VALLEY

ROOF NOTES
PLATE HEIGHTS AS NOTED
SLOPES AS NOTED

SLOPES AS NOTED

12" OVERHANGS FROM FRAME U.N.O.

SOFFIT & RIDGE VENTING PER BUILDER SPECS.

COMPOSITION SHINGLES ROOF MATERIAL

PLUMBING VENTS & ALL OTHER PENETRATIONS

THROUGH ROOF DECKING SHALL BE DIRECTED

TO BACK ROOF SLOPE

TO BACK ROOF SLOPE
MINIMIZE PLUMBING VENT PENETRATIONS THROUGH
ROOF DECKING.
COLOR COORDINATE PIPING TO ROOF MATERIAL
WHERE APPLICABLE.

<u>ABBREVIATIONS</u>

A.F.F ABOVE FINISHED FLOOR
CSMNT. CASEMENT WINDOW
D.H. DOUBLE HUNG WINDOW
E.J EXPANSION JOINT
FX. FIXED WINDOW
HDR. HEADER
HDR.HT. HEADER HEIGHT
O.H.S.D OVER HEAD SECTIONAL DOOR
PL.HT. PLATE HEIGHT
S.H. SINGLE HUNG WINDOW


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FOR INTER REVIEW ONLY
BID ONLY
PERMITS SET
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ı	NO.	DATE	DESCRIPTION	
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2012 Blodgett St Houston, TX 770

SEAL :

ASHLEY BICE

134060
CENSE

OA/04/2023

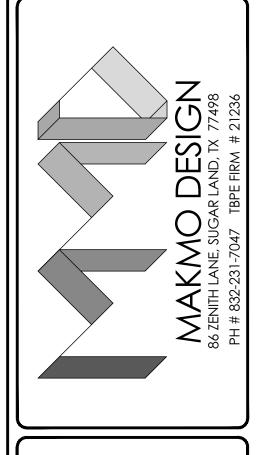PROJECT NUMBER : 20-037

SCALE : 1/4"=1'-0"

DRAWN BY : R.R.

CHECKED BY : A.Z

SHEET TITLE :

TOP ROOF PLAN

DRAWING NUMBER:

A-1.3