

**INGRAM RESIDENCE**  
 STEPHEN & TAMARA INGRAM  
 3702 S.H. 75 N.  
 HUNTSVILLE, TX 77340  
 WALKER COUNTY


PROJECT:  
 THIS PLAN AND THE ARCHITECTURAL WORKS REPRESENTED HEREIN ARE THE SOLE PROPERTY OF MARTINEZ & ASSOCIATES. THEY MAY NOT BE REPRODUCED, MODIFIED, OR OTHERWISE USED WITHOUT EXPRESS PERMISSION. UNLESS OTHERWISE SPECIFIED, ALL DIMENSIONS ARE IN FEET AND INCHES. THIS PLAN MAY NOT BE REUSED, IN WHOLE OR IN PART, TO BUILD OR REPAIR, TO BUILD ANY OTHER STRUCTURE, OR ANY OTHER SITE, WITHOUT THE EXPRESS WRITTEN PERMISSION OF MARTINEZ & ASSOCIATES.

DATE: 08/26/2018    DRAWN BY: SJ  
 SCALE: 3/16" = 1'-0"    CHECKED: DM

REVISIONS:  
 03/01/2019    PERMIT SET


EXTERIOR ELEVATIONS  
 GARAGE

# AC2.1

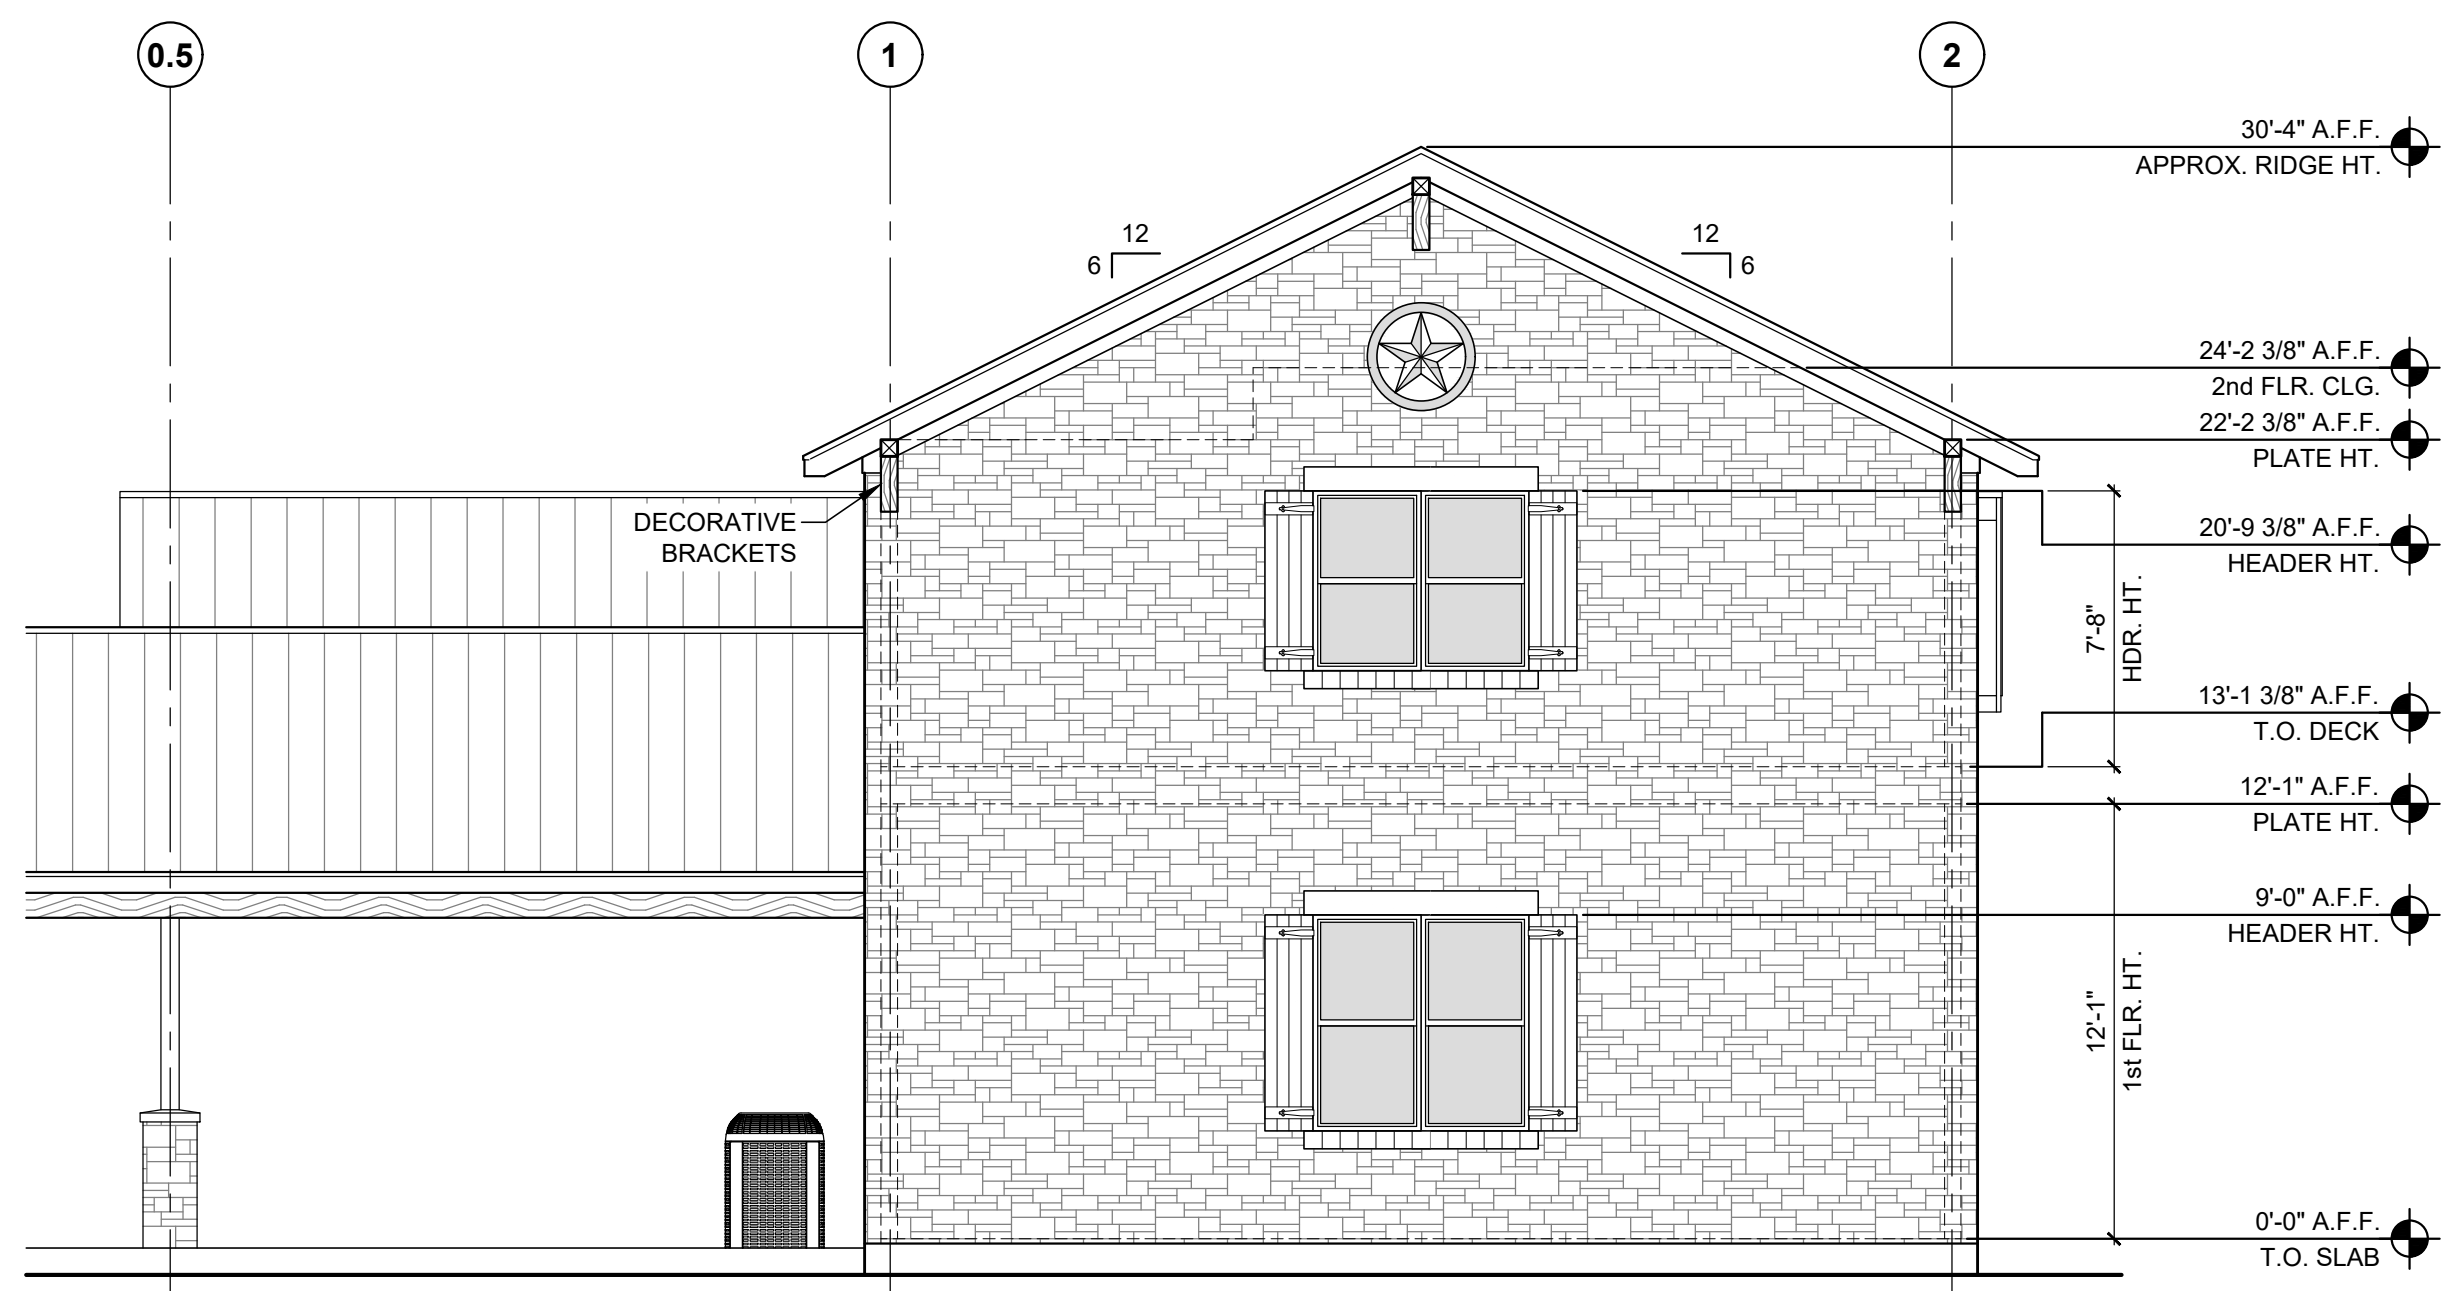


**1 GARAGE ELEVATION - FRONT**

SCALE: 3/16" = 1'-0"

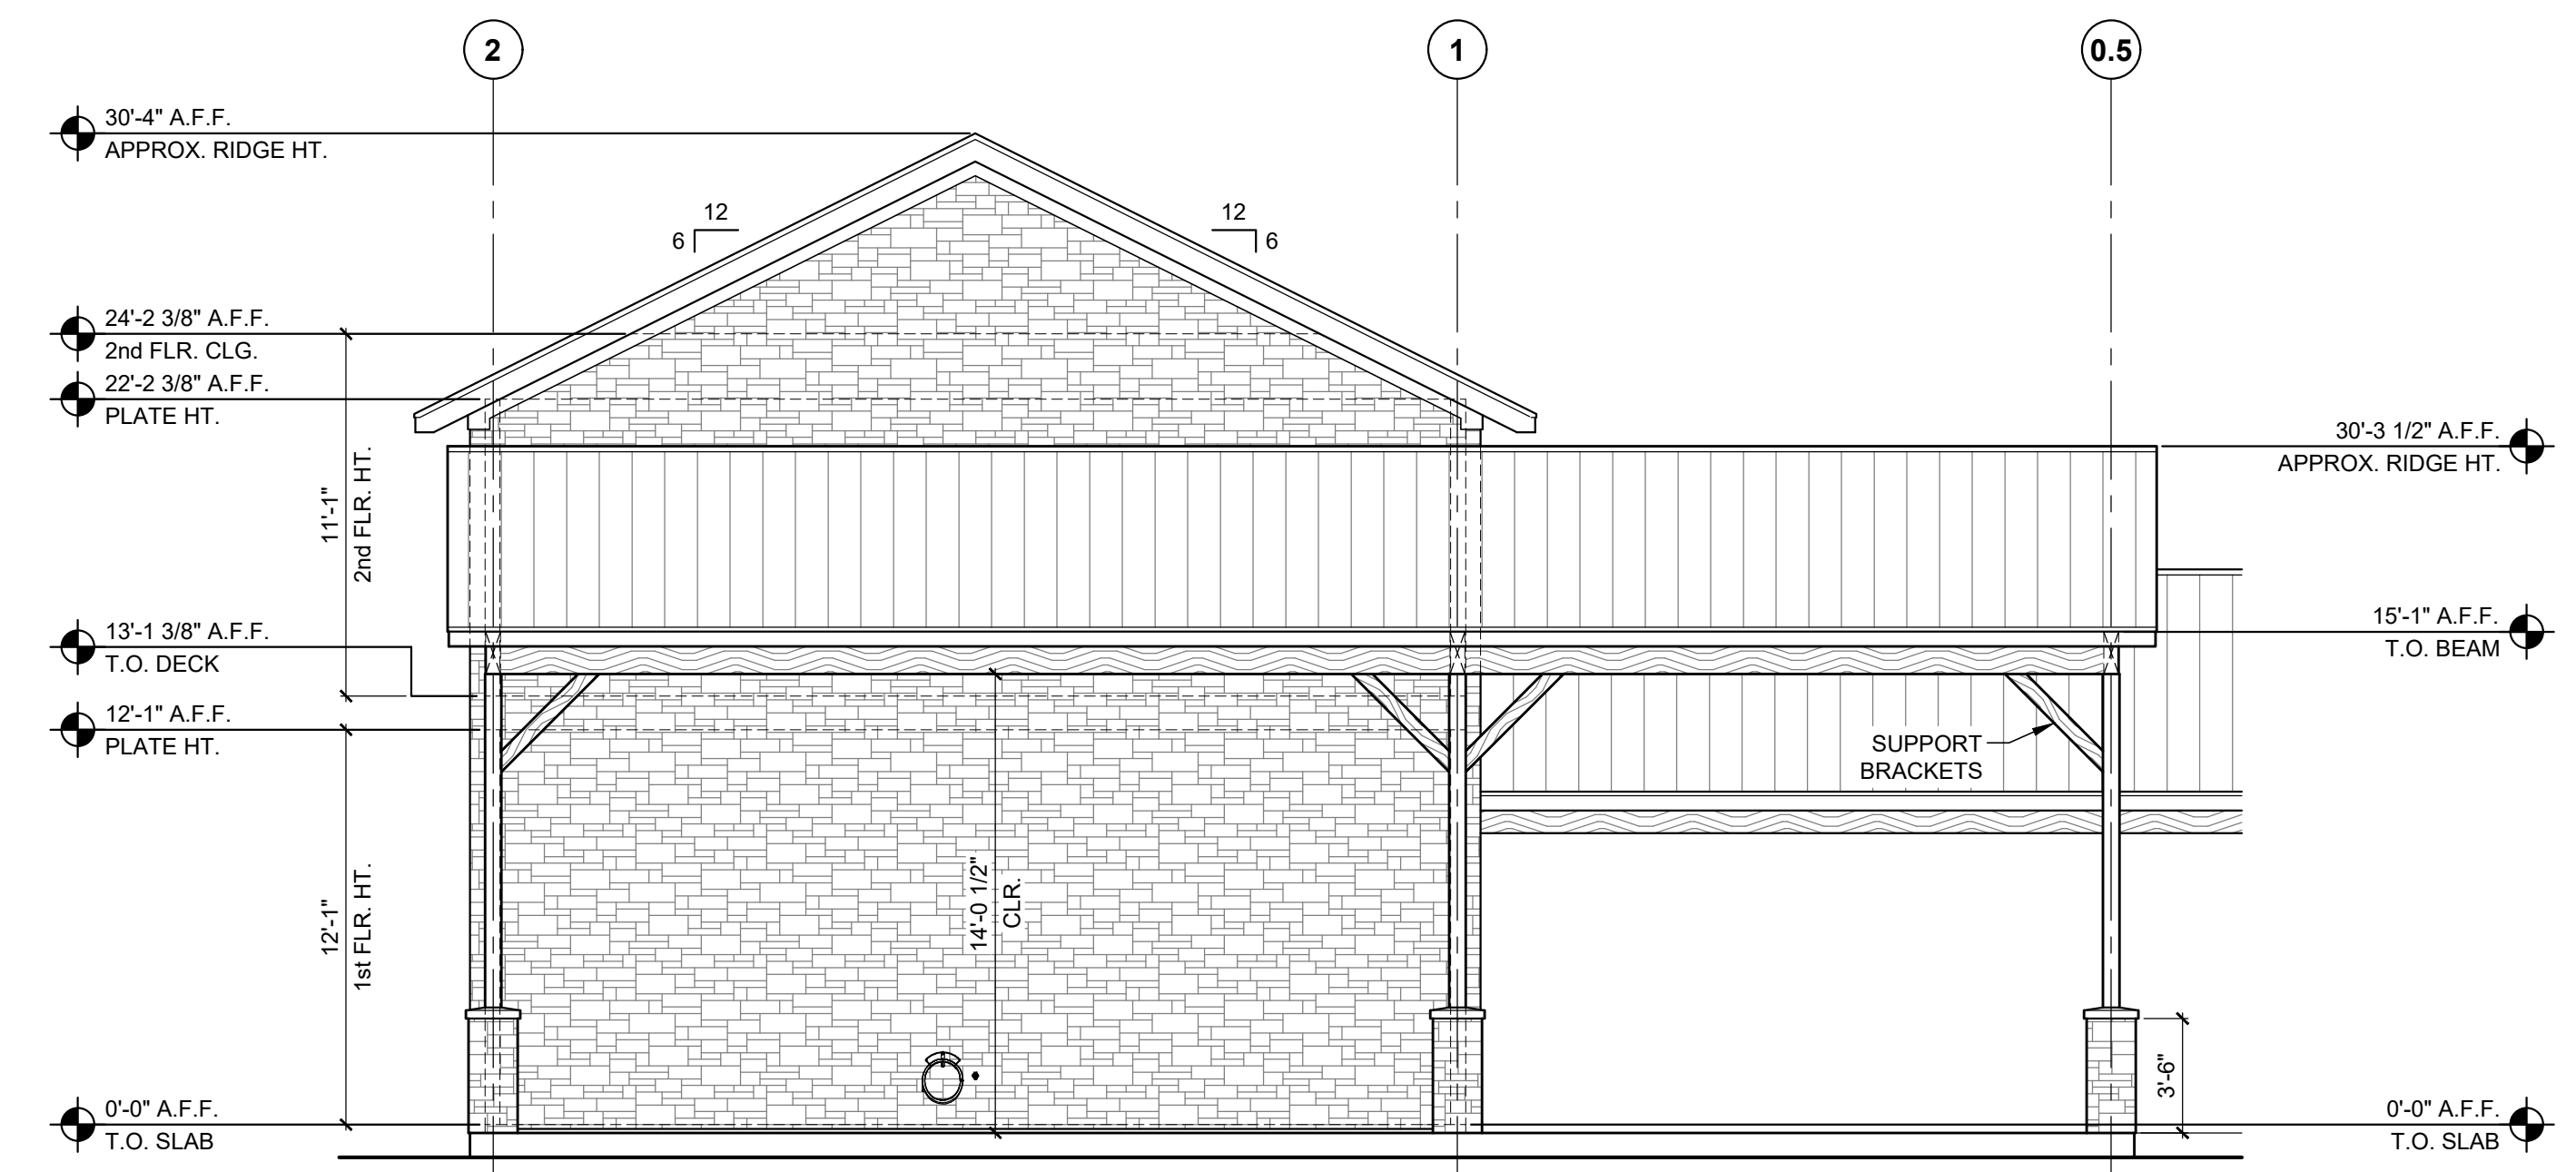


**2 GARAGE ELEVATION - BACK**

SCALE: 3/16" = 1'-0"

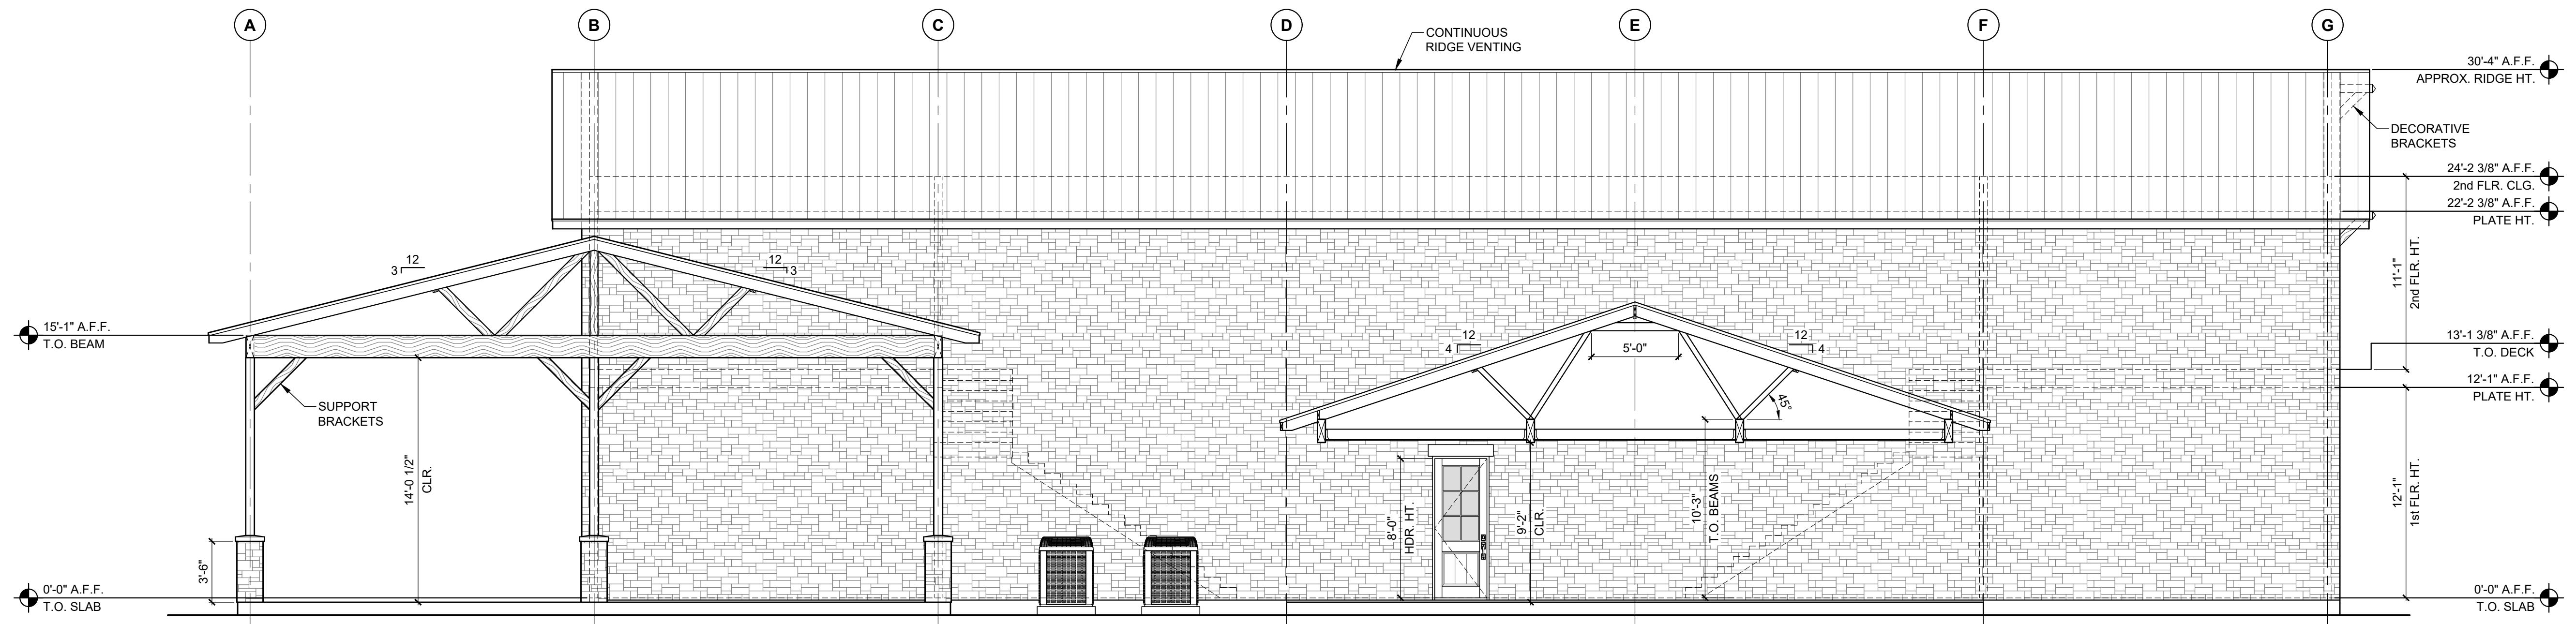


**3 GARAGE ELEVATION - LEFT**

SCALE: 3/16" = 1'-0"


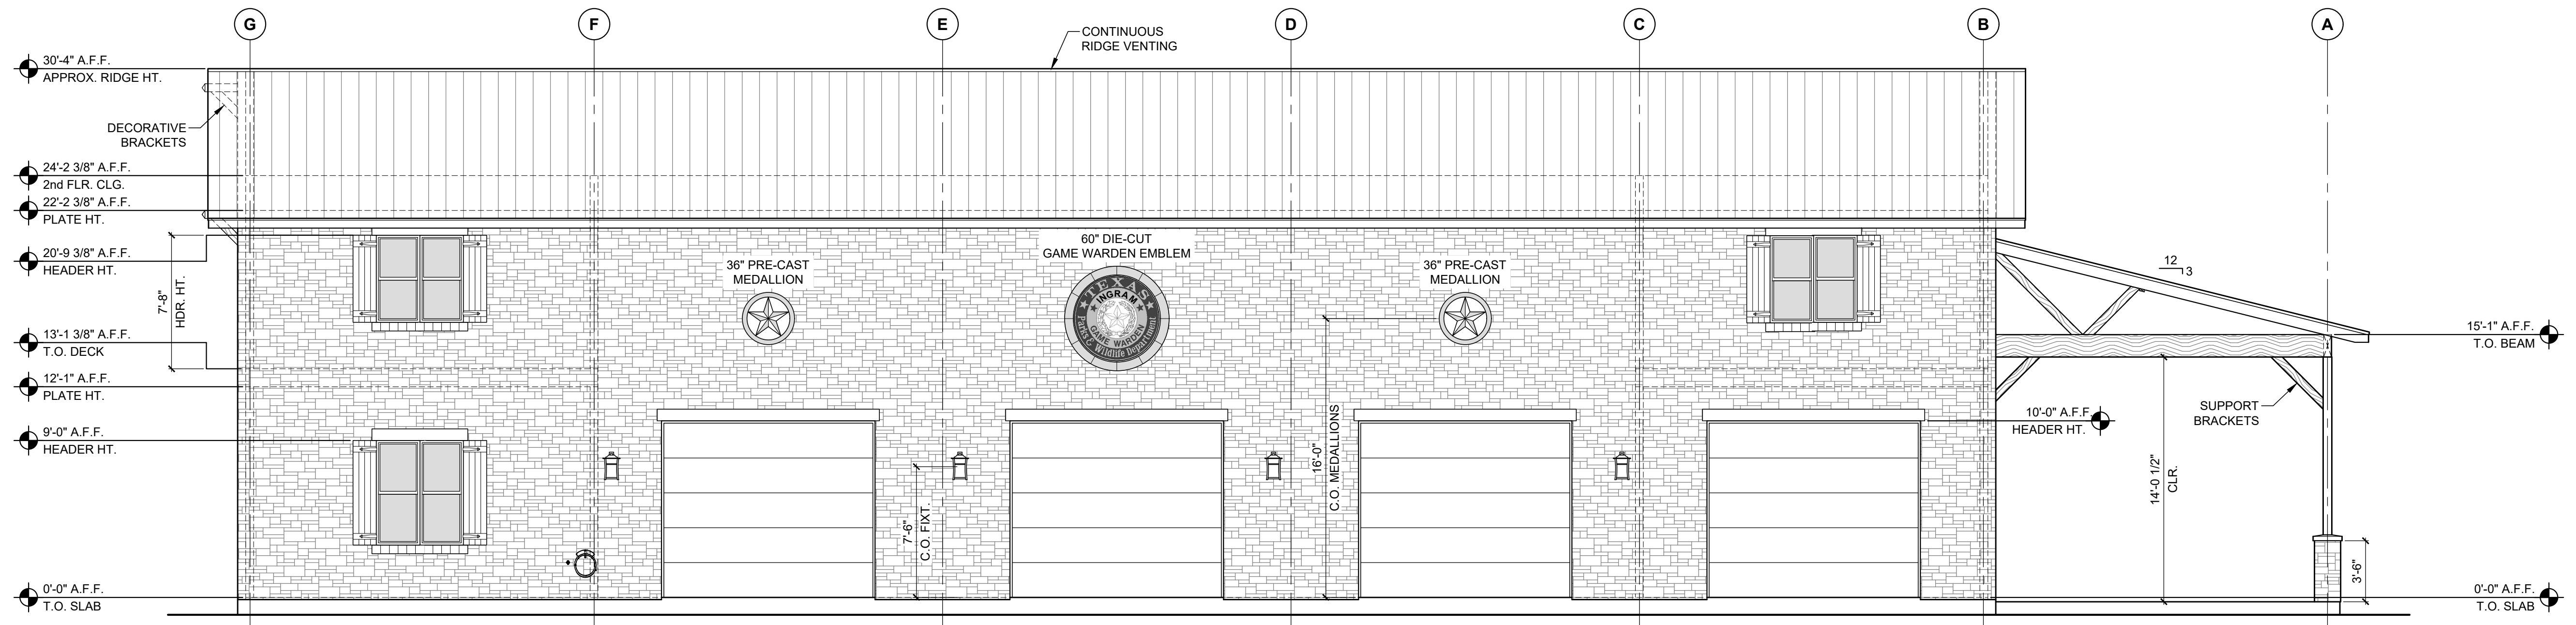


**4 GARAGE ELEVATION - RIGHT**

SCALE: 3/16" = 1'-0"

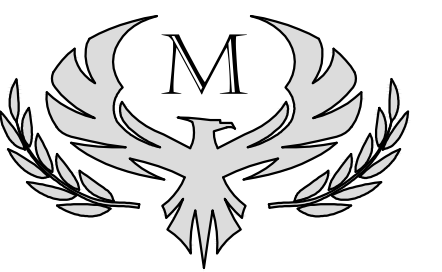

**DON MARTINEZ & ASSOCIATES**  
 OFFICE: (936) 439-5168  
 CELL: (936) 577-6761

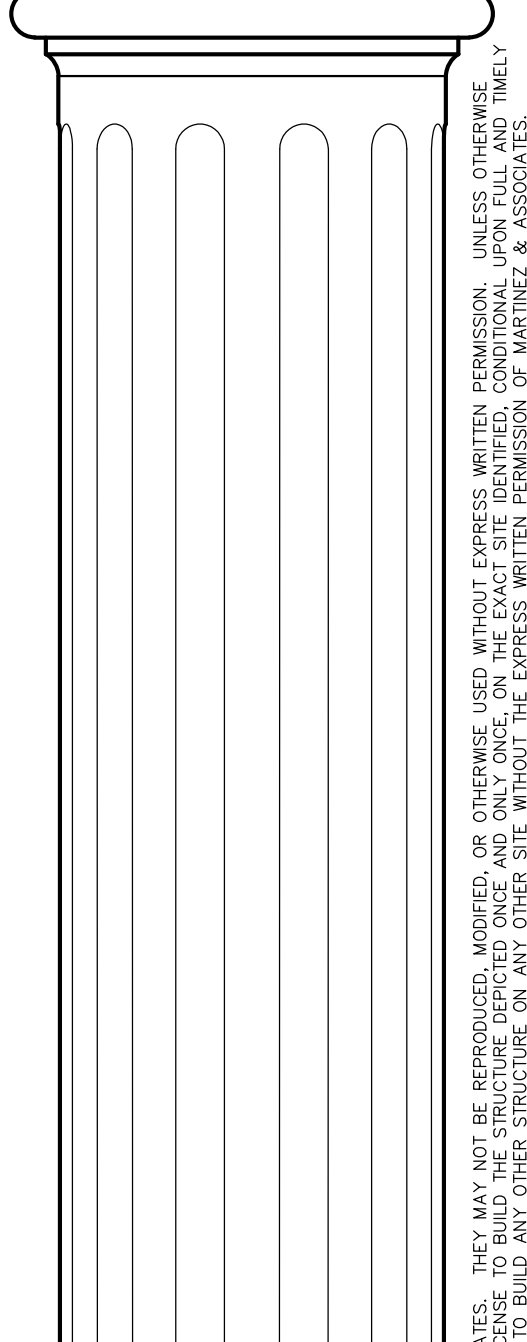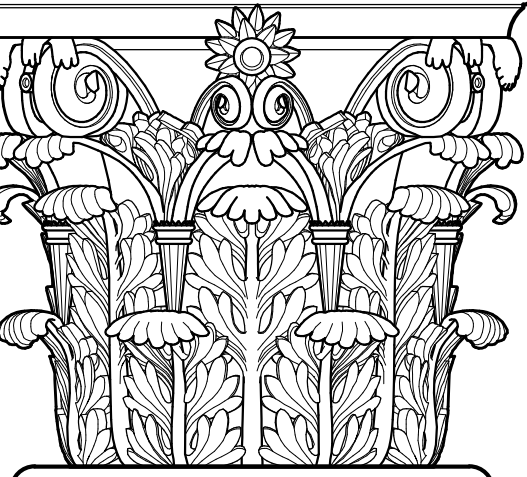

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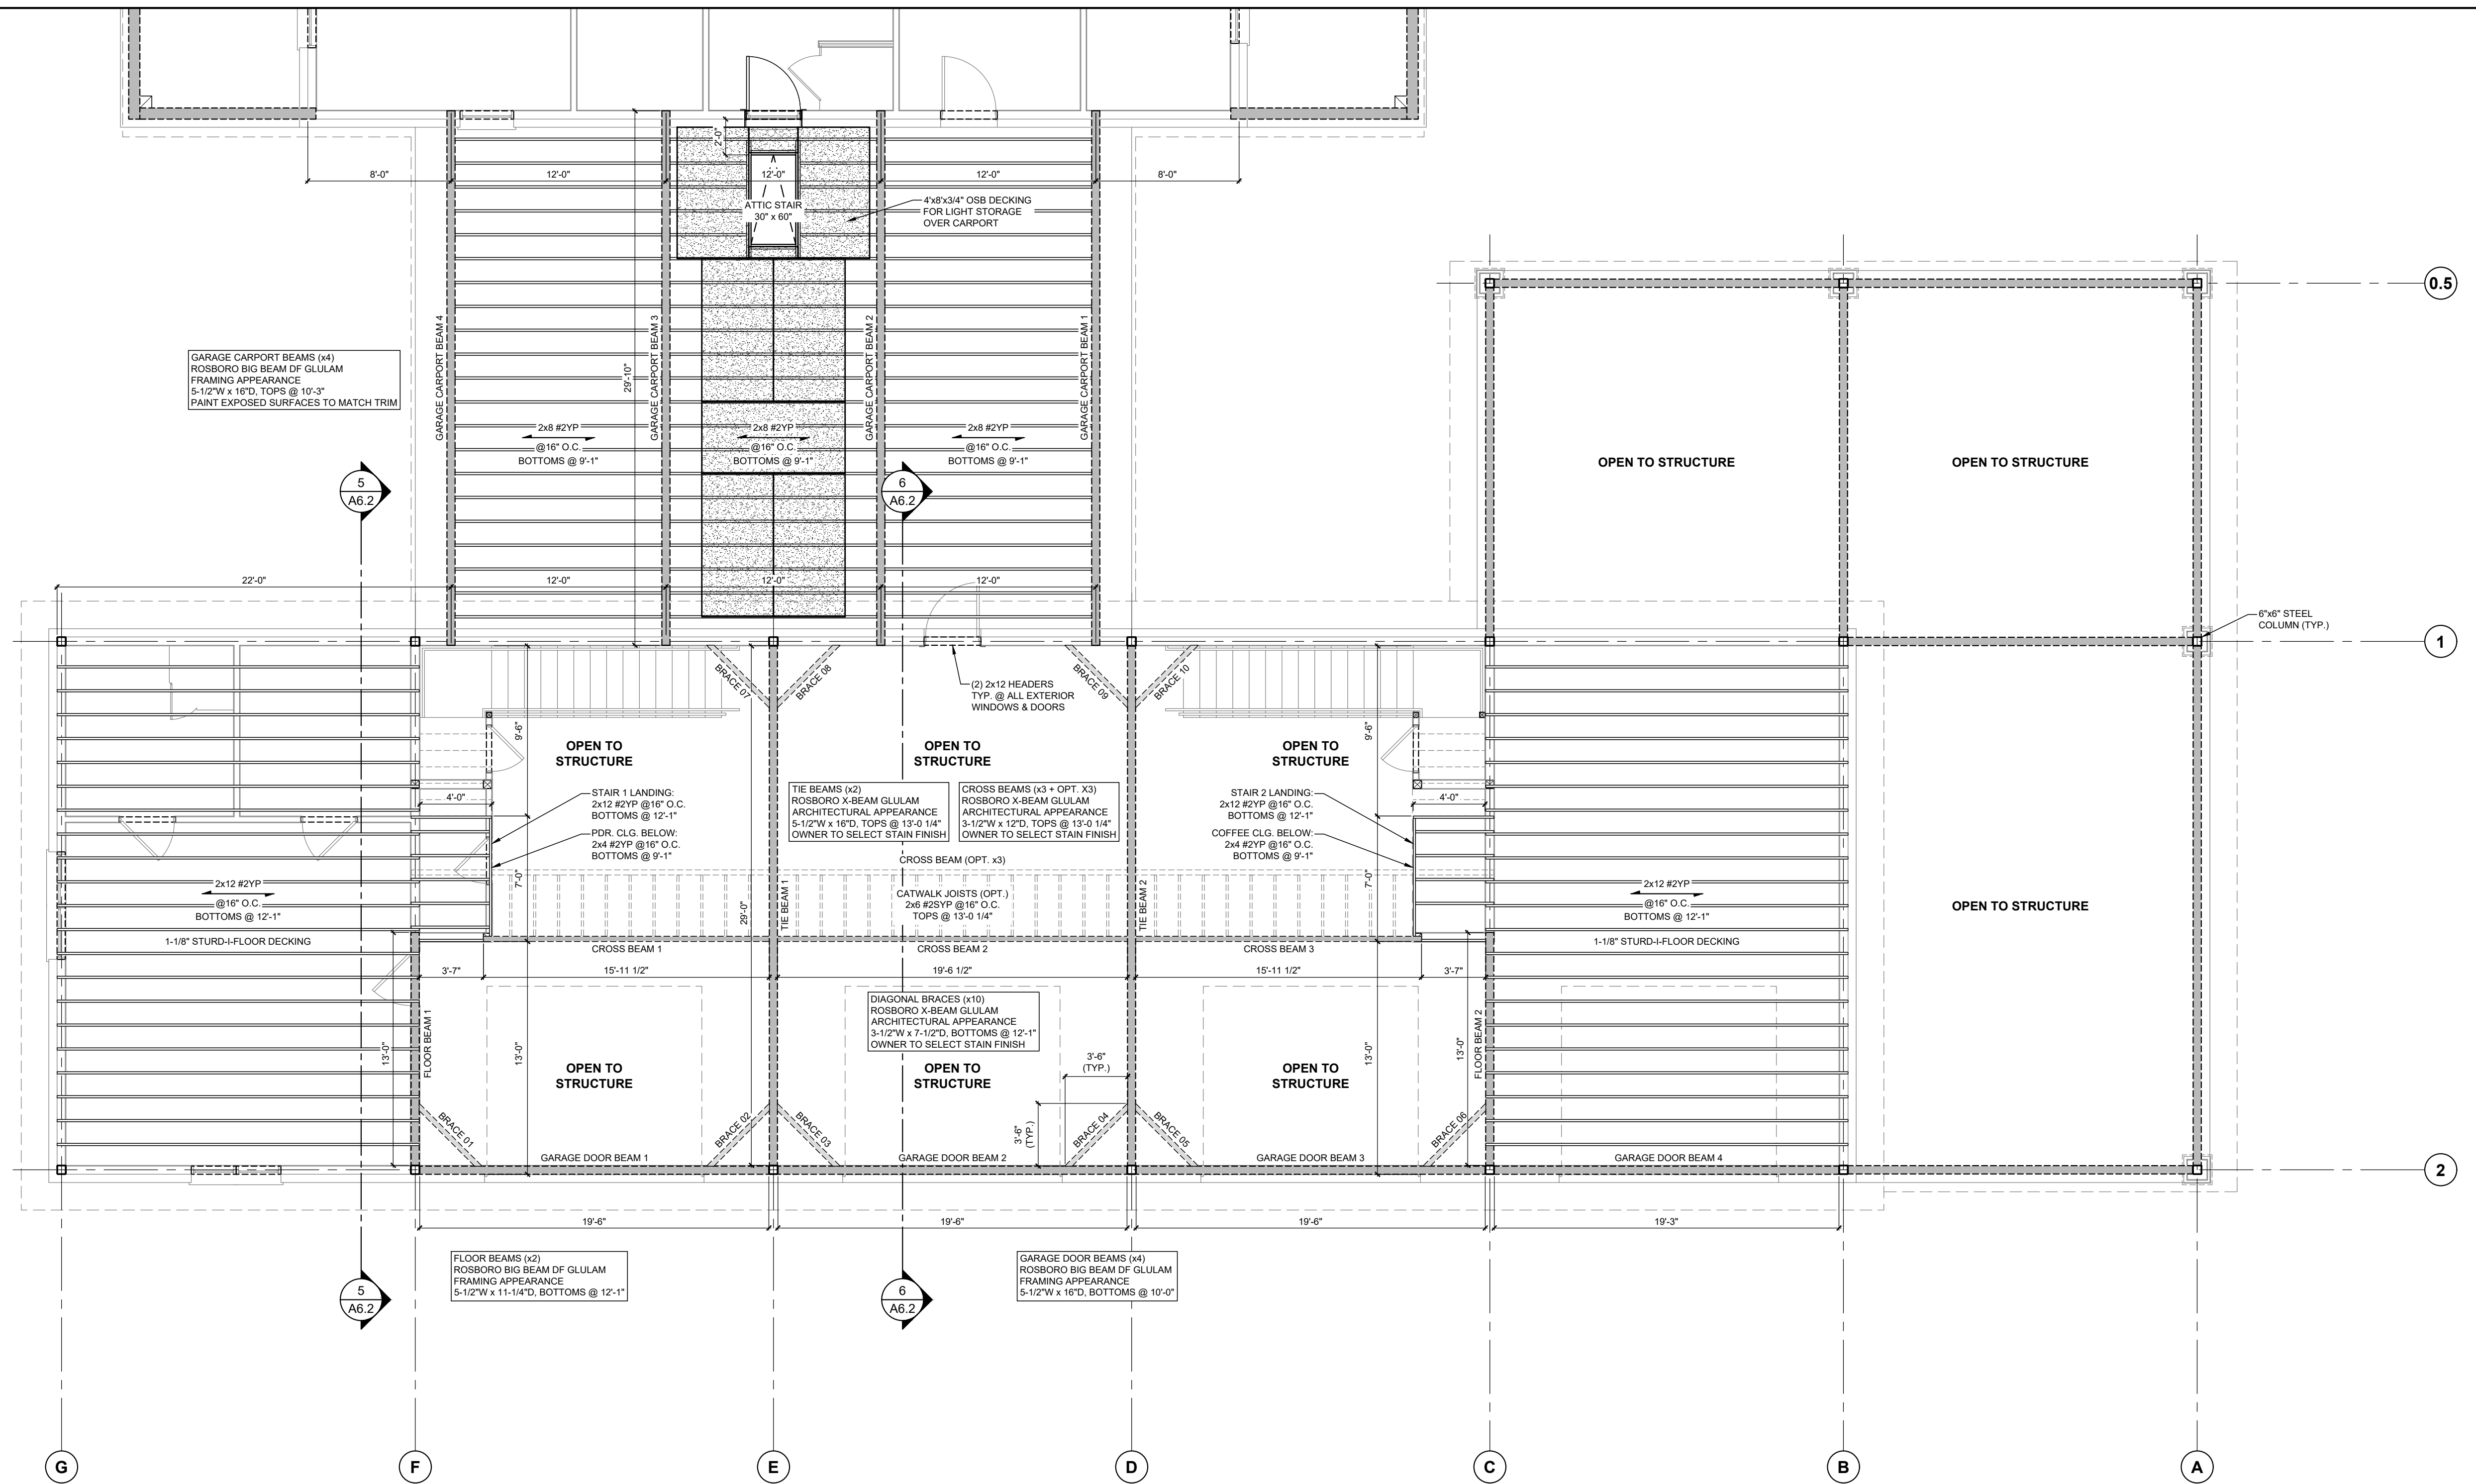
DATE: 08/26/2018  
 SCALE: 1/8" = 1'-0"

DRAWN BY: SJ  
 CHECKED: DM

REVISIONS:  
 03/01/2019 PERMIT SET

GARAGE - 1st FLOOR  
 CEILING FRAMING PLAN


**AC3.1**





**GENERAL FRAMING NOTES:**

- THIS PLAN IS FOR ESTIMATING PURPOSES ONLY. THE CONTRACTOR SHALL BE RESPONSIBLE FOR ALL FINAL QUANTITIES.
- ALL METAL AND WOOD FRAMING SHALL BE ASSEMBLED IN ACCORDANCE WITH ALL LOCAL, STATE, AND FEDERAL CODES.
- ALL STRAPPING, SECURING, BRACING, AND REINFORCING SHALL BE INSTALLED IN ACCORDANCE WITH ALL APPLICABLE CODES.
- ALL CONNECTIONS AT PLATES, JOISTS, AND RAFTERS TO BE TIED WITH SIMPSON STRONG TIE OR EQUAL.
- COORDINATE FRAMING WITH ALL HVAC DUCTS, ELECTRICAL AND PLUMBING REQUIREMENTS.
- ALL MATERIALS SHALL BE NEW AND FREE OF EXCESSIVE MOISTURE.
- ALL LUMBER USED FOR FRAMING OF WALLS, CEILINGS AND STRAIGHT PLANES SHALL BE OF GRADE #2 YELLOW PINE MINIMUM.
- ALL LUMBER IN CONTACT WITH CONCRETE OR MASONRY SHALL BE PRESSURE-TREATED.
- ALL SUBSTITUTIONS SHALL COMPLY WITH CURRENT IBC REGULATIONS REGARDING RESIDENTIAL CONSTRUCTION. ALL SUBSTITUTIONS SHALL MEET OR EXCEED THESE STANDARDS.
- CONTRACTOR SHALL CULL ALL UNDESIRABLE LUMBER AS NEEDED AND REPLACE AS REQUIRED.
- WALL PLATES SHALL HAVE PLATE SEAL FABRIC TO PREVENT DIRECT CONTACT WITH SLAB.
- ANCHOR EXTERIOR WALL PLATES WITH 1/2"x12" GALVANIZED ANCHOR BOLTS PLACED 8" FROM EACH CORNER AND OPENING, THEN AT 32" OC ALONG ALL EXTERIOR WALLS.
- INTERIOR PLATES SHALL BE FASTENED USING HILTI ZF 62 P8 2-1/2" CONCRETE NAILS PLACED AT 32" OC FOR ALL LOAD BEARING AND NON-LOAD BEARING WALLS.
- ALL EXTERIOR WALL HEADERS SHALL BE 2x12 MINIMUM AS REQUIRED.
- ALL INTERIOR WALL HEADERS IN LOAD BEARING WALLS AND BENEATH SECOND FLOORS SHALL BE 2x12 MINIMUM AS REQUIRED.
- ALL INTERIOR WALL HEADERS FOR SINGLE FLOOR CONSTRUCTION SHALL BE 2x6 MINIMUM WITH CRIPPLES SPACED IN ACCORDANCE WITH WALLS.
- EXTERIOR WALLS SHALL RECEIVE 3/4" OSB ON CORNERS FOR WIND BRACING.
- TURN ALL CROWNS UP AND PROVIDE STIFFBACKS OVER FLAT CEILING AREAS.
- ALL SPANS FOR ROOF MEMBERS SHALL BE SUPPORTED WITH PURLINS SPACED A MAXIMUM OF 12 FEET FROM CENTER TO CENTER.
- ALL UNDERLAYMENT AND FLASHING TO BE INSTALLED PER ROOFING MANUFACTURER'S INSTRUCTIONS.




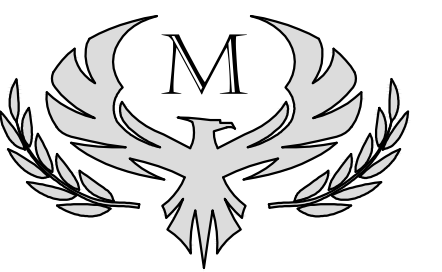

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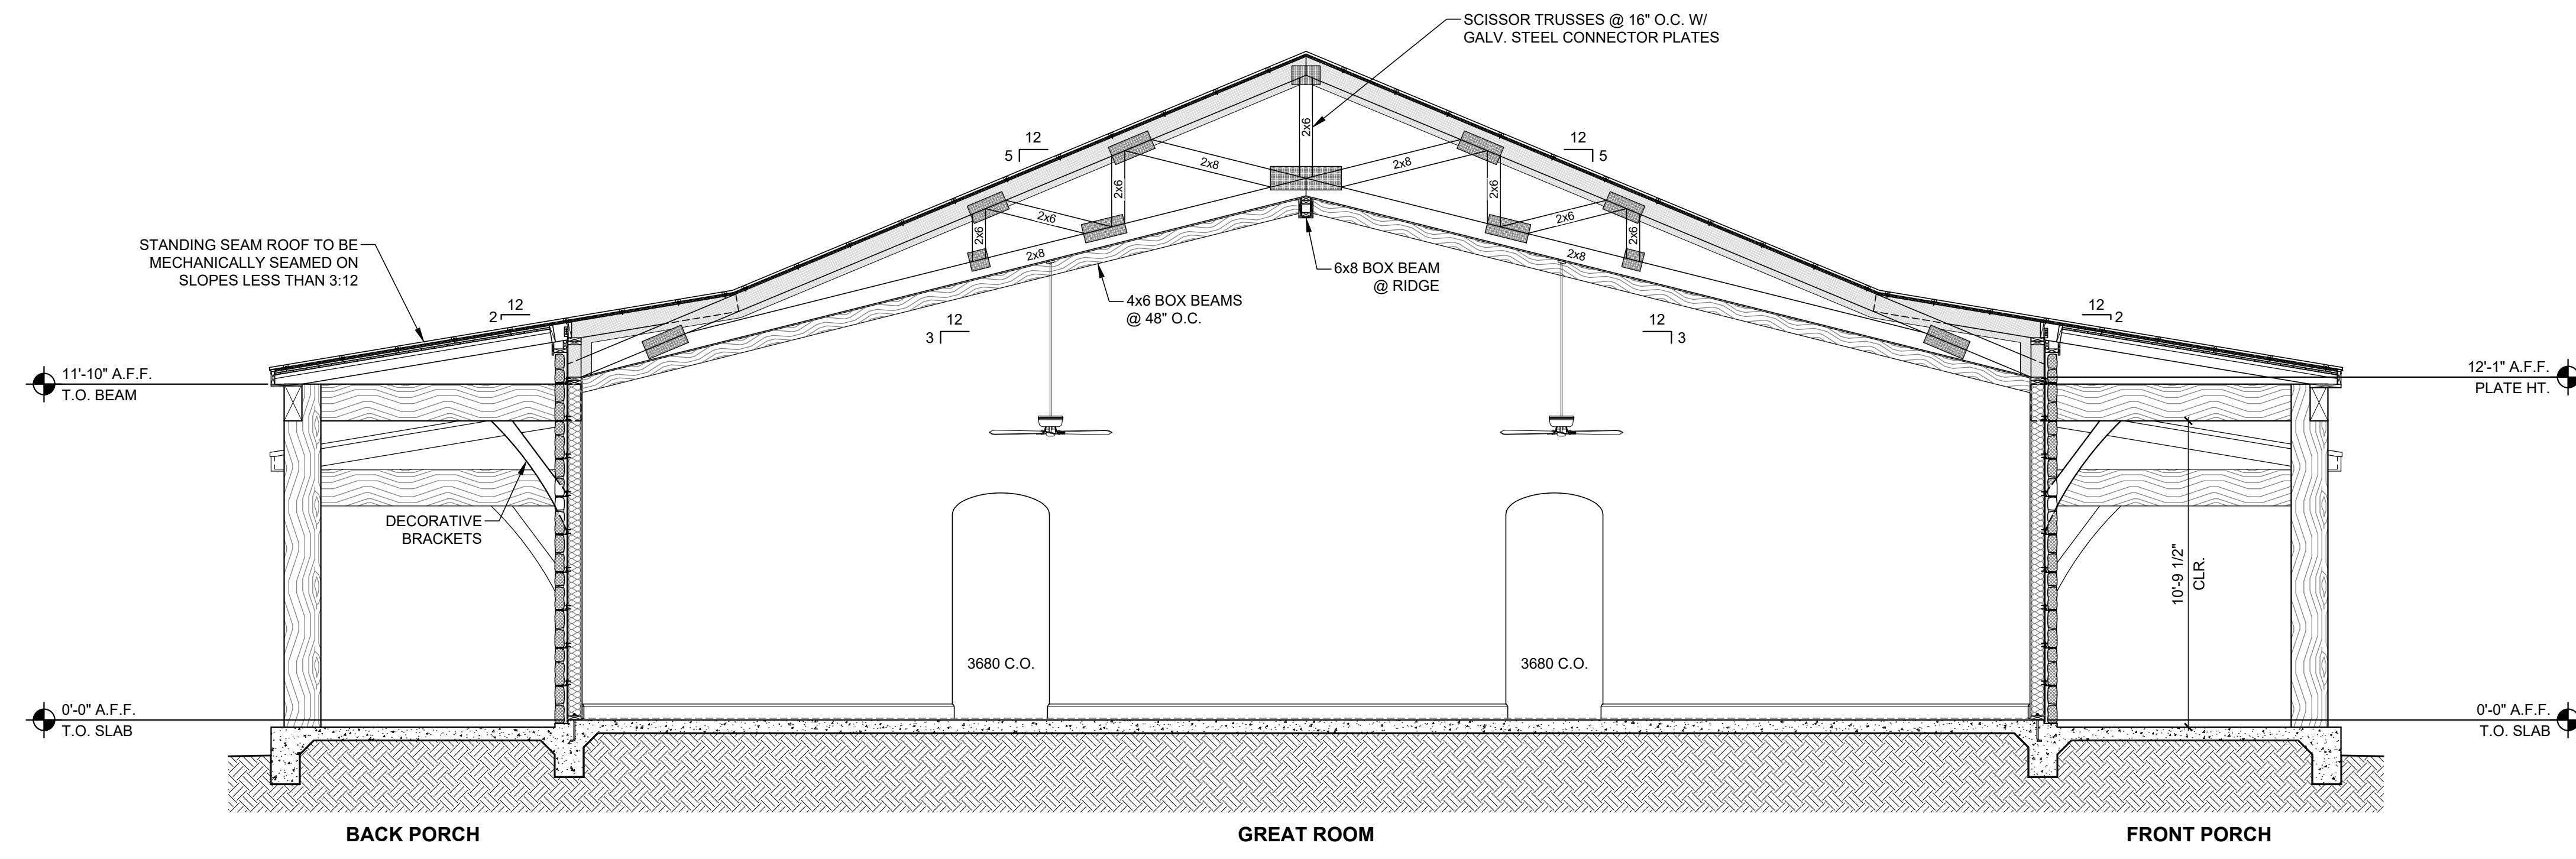

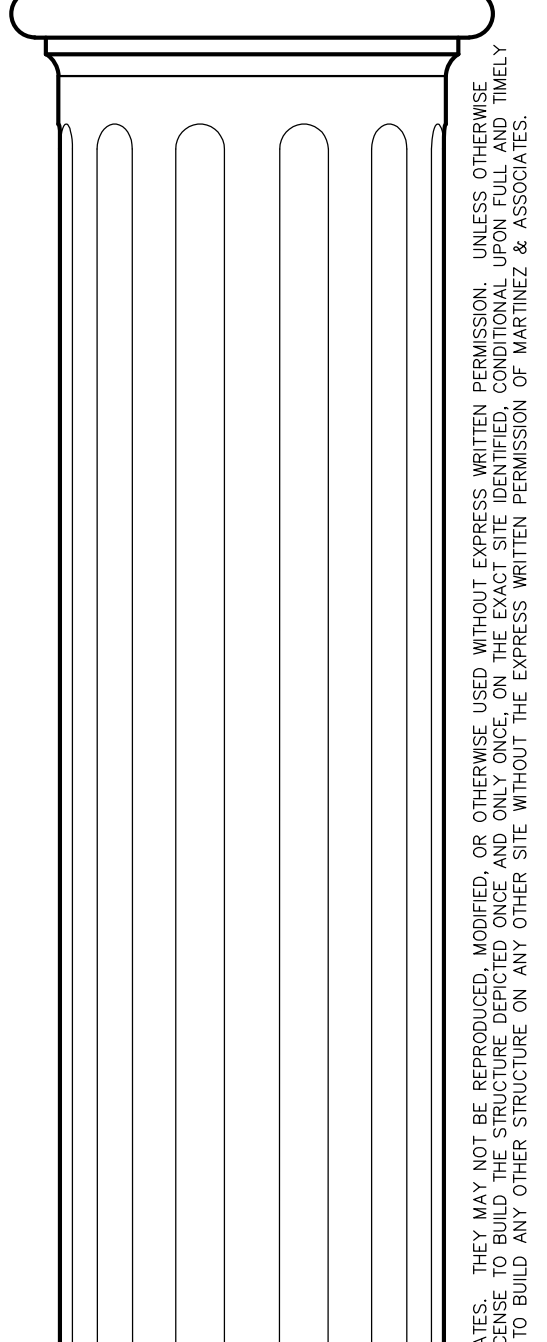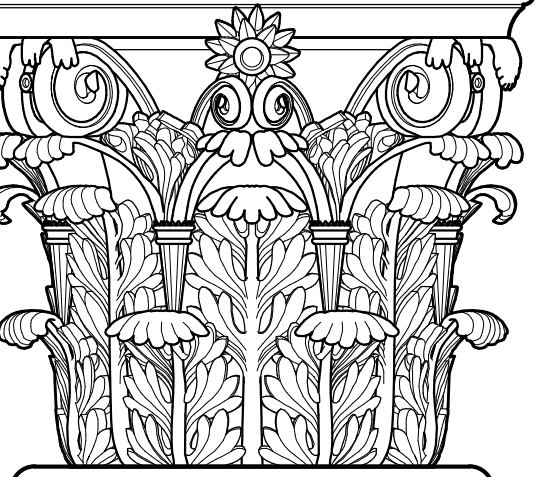
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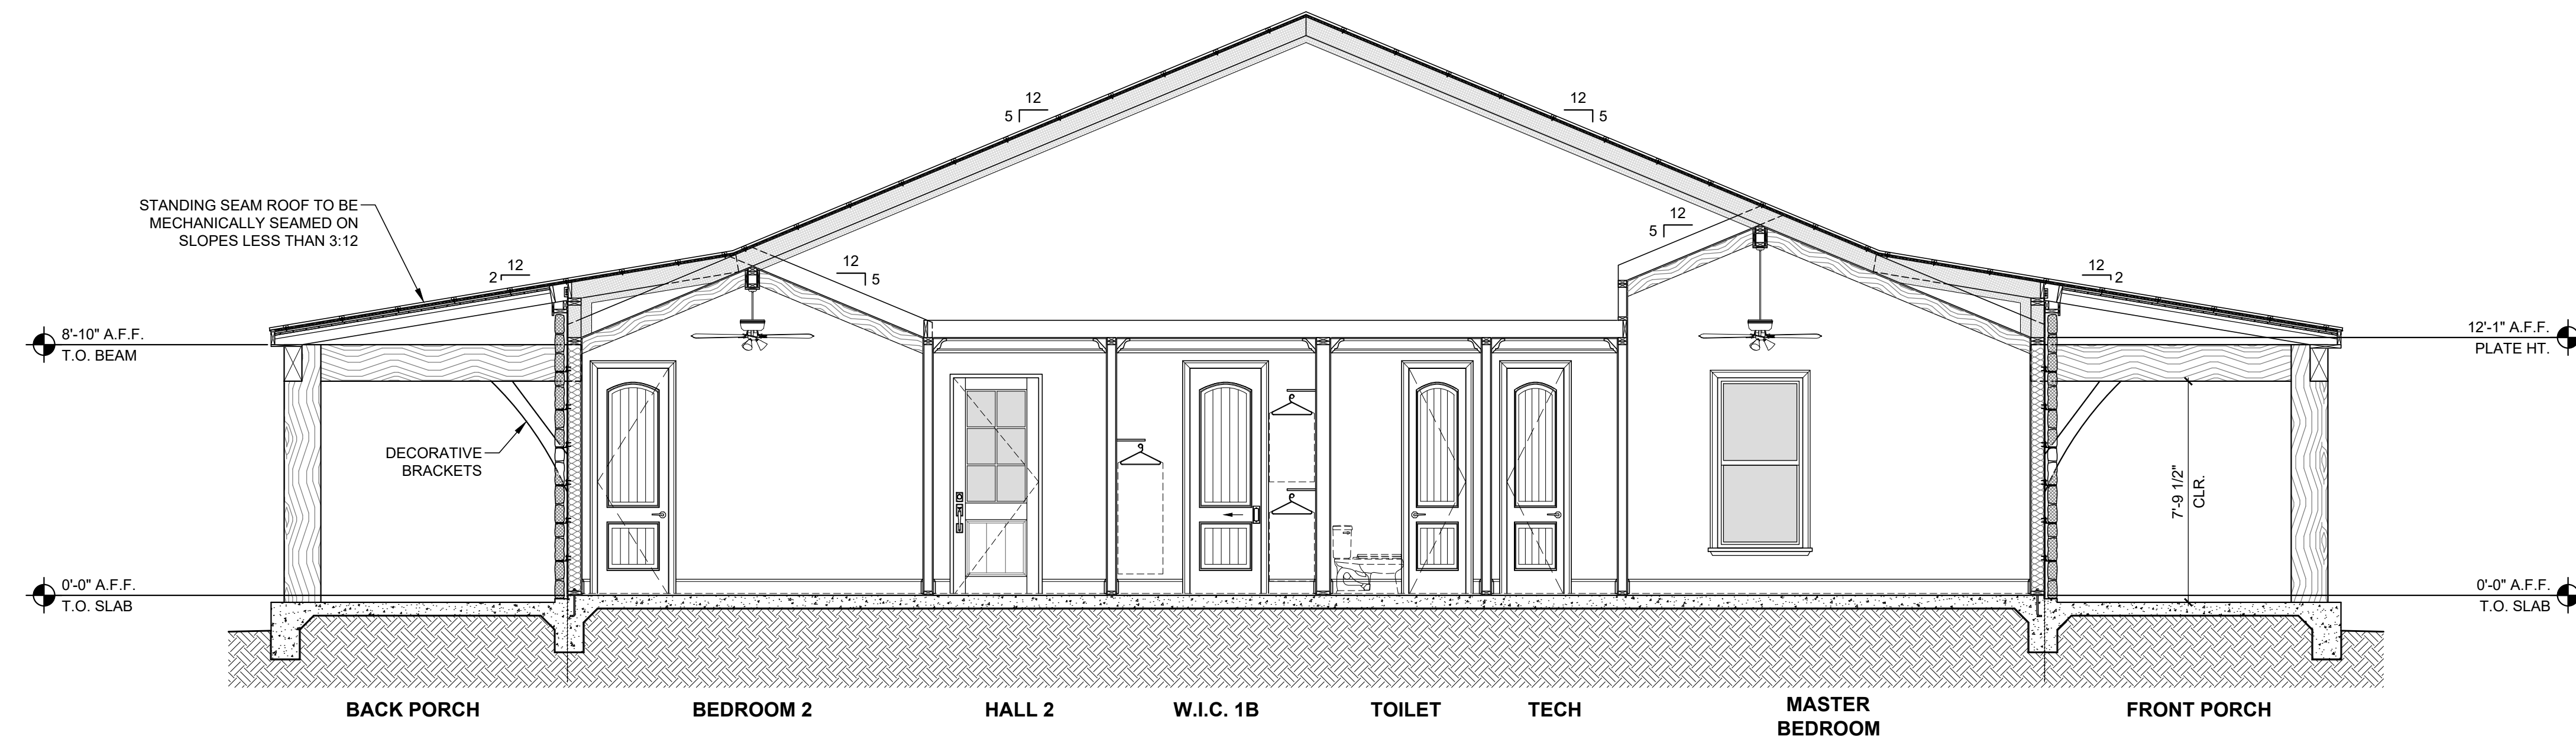
DATE: 08/26/2018	DRAWN BY: SJ
SCALE: AS NOTED	CHECKED: DM
REVISIONS:	
03/01/2019	PERMIT SET

CROSS SECTIONS  
 MAIN HOUSE  
**A6.1**

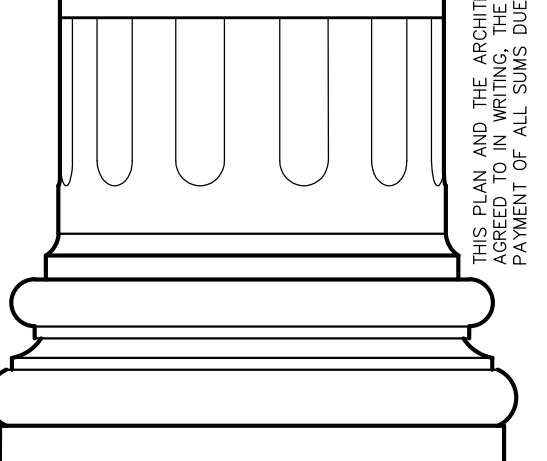


**1 CROSS SECTION - MAIN HOUSE**

SCALE: 1/4" = 1'-0"




**2 CROSS SECTION - MAIN HOUSE**

SCALE: 1/4" = 1'-0"

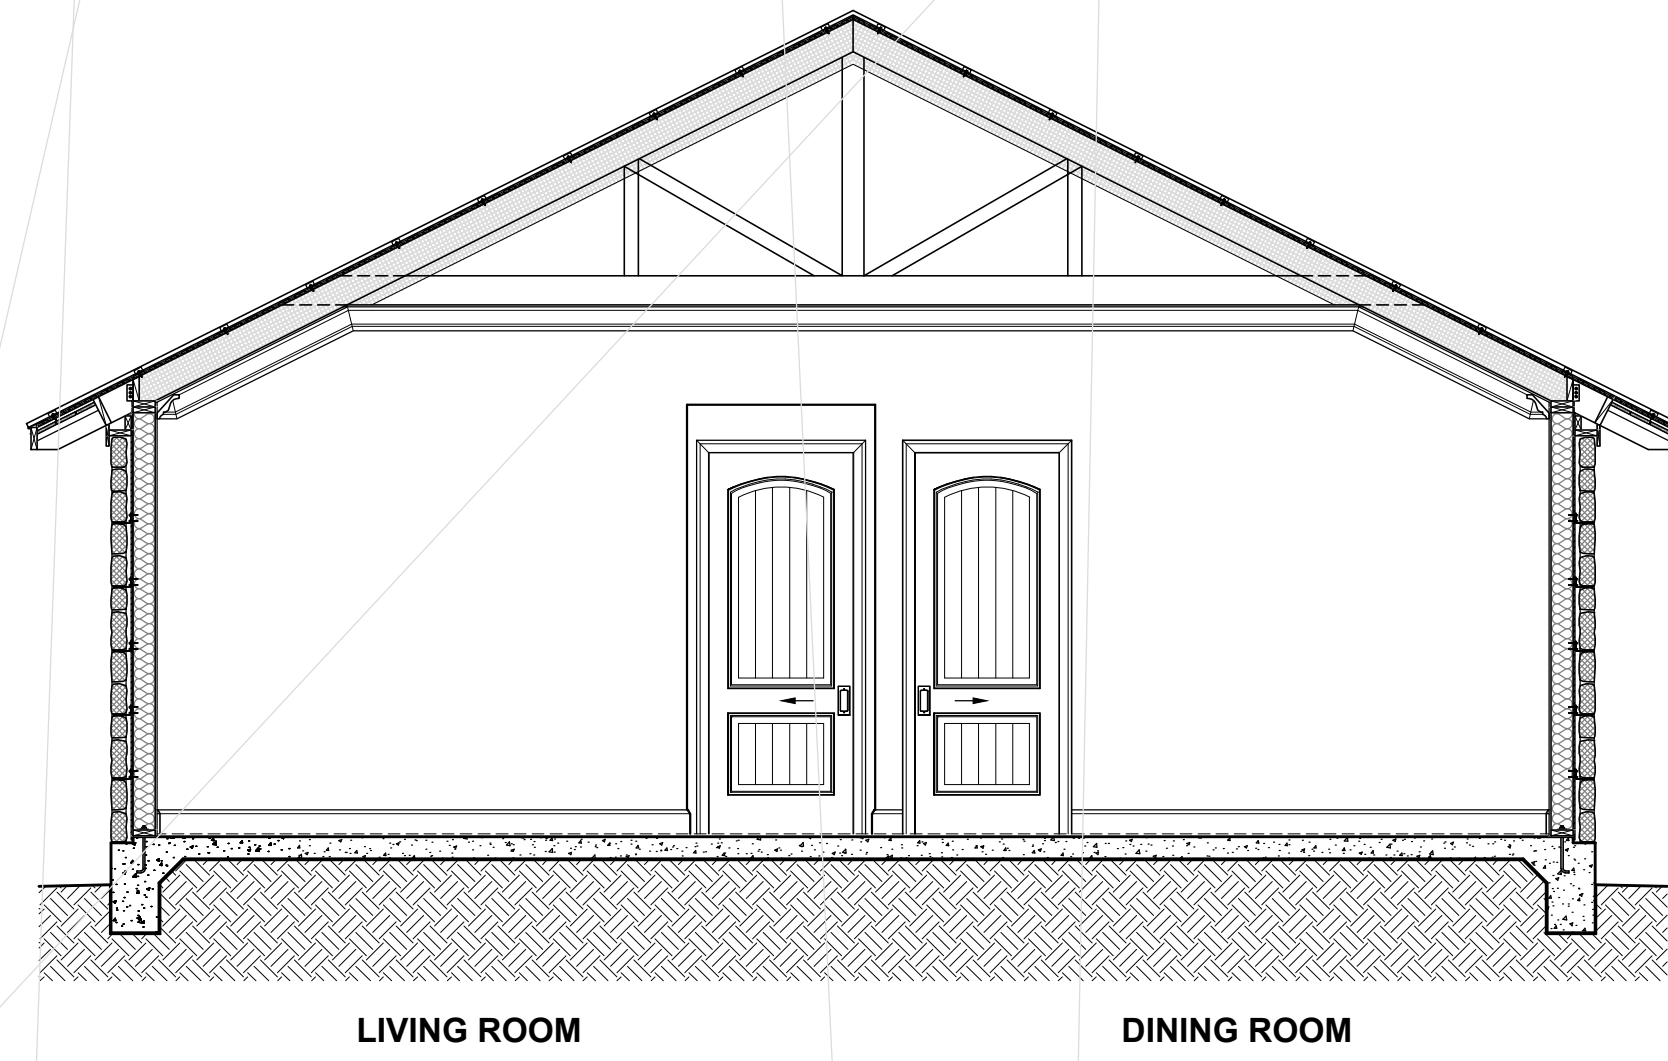

LIVING ROOM

DINING ROOM

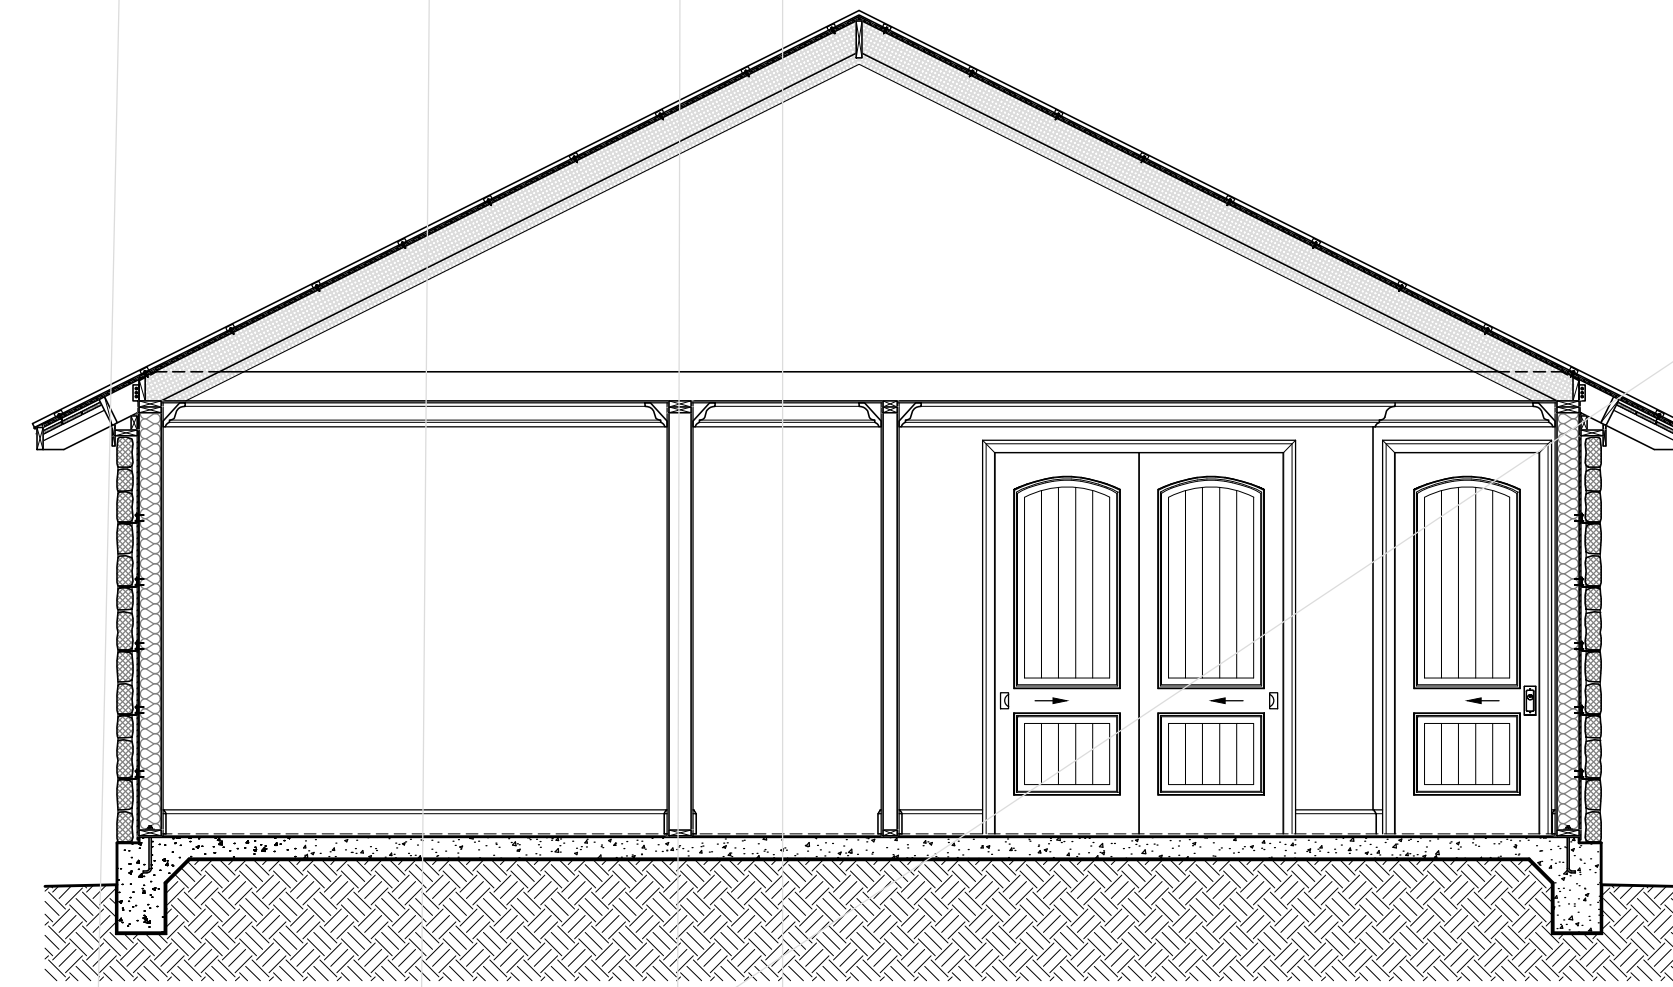


UTILITY

HALL

OFFICE

**3 CROSS SECTION - CASITA**

SCALE: 1/4" = 1'-0"

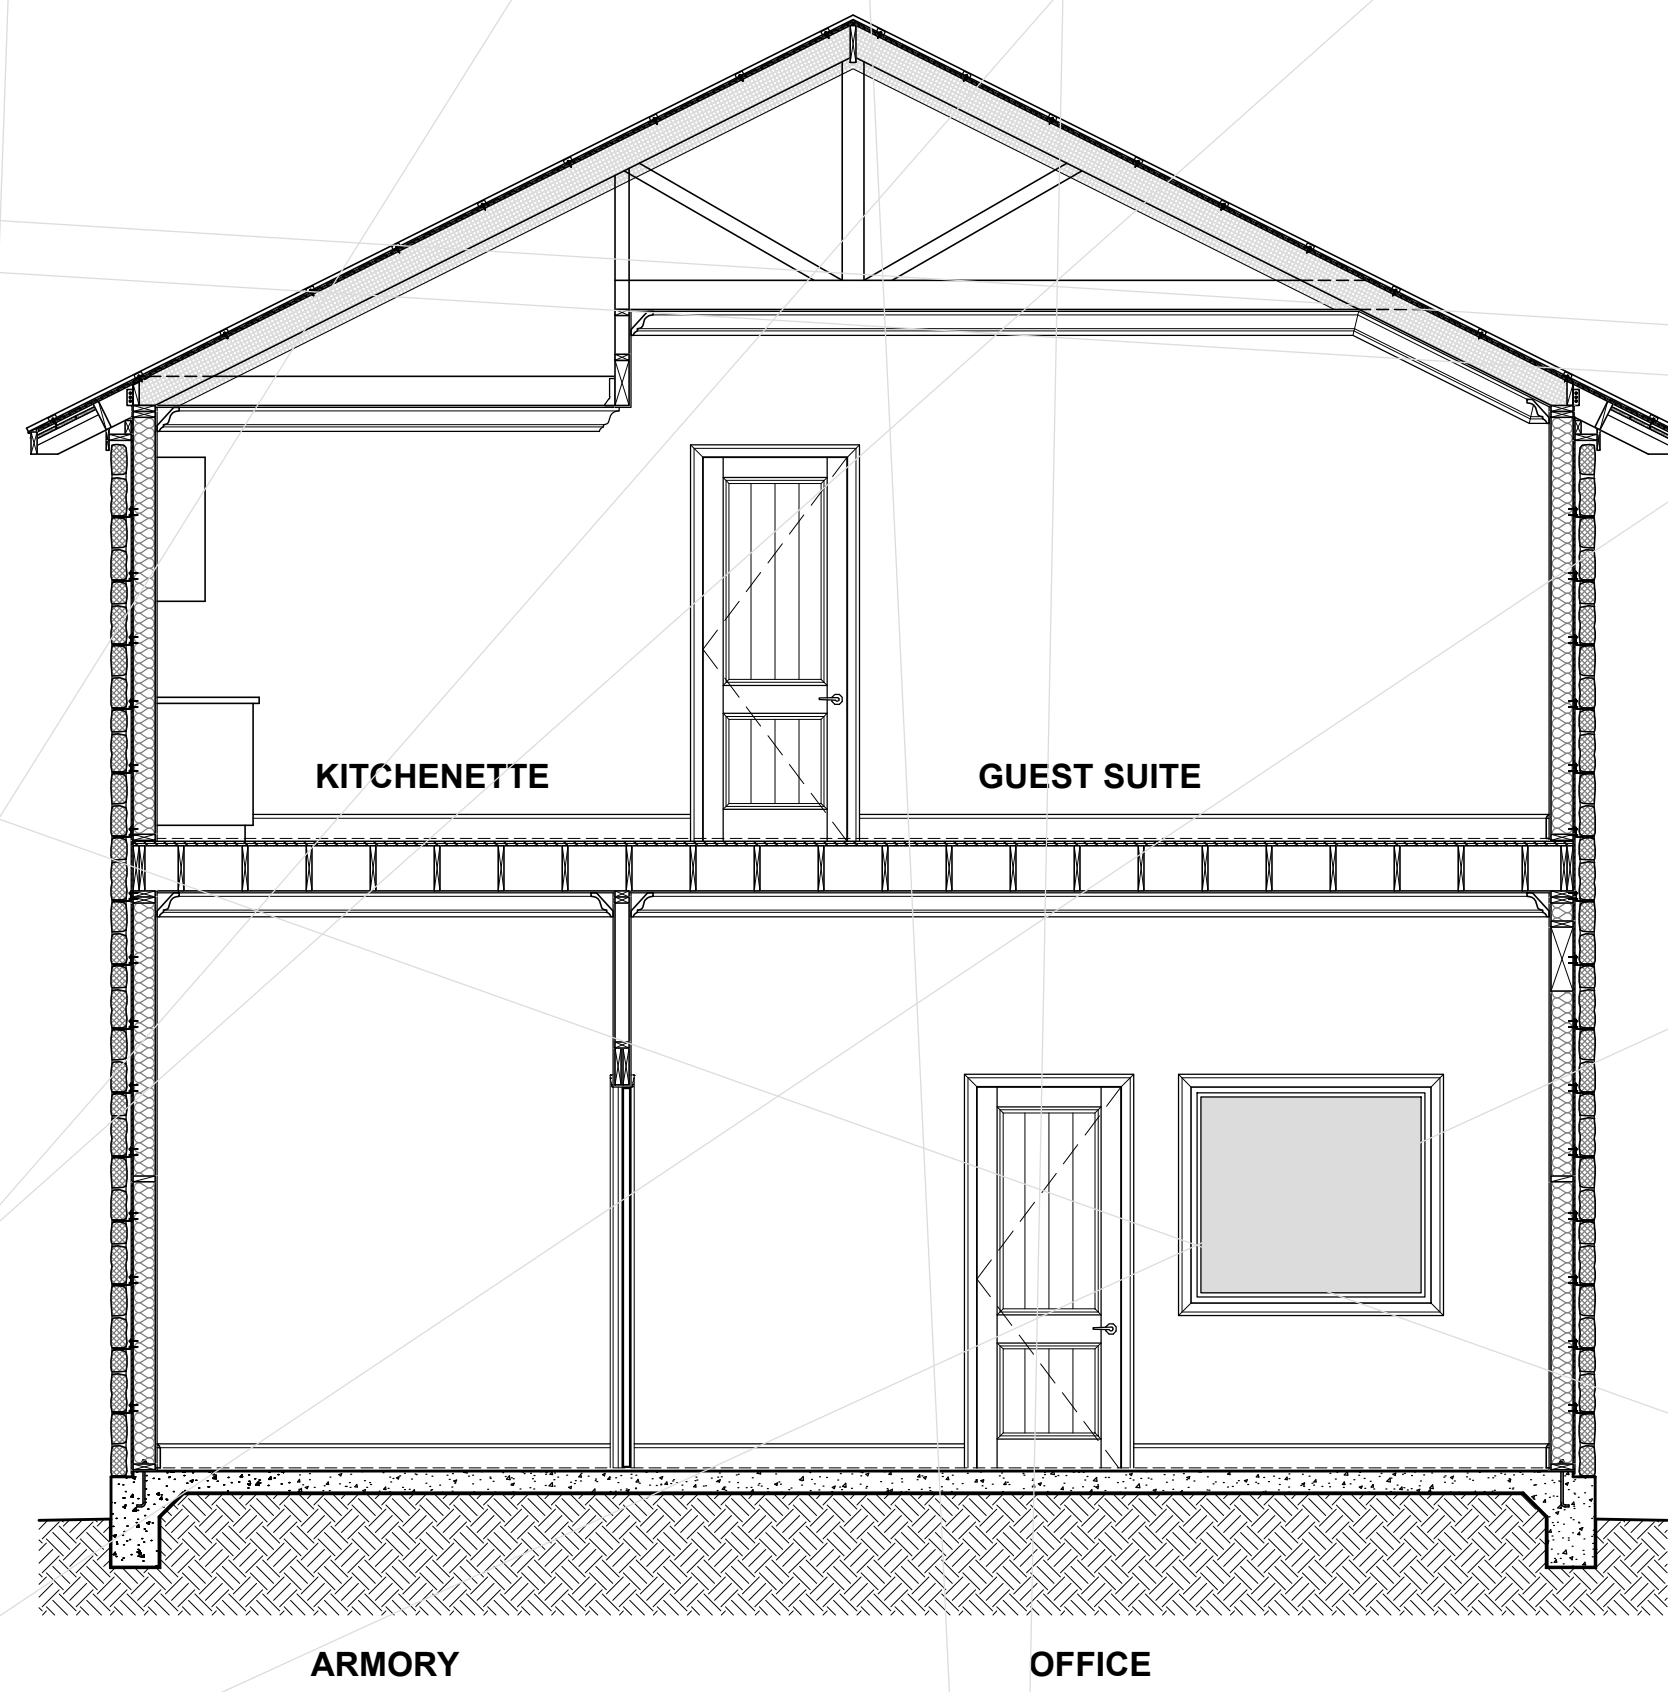


KITCHENETTE

GUEST SUITE



ARMORY

OFFICE

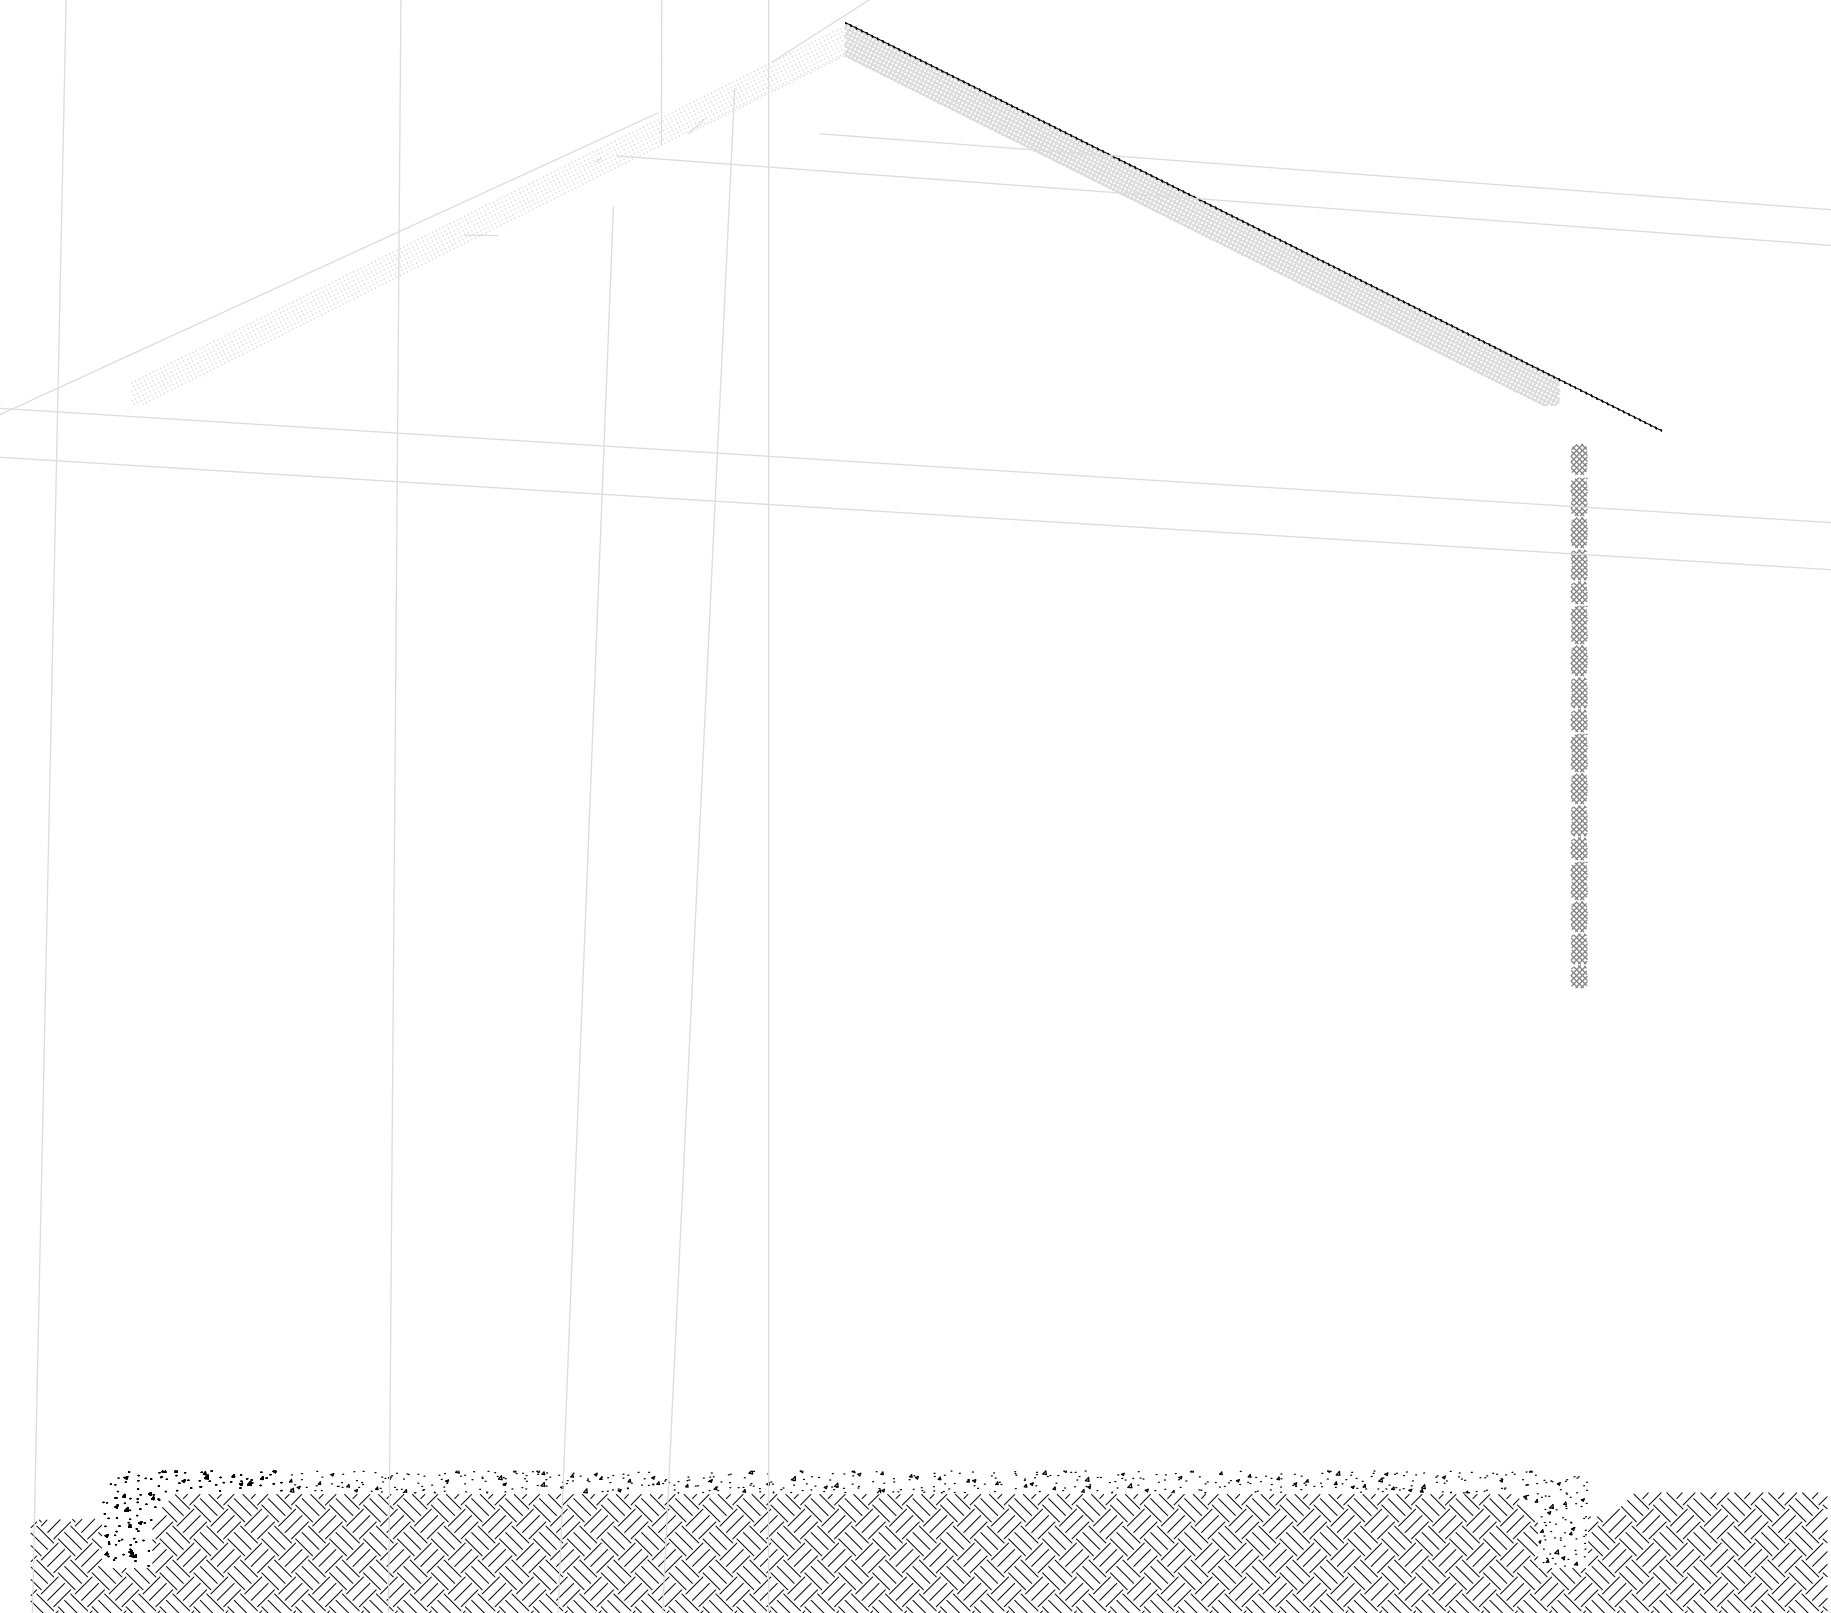


**5 CROSS SECTION - GARAGE**

SCALE: 1/4" = 1'-0"

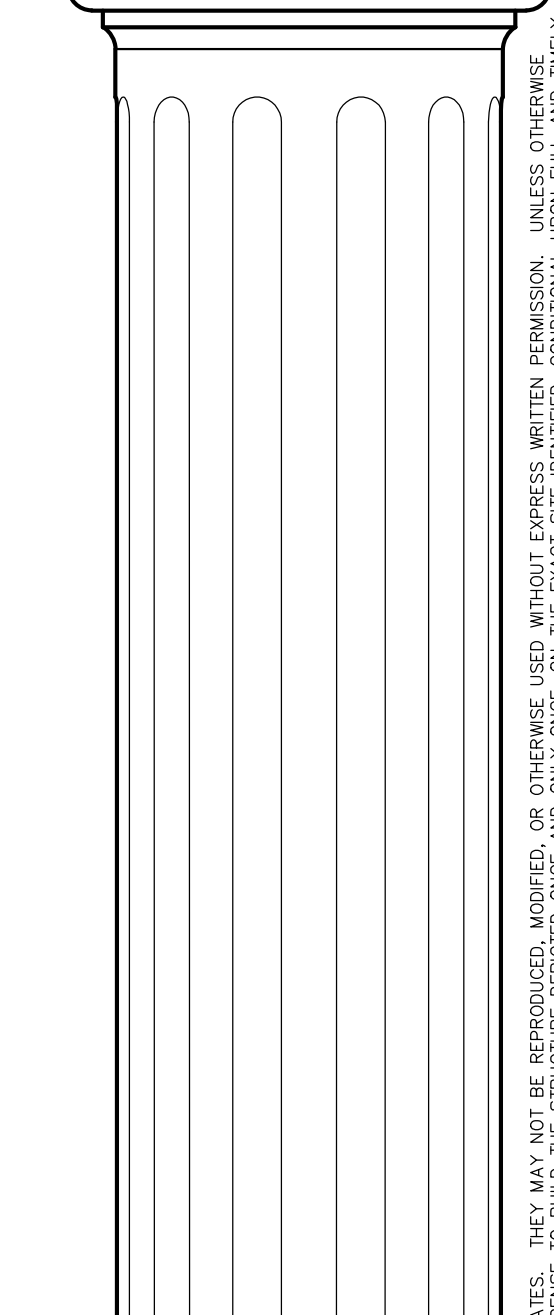
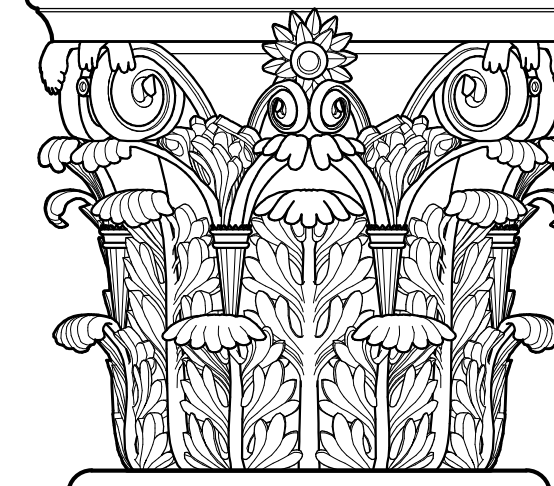


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**WALL SECTIONS**  
A7.1

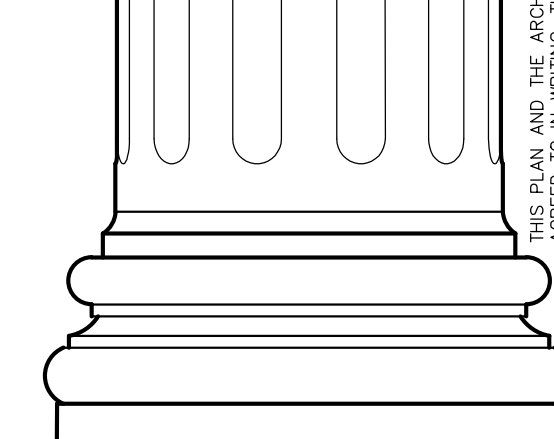



2015 INTERNATIONAL RESIDENTIAL CODE® TABLE R502.3.1(2) FLOOR JOIST SPANS FOR COMMON LUMBER SPECIES (Residential Living Areas, Live Load = 40 psf, L/A = 360)ᵇ										
JOIST SPACING (inches)	SPECIES AND GRADE	DEAD LOAD = 10 psf				DEAD LOAD = 20 psf				
		2x6	2x8	2x10	2x12	2x6	2x8	2x10	2x12	
		Maximum floor joist spans								
(ft.-in.)	(ft.-in.)	(ft.-in.)	(ft.-in.)	(ft.-in.)	(ft.-in.)	(ft.-in.)	(ft.-in.)	(ft.-in.)	(ft.-in.)	
12	Douglas fir-larch SS	11-4	15-0	19-1	23-3	11-4	15-0	19-1	23-3	
	Douglas fir-larch #1	10-11	14-5	18-5	22-0	10-11	14-2	17-4	20-1	
	Douglas fir-larch #2	10-9	14-2	18-0	20-11	10-8	13-6	16-5	19-1	
	Douglas fir-larch #3	8-11	11-3	13-9	16-0	8-1	10-3	12-7	14-7	
	Hem-fir SS	10-8	14-2	18-0	21-11	10-8	14-2	18-0	21-11	
	Hem-fir #1	10-6	13-10	17-8	21-6	10-6	13-10	17-1	20-3	
	Hem-fir #2	10-0	13-2	16-10	20-4	10-0	13-1	16-0	18-6	
	Hem-fir #3	8-8	11-0	13-5	15-7	7-11	10-0	12-3	14-3	
	Southern pine SS	11-2	14-8	18-9	22-10	11-2	14-8	18-9	22-10	
	Southern pine #1	10-9	14-2	18-0	21-11	10-9	14-2	18-11	20-1	
	Southern pine #2	10-3	13-6	16-2	19-1	10-0	12-6	14-9	17-5	
	Southern pine #3	8-2	10-3	12-6	14-9	7-5	9-5	11-5	13-6	
Spruce-pine-fir SS	10-8	13-10	17-8	21-6	10-6	13-10	17-8	21-6		
Spruce-pine-fir #1	10-3	13-6	17-3	20-7	10-3	13-6	16-3	18-10		
Spruce-pine-fir #2	10-3	13-6	17-3	20-7	10-3	13-3	16-3	18-10		
Spruce-pine-fir #3	8-8	11-0	13-5	15-7	7-11	10-0	12-3	14-3		
16	Douglas fir-larch SS	10-4	13-7	17-4	21-1	10-4	13-7	17-4	21-1	
	Douglas fir-larch #1	9-11	13-1	16-5	19-1	9-8	12-4	15-0	17-5	
	Douglas fir-larch #2	9-9	12-9	15-7	18-1	9-3	11-8	14-3	16-6	
	Douglas fir-larch #3	7-8	9-9	11-11	13-10	7-0	8-11	10-11	12-7	
	Hem-fir SS	9-9	12-10	16-5	19-11	9-9	12-10	16-5	19-11	
	Hem-fir #1	9-4	12-3	15-0	17-10	9-4	12-2	14-10	17-2	
	Hem-fir #2	9-1	12-0	15-2	17-7	8-11	11-4	13-10	16-1	
	Hem-fir #3	7-6	9-6	11-8	13-6	6-10	8-8	10-7	12-4	
	Southern pine SS	10-2	13-4	17-0	20-9	10-2	13-4	17-0	20-9	
	Southern pine #1	9-9	12-10	16-1	19-1	9-9	12-7	14-8	17-5	
	Southern pine #2	9-4	11-10	14-0	16-6	8-6	10-10	12-10	15-1	
	Southern pine #3	7-1	8-11	10-10	12-10	6-5	8-2	9-10	11-8	
Spruce-pine-fir SS	9-8	12-7	16-0	19-6	9-8	12-7	16-0	19-6		
Spruce-pine-fir #1	9-4	12-3	15-5	17-10	9-1	11-6	14-1	16-3		
Spruce-pine-fir #2	9-4	12-3	15-5	17-10	9-1	11-6	14-1	16-3		
Spruce-pine-fir #3	7-6	9-6	11-8	13-6	6-10	8-8	10-7	12-4		
19.2	Douglas fir-larch SS	9-8	12-10	16-4	19-10	9-8	12-10	16-4	19-6	
	Douglas fir-larch #1	9-4	12-4	15-0	17-5	8-10	11-3	13-8	15-11	
	Douglas fir-larch #2	9-1	11-8	14-3	16-6	8-5	10-8	13-0	15-1	
	Douglas fir-larch #3	7-0	8-11	10-11	12-7	6-5	8-2	9-11	11-6	
	Hem-fir SS	9-2	12-1	15-5	18-9	9-2	12-1	15-5	18-9	
	Hem-fir #1	9-0	11-10	14-10	17-2	8-9	11-1	13-6	15-8	
	Hem-fir #2	8-7	11-3	13-10	16-1	8-2	10-4	12-8	14-8	
	Hem-fir #3	6-10	8-8	10-7	12-4	6-3	7-11	9-8	11-3	
	Southern pine SS	9-6	12-7	16-0	19-6	9-6	12-7	16-0	19-6	
	Southern pine #1	9-2	12-1	14-8	17-5	9-0	11-5	13-5	15-11	
	Southern pine #2	8-6	10-10	12-10	15-1	7-9	9-10	11-8	13-9	
	Southern pine #3	6-5	8-2	9-10	11-8	5-11	7-5	9-0	10-8	
Spruce-pine-fir SS	9-0	11-10	15-1	18-4	9-0	11-10	15-1	18-4		
Spruce-pine-fir #1	8-9	11-6	14-1	16-3	8-3	10-6	12-10	14-10		
Spruce-pine-fir #2	8-9	11-6	14-1	16-3	8-3	10-6	12-10	14-10		
Spruce-pine-fir #3	6-10	8-8	10-7	12-4	6-3	7-11	9-8	11-3		
24	Douglas fir-larch SS	9-0	11-11	15-2	18-5	9-0	11-11	15-0	17-5	
	Douglas fir-larch #1	8-8	11-0	14-3	17-5	7-11	10-0	12-3	14-3	
	Douglas fir-larch #2	8-3	10-5	12-9	14-9	7-6	9-6	11-8	13-6	
	Douglas fir-larch #3	6-3	8-0	9-9	11-3	5-9	7-3	8-11	10-4	
	Hem-fir SS	8-6	11-3	14-4	17-5	8-6	11-3	14-4	17-5	
	Hem-fir #1	8-4	10-10	13-3	15-5	7-10	9-11	12-1	14-0	
	Hem-fir #2	7-11	10-2	12-5	14-4	7-4	9-3	11-4	13-1	
	Hem-fir #3	6-2	7-9	9-6	11-0	5-7	7-1	8-8	10-1	
	Southern pine SS	8-10	11-8	14-11	18-1	8-10	11-8	14-11	18-0	
	Southern pine #1	8-6	11-3	13-1	15-7	8-1	10-3	12-10	14-3	
	Southern pine #2	7-7	9-8	11-5	13-6	7-0	8-10	10-5	12-4	
	Southern pine #3	5-9	7-3	8-10	10-5	5-3	6-8	8-1	9-6	
Spruce-pine-fir SS	8-4	11-0	14-0	17-0	8-4	11-0	13-8	15-11		
Spruce-pine-fir #1	8-1	10-3	12-7	14-7	7-5	9-5	11-6	13-4		
Spruce-pine-fir #2	8-1	10-3	12-7	14-7	7-5	9-5	11-6	13-4		
Spruce-pine-fir #3	6-2	7-9	9-6	11-0	5-7	7-1	8-8	10-1		

For SI: 1 inch = 25.4 mm, 1 foot = 304.8 mm, 1 pound per square foot = 0.0479 kPa.  
 NOTE: Check sources for availability of lumber in lengths greater than 20 feet.  
 a. End bearing length shall be increased to 2 inches.  
 b. Dead load limits for townhouses in Seismic Design Category C and all structures in Seismic Design Categories D, D<sub>s</sub>, and D<sub>s</sub> shall be determined in accordance with Section R301.2.2.2.1.

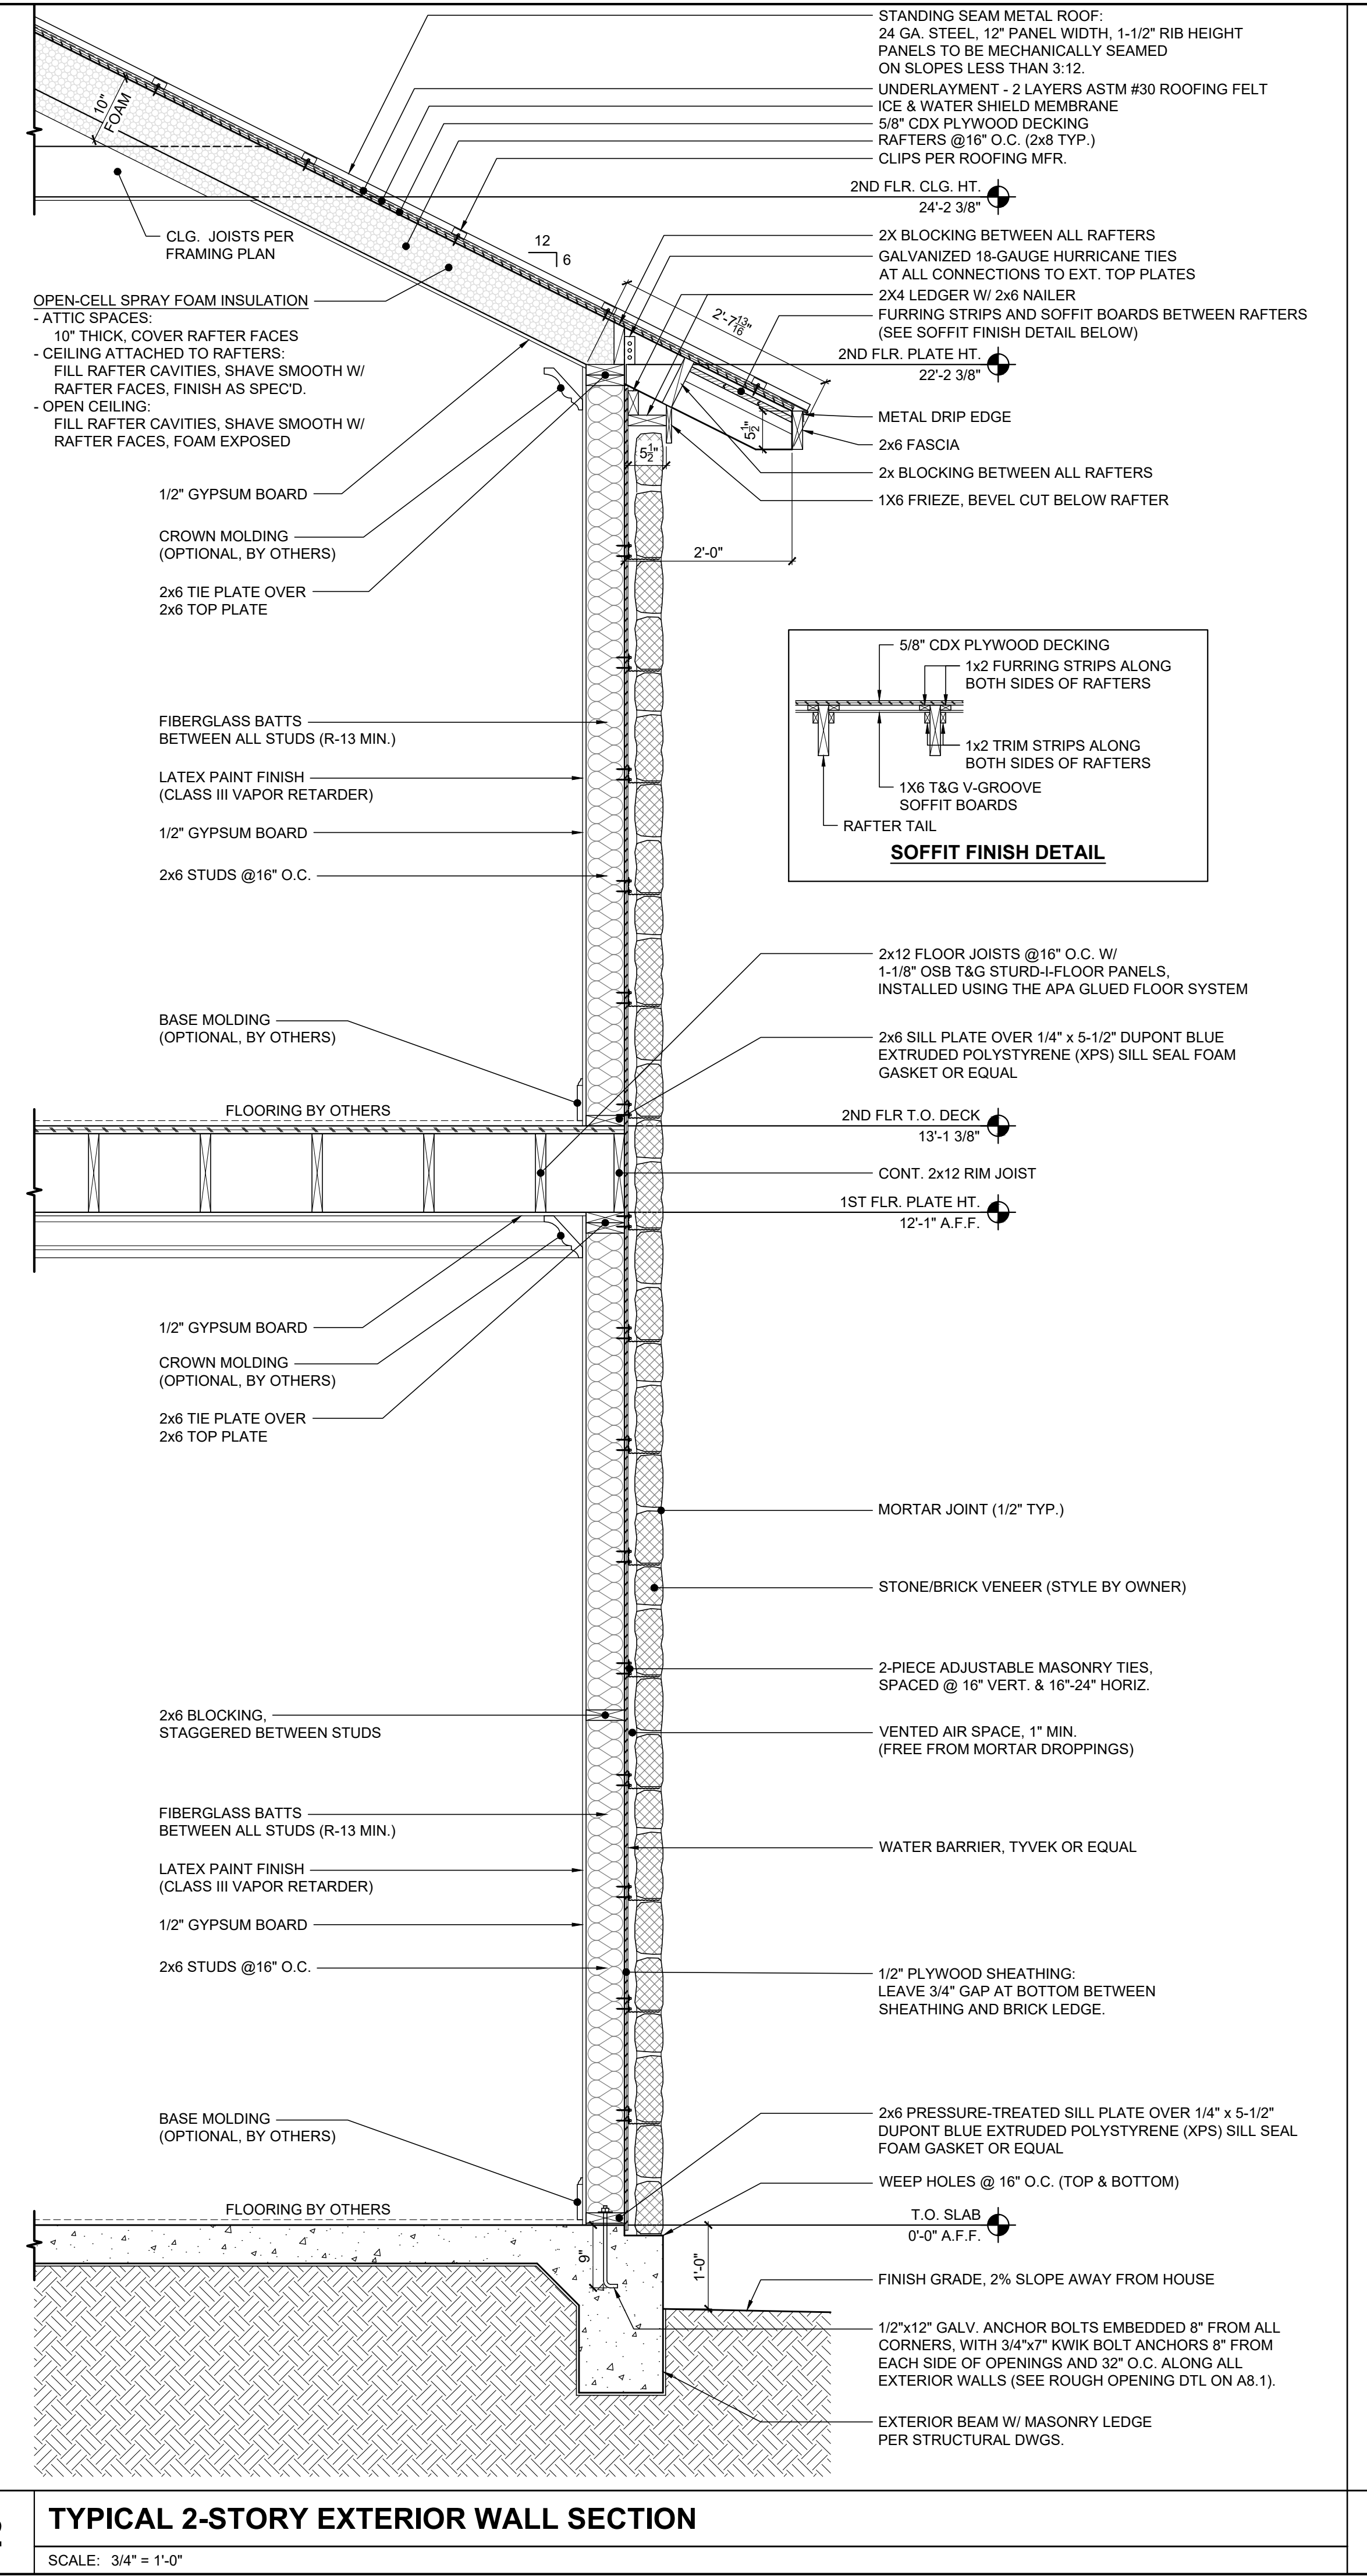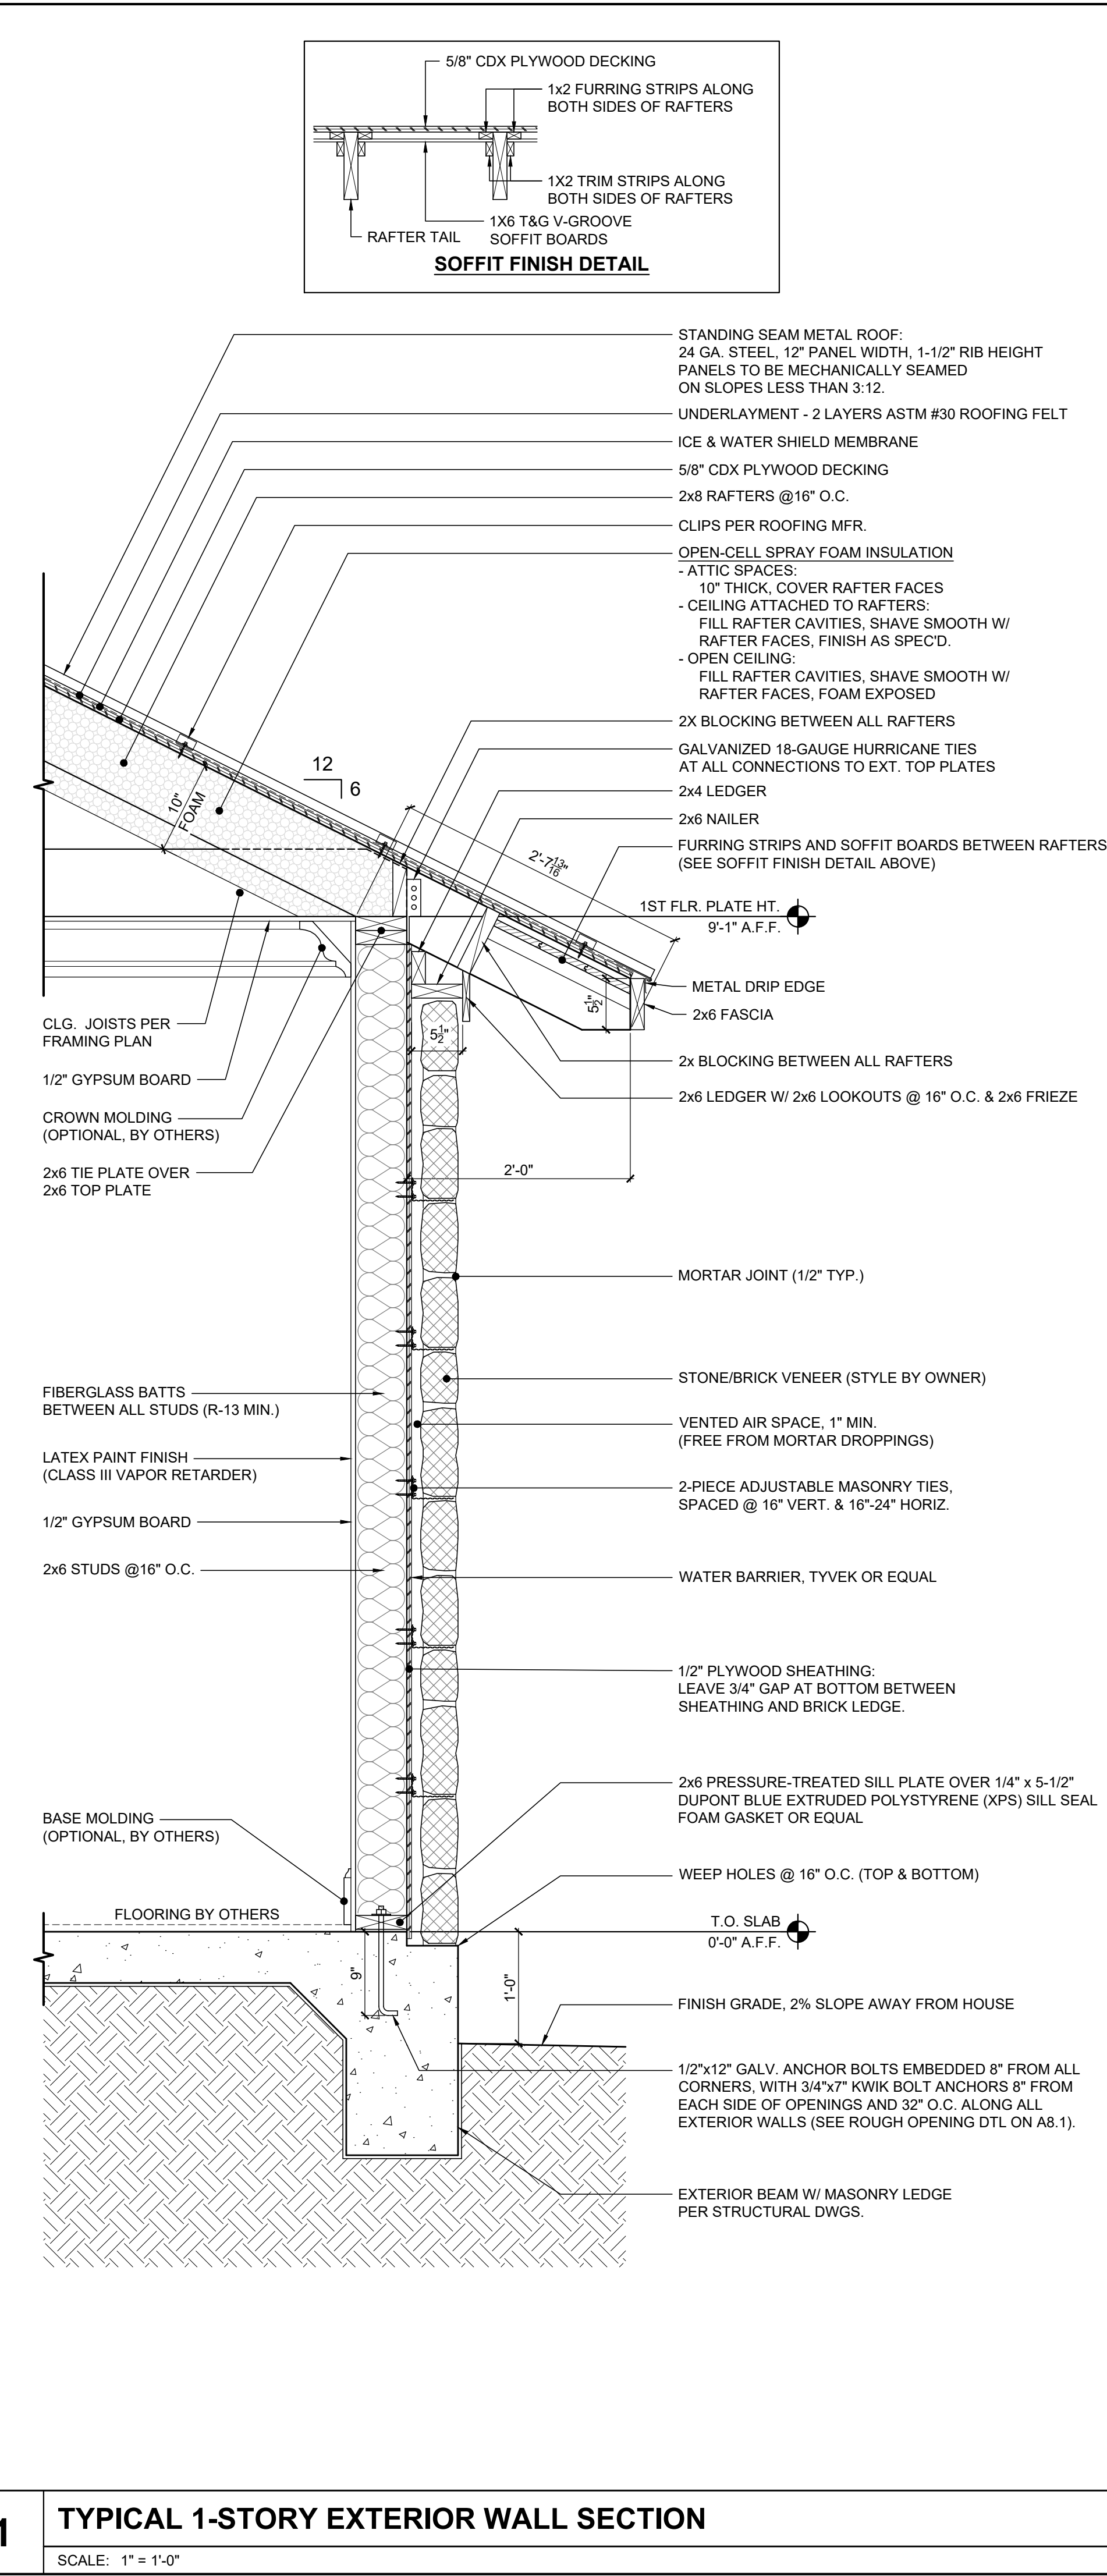
2015 INTERNATIONAL RESIDENTIAL CODE® TABLE R802.4(2) CEILING JOIST SPANS FOR COMMON LUMBER SPECIES (Uninhabitable Attics With Limited Storage, Live Load = 20 psf, L/A = 240)										
CEILING JOIST SPACING (inches)	SPECIES AND GRADE	DEAD LOAD = 10 psf				DEAD LOAD = 20 psf				
		2x4	2x6	2x8	2x10	2x4	2x6	2x8	2x10	
		Maximum ceiling joist spans								
(ft.-in.)	(ft.-in.)	(ft.-in.)	(ft.-in.)	(ft.-in.)	(ft.-in.)	(ft.-in.)	(ft.-in.)	(ft.-in.)	(ft.-in.)	
12	Douglas fir-larch SS	10-5	16-4	21-7	Note a	10-5	16-4	21-7	Note a	
	Douglas fir-larch #1	10-0	15-9	20-1	24-6	10-0	15-9	20-1	24-6	
	Douglas fir-larch #2	9-10	15-0	19-1	23-3	9-10	15-0	19-1	23-3	
	Douglas fir-larch #3	8-9	12-10	16-3	19-10	8-9	12-10	16-3	19-10	
	Hem-fir SS	9-10	15-6	20-5	Note a	9-10	15-6	20-5	Note a	
	Hem-fir #1	9-8	15-2	19-10	24-3	9-8	15-2	19-10	24-3	
	Hem-fir #2	9-2	14-5	18-6	22-7	9-2	14-5	18-6	22-7	
	Hem-fir #3	7-8	11-2	14-2	17-4	7-8	11-2	14-2	17-4	
	Southern pine SS	10-3	16-1	21-2	Note a	10-3	16-1	21-2	Note a	
	Southern pine #1	9-10	15-6	20-5	24-0	9-10	15-6	20-5	24-0	
	Southern pine #2	9-5	14-9	19-6	23-5	9-5	14-9	19-6	23-5	
	Southern pine #3	7-2	10-6	13-3	16-1	7-2	10-6	13-3	16-1	
Spruce-pine-fir SS	9-8	15-2	19-11	25-5	9-8	15-2	19-11	25-5		
Spruce-pine-fir #1	9-5	14-9	19-6	24-10	9-5	14-9	19-6	24-10		
Spruce-pine-fir #2	9-5	14-9	19-6	24-10	9-5	14-9	19-6	24-10		
Spruce-pine-fir #3	7-8	11-2	14-2	17-4	7-8	11-2	14-2	17-4		
16	Douglas fir-larch SS	9-6	14-11	19-7	25-0	9-6	14-11	19-7	25-0	
	Douglas fir-larch #1	8-11	13-9	18-11	23-3	8-11	13-9	18-11	23-3	
	Douglas fir-larch #2	8-11	14-1	18-2	22-3	8-11	14-1	18-2	22-3	
	Douglas fir-larch #3	6-10	11-1	14-1	17-2	6-10	11-1	14-1	17-2	
	Hem-fir SS	8-11	14-1	18-6	23-8	8-11	14-1	18-6	23-8	
	Hem-fir #1	8-9	13-5	17-7	22-7	8-9	13-5	17-7	22-7	
	Hem-fir #2	8-4	13-1	17-3	21-11	8-4	13-1	17-3	21-11	
	Hem-fir #3	7-5	10-10	13-9	16-9	7-5	10-11	13-9	16-9	
	Southern pine SS	9-4	14-7	19-3	24-7	9-4	14-7	19-3	24-7	
	Southern pine #1	8-11	13-9	18-6	23-2	8-11	13-7	17-2	20-1	
	Southern pine #2	8-7	13-5	17-1	20-3	8-7	13-5	17-1	20-3	
	Southern pine #3	6-11	10-2	12-10	15-7	6-11	10-2	12-10	15-7	
Spruce-pine-fir SS	8-9	13-9	18-1	23-1	8-9	13-9	18-1	23-1		
Spruce-pine-fir #1	8-7	13-5	17-9	22-3	8-7	13-5	17-9	22-3		
Spruce-pine-fir #2	8-7	13-5	17-9	22-3	8-7	13-5	17-9	22-3		
Spruce-pine-fir #3	6-8	9-8	12-4	15-0	6-8	9-8	12-4	15-0		
19.2	Douglas fir-larch SS	8-11	14-0	18-5	23-7	8-11	14-0	18-5	23-0	
	Douglas fir-larch #1	8-7	13-6	17-9	21-8	8-7	13-6	17-9	21-8	
	Douglas fir-larch #2	8-5	13-3	16-3	20-7	8-5	13-3	16-3	20-7	
	Douglas fir-larch #3	6-11	10-2	12-10	15-8	6-11	10-2	12-10	15-8	
	Hem-fir SS	8-5	13-3	17-5	22-3	8-5	13-3	17-5	22-3	
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	Hem-fir #2	7-10	12-4	16-3	20-0	7-10	12-4	16-3	20-0	
	Hem-fir #3	6-9	9-11	12-7	15-4	6-9	9-11	12-7	15-4	
	Southern pine SS	8-9	13-9	18-2	23-1	8-9	13-9	18-2	23-1	
	Southern pine #1	8-5	13-3	17-5	21-2	8-5	13-4	17-8	21-9	
	Southern pine #2	8-1	12-3	15-7	18-6	8-1	12-3	15-7	18-6	
	Southern pine #3	6-4	9-4	11-9	14-3	6-4	9-4	11-9	14-3	
Spruce-pine-fir SS	8-3	12-11	17-1	21-9	8-3	12-11	17-1	21-9		
Spruce-pine-fir #1	8-1	12-8	16-7	20-3	8-1					





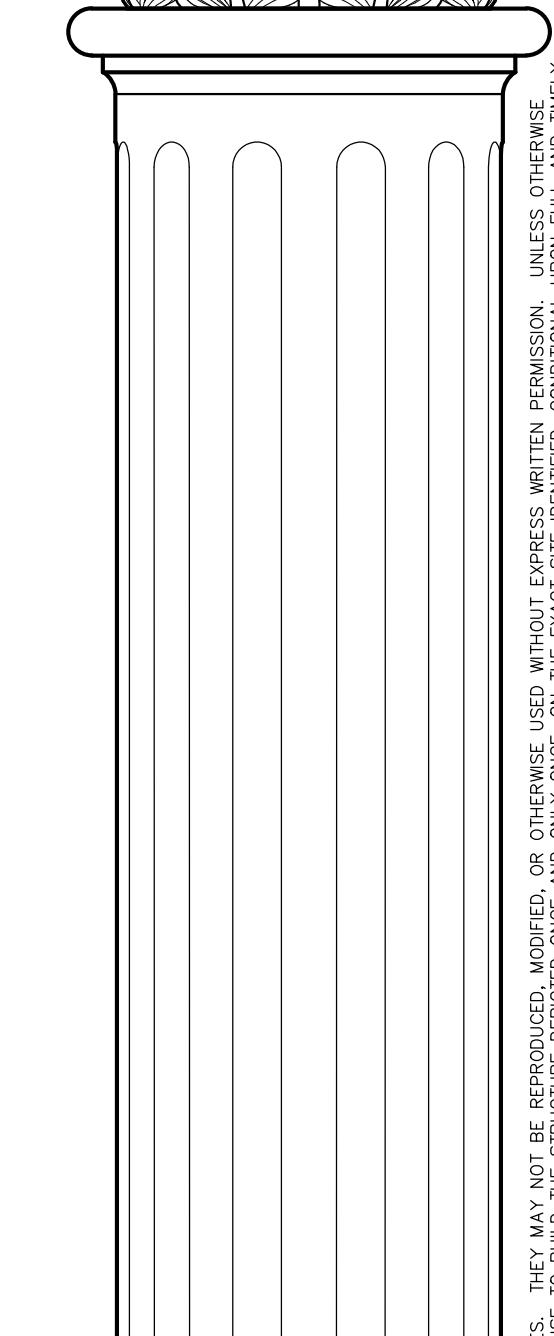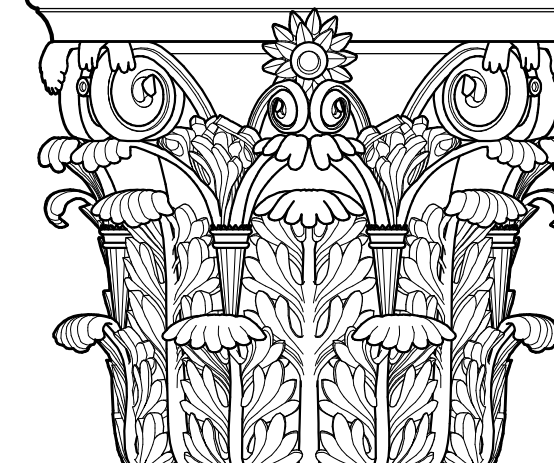


**PROJECT:**  
**INGRAM RESIDENCE**  
 STEPHEN & TAMARA INGRAM  
 3702 S.H. 75 N.  
 HUNTSVILLE, TX 77340  
 WALKER COUNTY

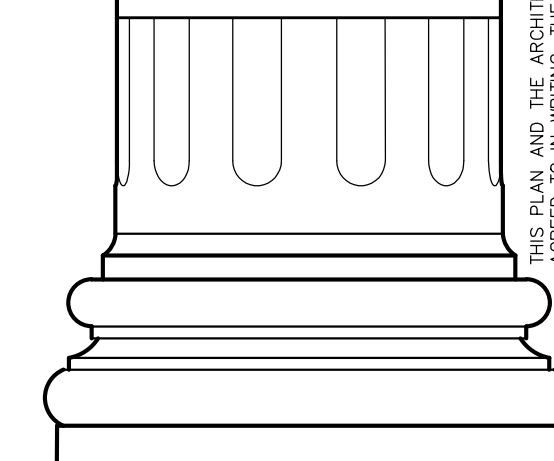

DATE: 08/26/2018	DRAWN BY: SJ
SCALE: 1/4" = 1'-0"	CHECKED: DM



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**MAIN HOUSE**  
**ELECTRICAL PLAN**  
AAE1.1

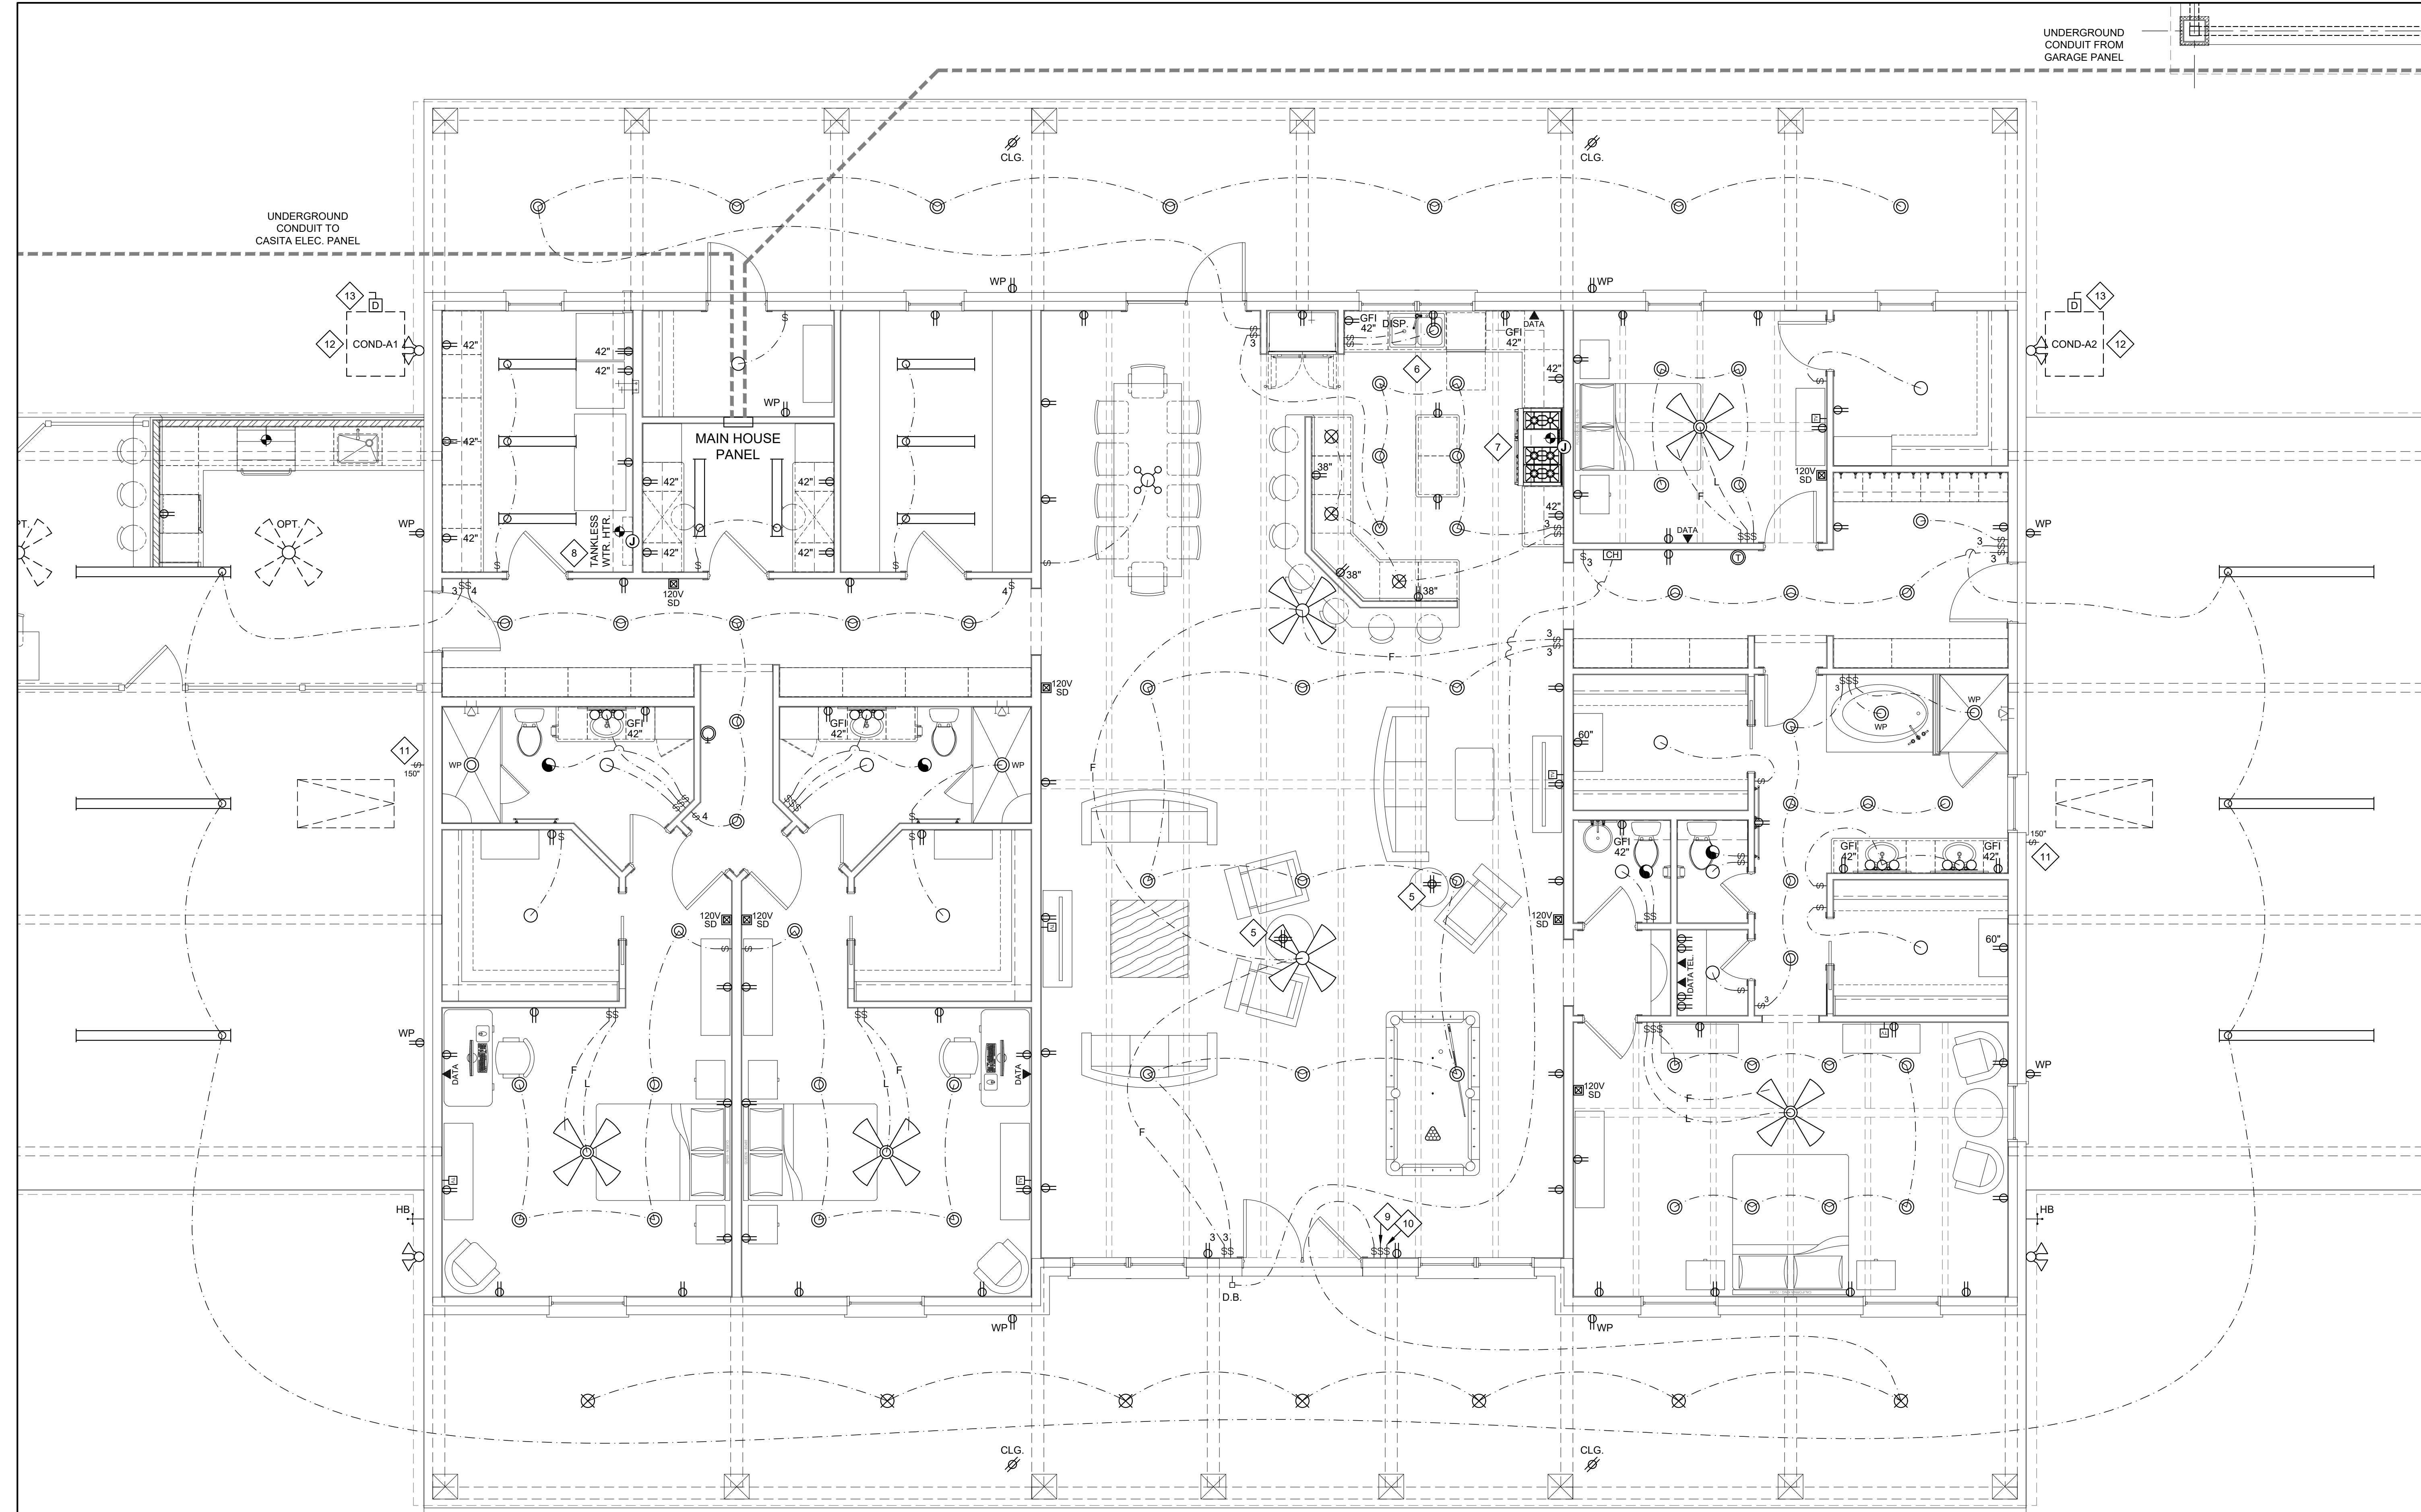


- ELECTRICAL NOTES:**
- |   |  |  |
|---|--|--|
| <p>1. PROVIDE AND INSTALL ALL ELECTRICAL WIRING AND DEVICES ACCORDING TO ALL APPLICABLE FEDERAL, STATE, AND LOCAL CODES.</p> <p>2. ALL ELECTRICAL, PHONE, AND T.V. OUTLETS SHALL BE MOUNTED AT 16" A.F.F. UNLESS NOTED OTHERWISE. THIS HEIGHT AND OTHER HEIGHTS NOTED SHALL BE MEASURED TO THE CENTER OF THE OUTLET. OUTLETS BENEATH WINDOWS SHALL BE INSTALLED AT HEIGHT ELECTRICIAN DEEMS NECESSARY TO FIT.</p> <p>3. ALL ELECTRICAL SWITCHES SHALL BE MOUNTED AT 48" A.F.F. UNLESS NOTED OTHERWISE. THIS HEIGHT AND OTHER HEIGHTS NOTED SHALL BE MEASURED TO THE CENTER OF THE SWITCH.</p> <p>4. VERIFY POWER AND INSTALLATION REQUIREMENTS OF ALL APPLIANCES AND FIXTURES WITH OWNER PRIOR TO INSTALLATION.</p> | <p>5. VERIFY LOCATIONS OF RECESSED FLOOR PLUGS WITH OWNER PRIOR TO INSTALLATION. FLOOR PLUGS SHOULD NOT EXCEED (4) PLUGS PER CIRCUIT.</p> <p>6. PROVIDE 120V POWER BENEATH SINK FOR GARBAGE DISPOSAL AND DISHWASHER.</p> <p>7. PROVIDE 120V JUNCTION BOX FOR RANGE AND VENT HOOD.</p> <p>8. PROVIDE JUNCTION BOX AND/OR POWER OUTLET FOR WATER HEATER.</p> <p>9. ALL FLOOD LIGHTS ON HOUSE TO BE CONTROLLED FROM THIS SWITCH, ON A SINGLE CIRCUIT, OPERATED BY MOTION SENSOR. VERIFY LOCATIONS OF ALL FLOOD LIGHTS WITH OWNER PRIOR TO INSTALLATION.</p> | <p>10. ALL EAVE PLUGS TO BE CONTROLLED FROM THIS SWITCH, ON A SINGLE CIRCUIT, OPERATED BY PHOTOCELL. VERIFY LOCATIONS OF ALL EAVE PLUGS WITH OWNER PRIOR TO INSTALLATION.</p> <p>11. VERIFY LOCATION AND TYPES OF POWER AND LIGHTING IN ATTIC WITH OWNER PRIOR TO INSTALLATION.</p> <p>12. VERIFY POWER REQUIREMENTS FOR ALL HVAC EQUIPMENT PRIOR TO INSTALLATION.</p> <p>13. PROVIDE DISCONNECT AT EACH UNIT FOR EXTERNAL HVAC EQUIPMENT.</p> |
|---|--|--|

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**CASITA**  
**ELECTRICAL PLAN**  
ABE1.1

ELECTRICAL LEGEND			
	JUNCTION BOX		120V SMOKE DETECTOR w/ BATTERY BACKUP
	120 VOLT RECEPTACLE		120V SMOKE & CO DETECTOR w/ BATTERY BACKUP
	120 VOLT W/ GROUND FAULT CIRCUIT INTERRUPT		THERMOSTAT
	120 VOLT IN CEILING		DOORBELL CHIMES
	120 VOLT WATERPROOF G.F.I.		CEILING MOUNTED FIXTURE
	120 VOLT IN FLOOR		PENDANT LIGHT
	120 VOLT 1/2 SWITCHED		CHANDELIER
	240 VOLT RECEPTACLE		RECESSED CAN
	CABLE/SATELLITE OUTLET		WP WATERPROOF RECESSED CAN
	TELEPHONE OUTLET		RECESSED EYEBALL SPOT
	SINGLE POLE SWITCH		WALL MOUNTED FIXTURE
	THREE WAY SWITCH		ABOVE MIRROR LIGHTING
	FOUR WAY SWITCH		WALL MOUNTED PICTURE LIGHT
	DIMMER SWITCH		
	PUSH BUTTON SWITCH		
	GARAGE DOOR SAFETY LINK		
	PORCELAIN FIXTURE w/ PULL CORD		EXHAUST FAN
	EXHAUST FAN w/ LIGHT		COMBO FAN / HEAT / LIGHT
	FLOOD LIGHTS		2X4' FLUORESCENT LIGHT BOX
	24" UNDER CABINET LED OR 2' FLUORESCENT LIGHT		1X4' FLUORESCENT LIGHT BOX
	4' FLUORESCENT LIGHT		24" UNDER CABINET LED OR 2' FLUORESCENT LIGHT
	HOSE BIB (FROST-FREE)		GAS/LP CONNECTION
	GAS/LP CONNECTION		CEILING FAN
			CEILING FAN w/ LIGHT
			OPTIONAL CEILING FAN w/ LIGHT
			CEILING LIGHT w/ OPTIONAL FAN (PREWIRE)

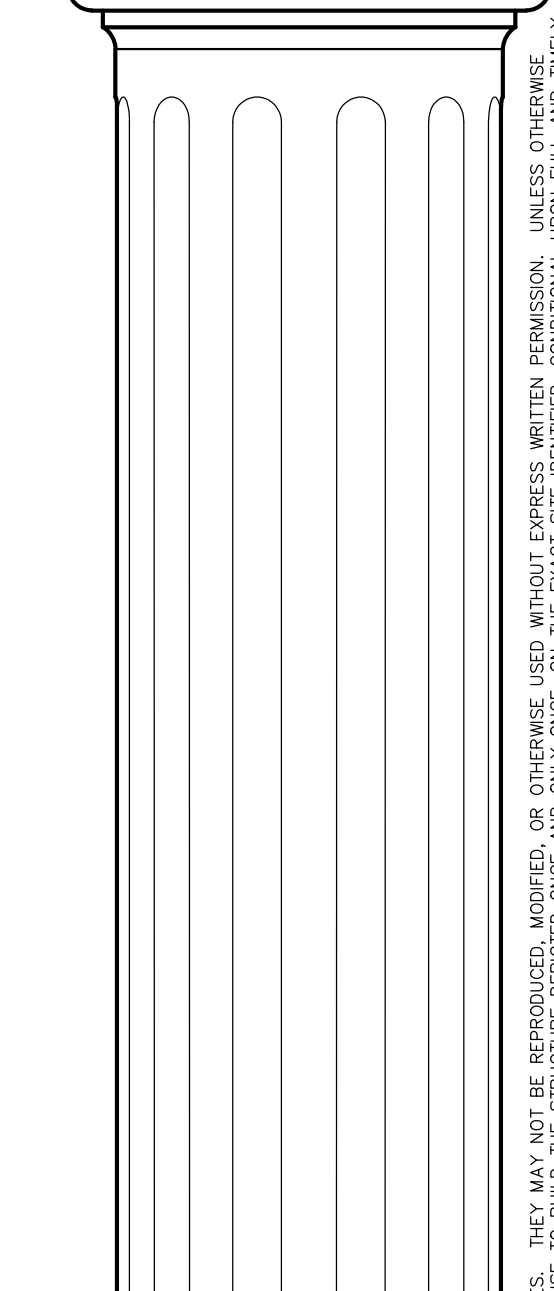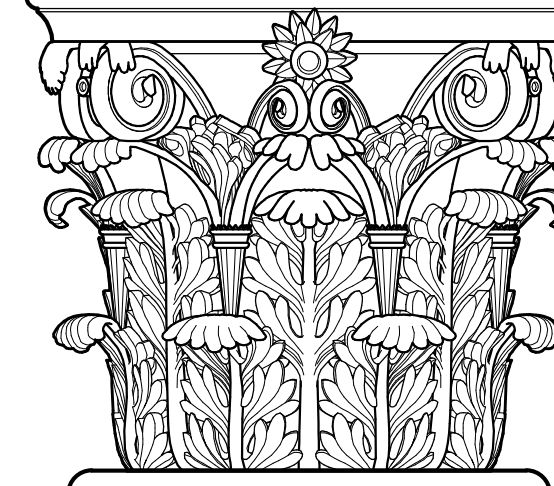2015 INTERNATIONAL RESIDENTIAL CODE  
SECTION R314 SMOKE ALARMS

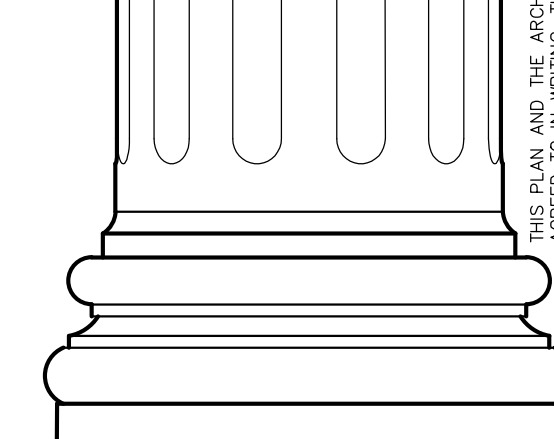**R314.1 GENERAL.**  
SMOKE ALARMS SHALL COMPLY WITH NFPA 72 AND SECTION R314.

**R314.1.1 LISTINGS.**  
SMOKE ALARMS SHALL BE LISTED IN ACCORDANCE WITH UL 217 COMBINATION SMOKE AND CARBON MONOXIDE ALARMS SHALL BE LISTED IN ACCORDANCE WITH UL 217 AND UL 2034.

**R314.2 WHERE REQUIRED.**  
SMOKE ALARMS SHALL BE PROVIDED IN ACCORDANCE WITH THIS SECTION.

**R314.2.1 NEW CONSTRUCTION.**  
SMOKE ALARMS SHALL BE PROVIDED IN DWELLING UNITS.

**R314.2.2 ALTERATIONS, REPAIRS AND ADDITIONS.**  
WHERE ALTERATIONS, REPAIRS OR ADDITIONS REQUIRING A PERMIT OCCUR, OR WHERE ONE OR MORE SLEEPING ROOMS ARE ADDED OR CREATED IN EXISTING DWELLINGS, THE INDIVIDUAL DWELLING UNIT SHALL BE EQUIPPED WITH SMOKE ALARMS LOCATED AS REQUIRED FOR NEW DWELLINGS.

**EXCEPTIONS:**

1. WORK INVOLVING THE EXTERIOR SURFACES OF DWELLINGS, SUCH AS THE REPLACEMENT OF ROOFING OR SIDING, THE ADDITION OR REPLACEMENT OF WINDOWS OR DOORS, OR THE ADDITION OF A PORCH OR DECK, ARE EXEMPT FROM THE REQUIREMENTS OF THIS SECTION.
2. INSTALLATION, ALTERATION OR REPAIRS OF PLUMBING OR MECHANICAL SYSTEMS ARE EXEMPT FROM THE REQUIREMENTS OF THIS SECTION.

**R314.3 LOCATION.**  
SMOKE ALARMS SHALL BE INSTALLED IN THE FOLLOWING LOCATIONS:

1. IN EACH SLEEPING ROOM.
2. OUTSIDE EACH SEPARATE SLEEPING AREA IN THE IMMEDIATE VICINITY OF THE BEDROOMS.
3. ON EACH ADDITIONAL STORY OF THE DWELLING, INCLUDING BASEMENTS AND HABITABLE ATTICS AND NOT INCLUDING CRAWL SPACES AND UNINHABITABLE ATTICS. IN DWELLINGS OR DWELLING UNITS WITH SPLIT LEVELS AND WITHOUT AN INTERVENEING DOOR BETWEEN THE ADJACENT LEVELS, A SMOKE ALARM INSTALLED ON THE UPPER LEVEL SHALL SUFFICE FOR THE ADJACENT LOWER LEVEL PROVIDED THAT THE LOWER LEVEL IS LESS THAN ONE FULL STORY BELOW THE UPPER LEVEL.
4. SMOKE ALARMS SHALL BE INSTALLED NOT LESS THAN 3 FEET (914 MM) HORIZONTALLY FROM THE DOOR OR OPENING OF A BATHROOM THAT CONTAINS A BATHTUB OR SHOWER UNLESS THIS WOULD PREVENT PLACEMENT OF A SMOKE ALARM REQUIRED BY SECTION R314.3.

**R314.3.1 INSTALLATION NEAR COOKING APPLIANCES.**  
SMOKE ALARMS SHALL NOT BE INSTALLED IN THE FOLLOWING LOCATIONS UNLESS THIS WOULD PREVENT PLACEMENT OF A SMOKE ALARM IN A LOCATION REQUIRED BY SECTION R314.3.

1. IONIZATION SMOKE ALARMS SHALL NOT BE INSTALLED LESS THAN 20 FEET (6096 MM) HORIZONTALLY FROM A PERMANENTLY INSTALLED COOKING APPLIANCE.
2. IONIZATION SMOKE ALARMS WITH AN ALARM SILENCING SWITCH SHALL NOT BE INSTALLED LESS THAN 10 FEET (3048 MM) HORIZONTALLY FROM A PERMANENTLY INSTALLED COOKING APPLIANCE.
3. PHOTOELECTRIC SMOKE ALARMS SHALL NOT BE INSTALLED LESS THAN 6 FEET (1828 MM) HORIZONTALLY FROM A PERMANENTLY INSTALLED COOKING APPLIANCE.

**R314.4 INTERCONNECTION.**  
WHERE MORE THAN ONE SMOKE ALARM IS REQUIRED TO BE INSTALLED WITHIN AN INDIVIDUAL DWELLING UNIT IN ACCORDANCE WITH SECTION R314.3, THE ALARM DEVICES SHALL BE INTERCONNECTED IN SUCH A MANNER THAT THE ACTIVATION OF ONE ALARM WILL ACTIVATE ALL OF THE ALARMS IN THE INDIVIDUAL DWELLING PHYSICAL INTERCONNECTION OF SMOKE ALARMS SHALL NOT BE REQUIRED WHERE LISTED WIRELESS ALARMS ARE INSTALLED AND ALL ALARMS SOUND UPON ACTIVATION OF ONE ALARM.

**EXCEPTIONS:**

INTERCONNECTION OF SMOKE ALARMS IN EXISTING AREAS SHALL NOT BE REQUIRED WHERE ALTERATIONS OR REPAIRS DO NOT RESULT IN REMOVAL OF INTERIOR WALL OR CEILING FINISHES EXPOSING THE STRUCTURE, UNLESS THERE IS AN ATTIC, CRAWL SPACE OR BASEMENT AVAILABLE THAT COULD PROVIDE ACCESS FOR INTERCONNECTION WITHOUT THE REMOVAL OF INTERIOR FINISHES.

**R314.5 COMBINATION ALARMS.**  
COMBINATION SMOKE AND CARBON MONOXIDE ALARMS SHALL BE PERMITTED TO BE USED IN LIEU OF SMOKE ALARMS.

**R314.6 POWER SOURCE.**  
SMOKE ALARMS SHALL RECEIVE THEIR PRIMARY POWER FROM THE BUILDING WIRING WHERE SUCH WIRING IS SERVED FROM A COMMERCIAL SOURCE AND, WHERE PRIMARY POWER IS INTERRUPTED, SHALL RECEIVE POWER FROM A BATTERY. WIRING SHALL BE PERMANENT AND WITHOUT A DISCONNECTING SWITCH OTHER THAN THOSE REQUIRED FOR OVERCURRENT PROTECTION.

**EXCEPTIONS:**

1. SMOKE ALARMS SHALL BE PERMITTED TO BE BATTERY OPERATED WHERE INSTALLED IN BUILDINGS WITHOUT COMMERCIAL POWER.
2. SMOKE ALARMS INSTALLED IN ACCORDANCE WITH SECTION R314.2.2 SHALL BE PERMITTED TO BE BATTERY POWERED.


**R314.7 FIRE ALARM SYSTEMS.**  
FIRE ALARM SYSTEMS SHALL BE PERMITTED TO BE USED IN LIEU OF SMOKE ALARMS AND SHALL COMPLY WITH SECTIONS R314.7.1 THROUGH R314.7.4.

**R314.7.1 GENERAL.**  
FIRE ALARM SYSTEMS SHALL COMPLY WITH THE PROVISIONS OF THIS CODE AND THE HOUSEHOLD FIRE WARNING EQUIPMENT PROVISIONS OF NFPA 72. SMOKE DETECTORS SHALL BE LISTED IN ACCORDANCE WITH UL 268.

**R314.7.2 GENERAL.**  
SMOKE DETECTORS SHALL BE INSTALLED IN THE LOCATIONS SPECIFIED IN SECTION R314.3.

**R314.7.3 PERMANENT FIXTURE.**  
WHERE A HOUSEHOLD FIRE ALARM SYSTEM IS INSTALLED, IT SHALL BECOME A PERMANENT FIXTURE OF THE OCCUPANCY, OWNED BY THE HOMEOWNER.

**R314.7.4 COMBINATION DETECTORS.**  
COMBINATION SMOKE AND CARBON MONOXIDE DETECTORS SHALL BE PERMITTED TO BE INSTALLED IN FIRE ALARM SYSTEMS IN LIEU OF SMOKE DETECTORS, PROVIDED THAT THEY ARE LISTED IN ACCORDANCE WITH UL 268 AND UL 2075.

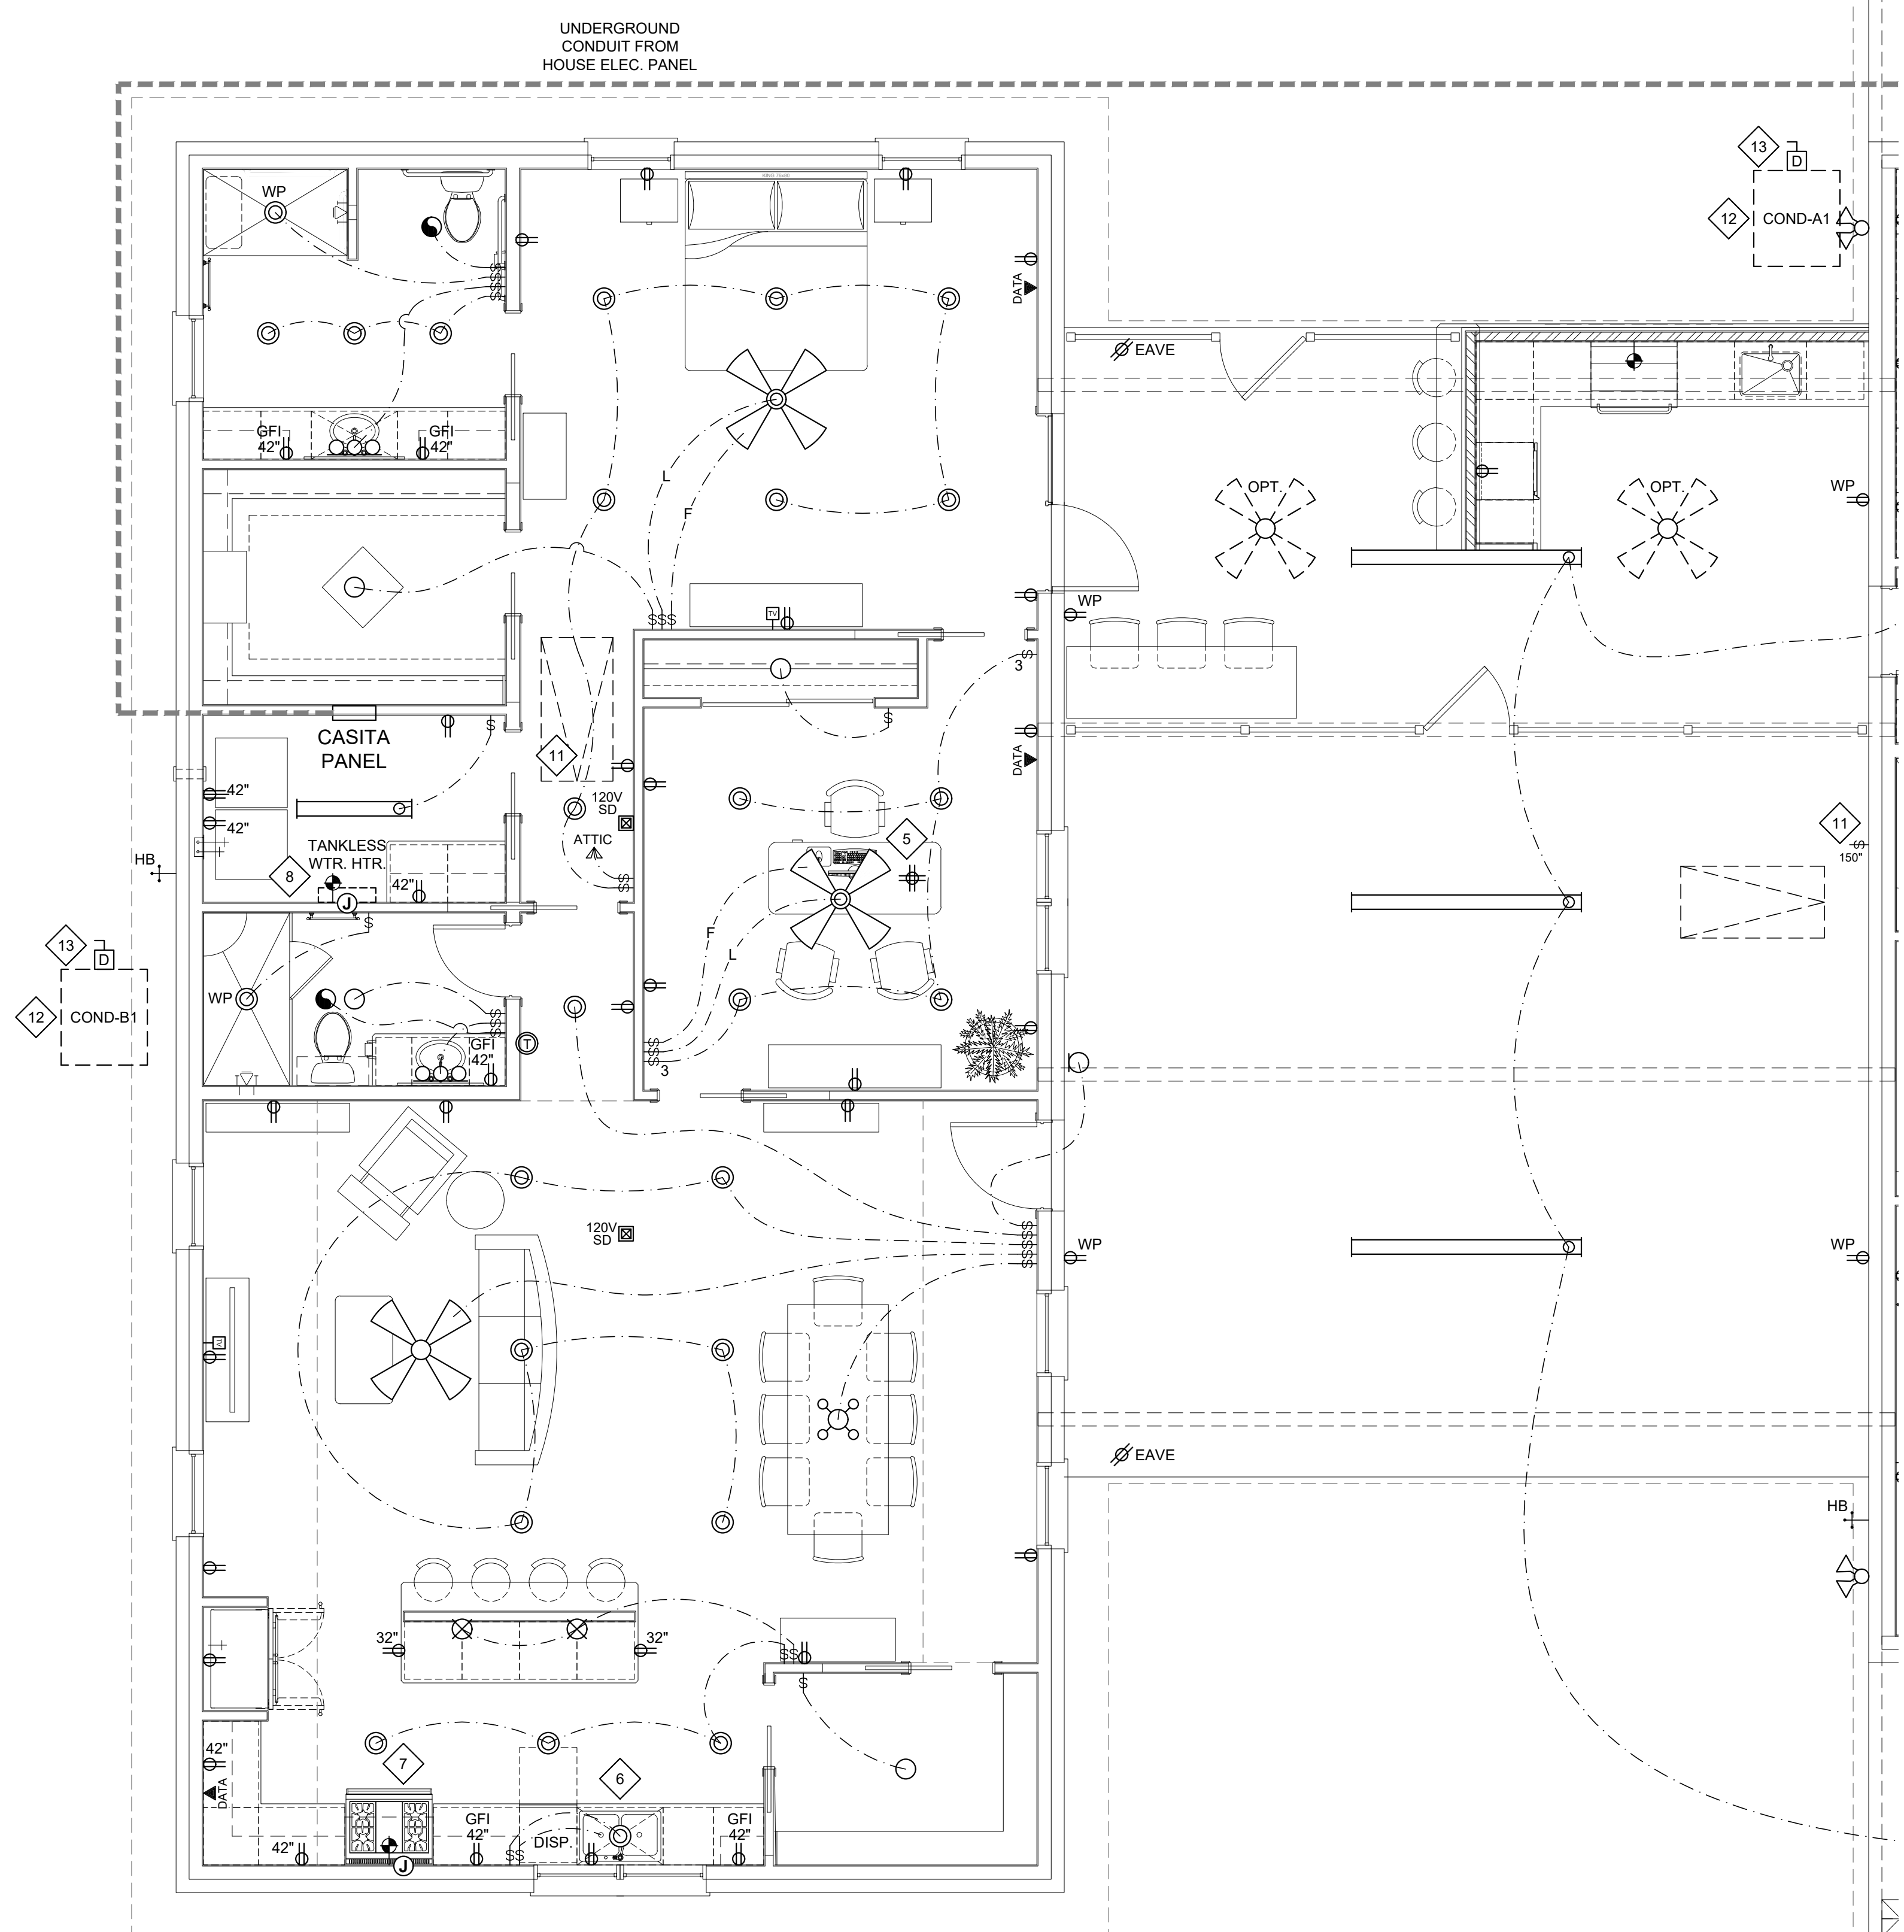


**ELECTRICAL NOTES:**

- |  |   |   |
|--|---|---|
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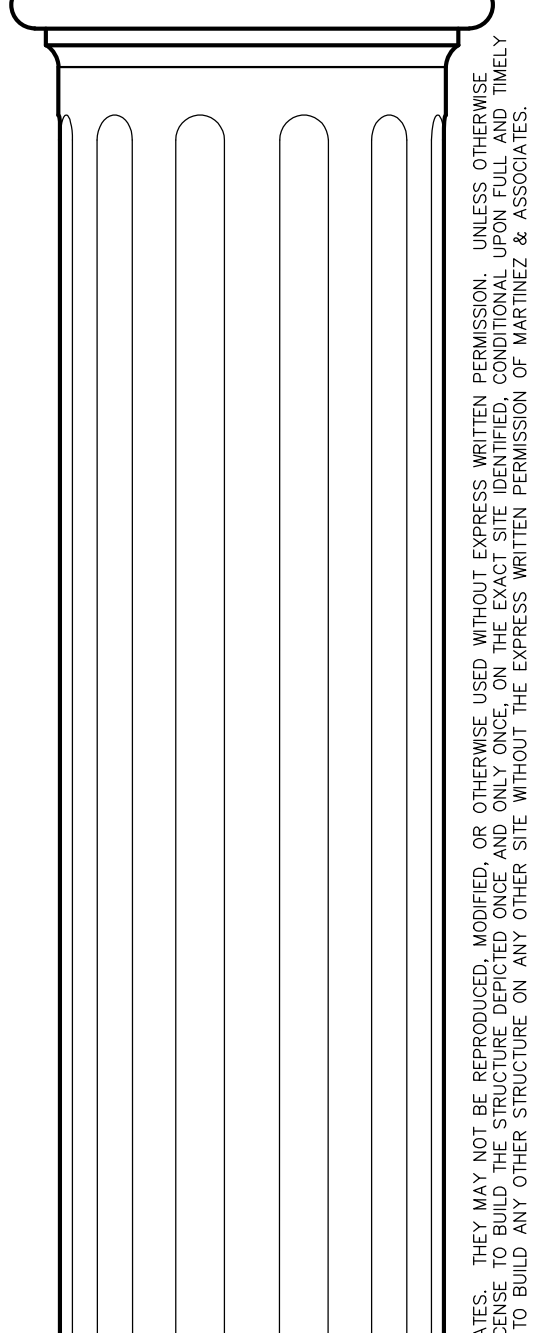
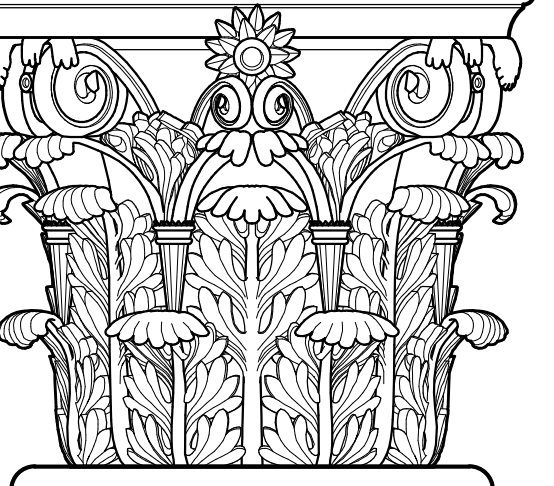
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**DON MARTINEZ  
& ASSOCIATES**  
OFFICE: (936) 439-5168  
CELL: (936) 577-6761



PROJECT:  
**INGRAM RESIDENCE**  
STEPHEN & TAMARA INGRAM  
3702 S.H. 75 N.  
HUNTSVILLE, TX 77340  
WALKER COUNTY


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FOUNDATION  
PIER PLAN

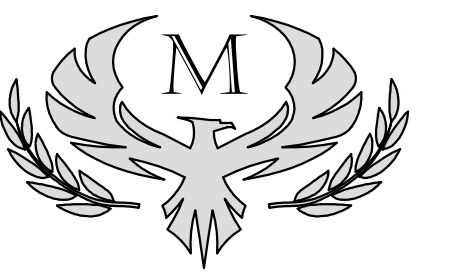
**S2.1**



TOTAL PIERS = 139  
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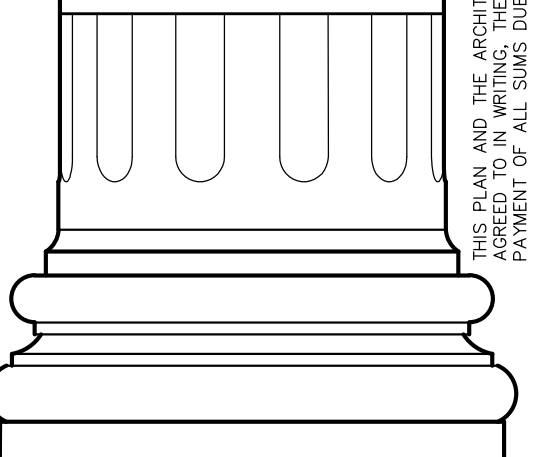


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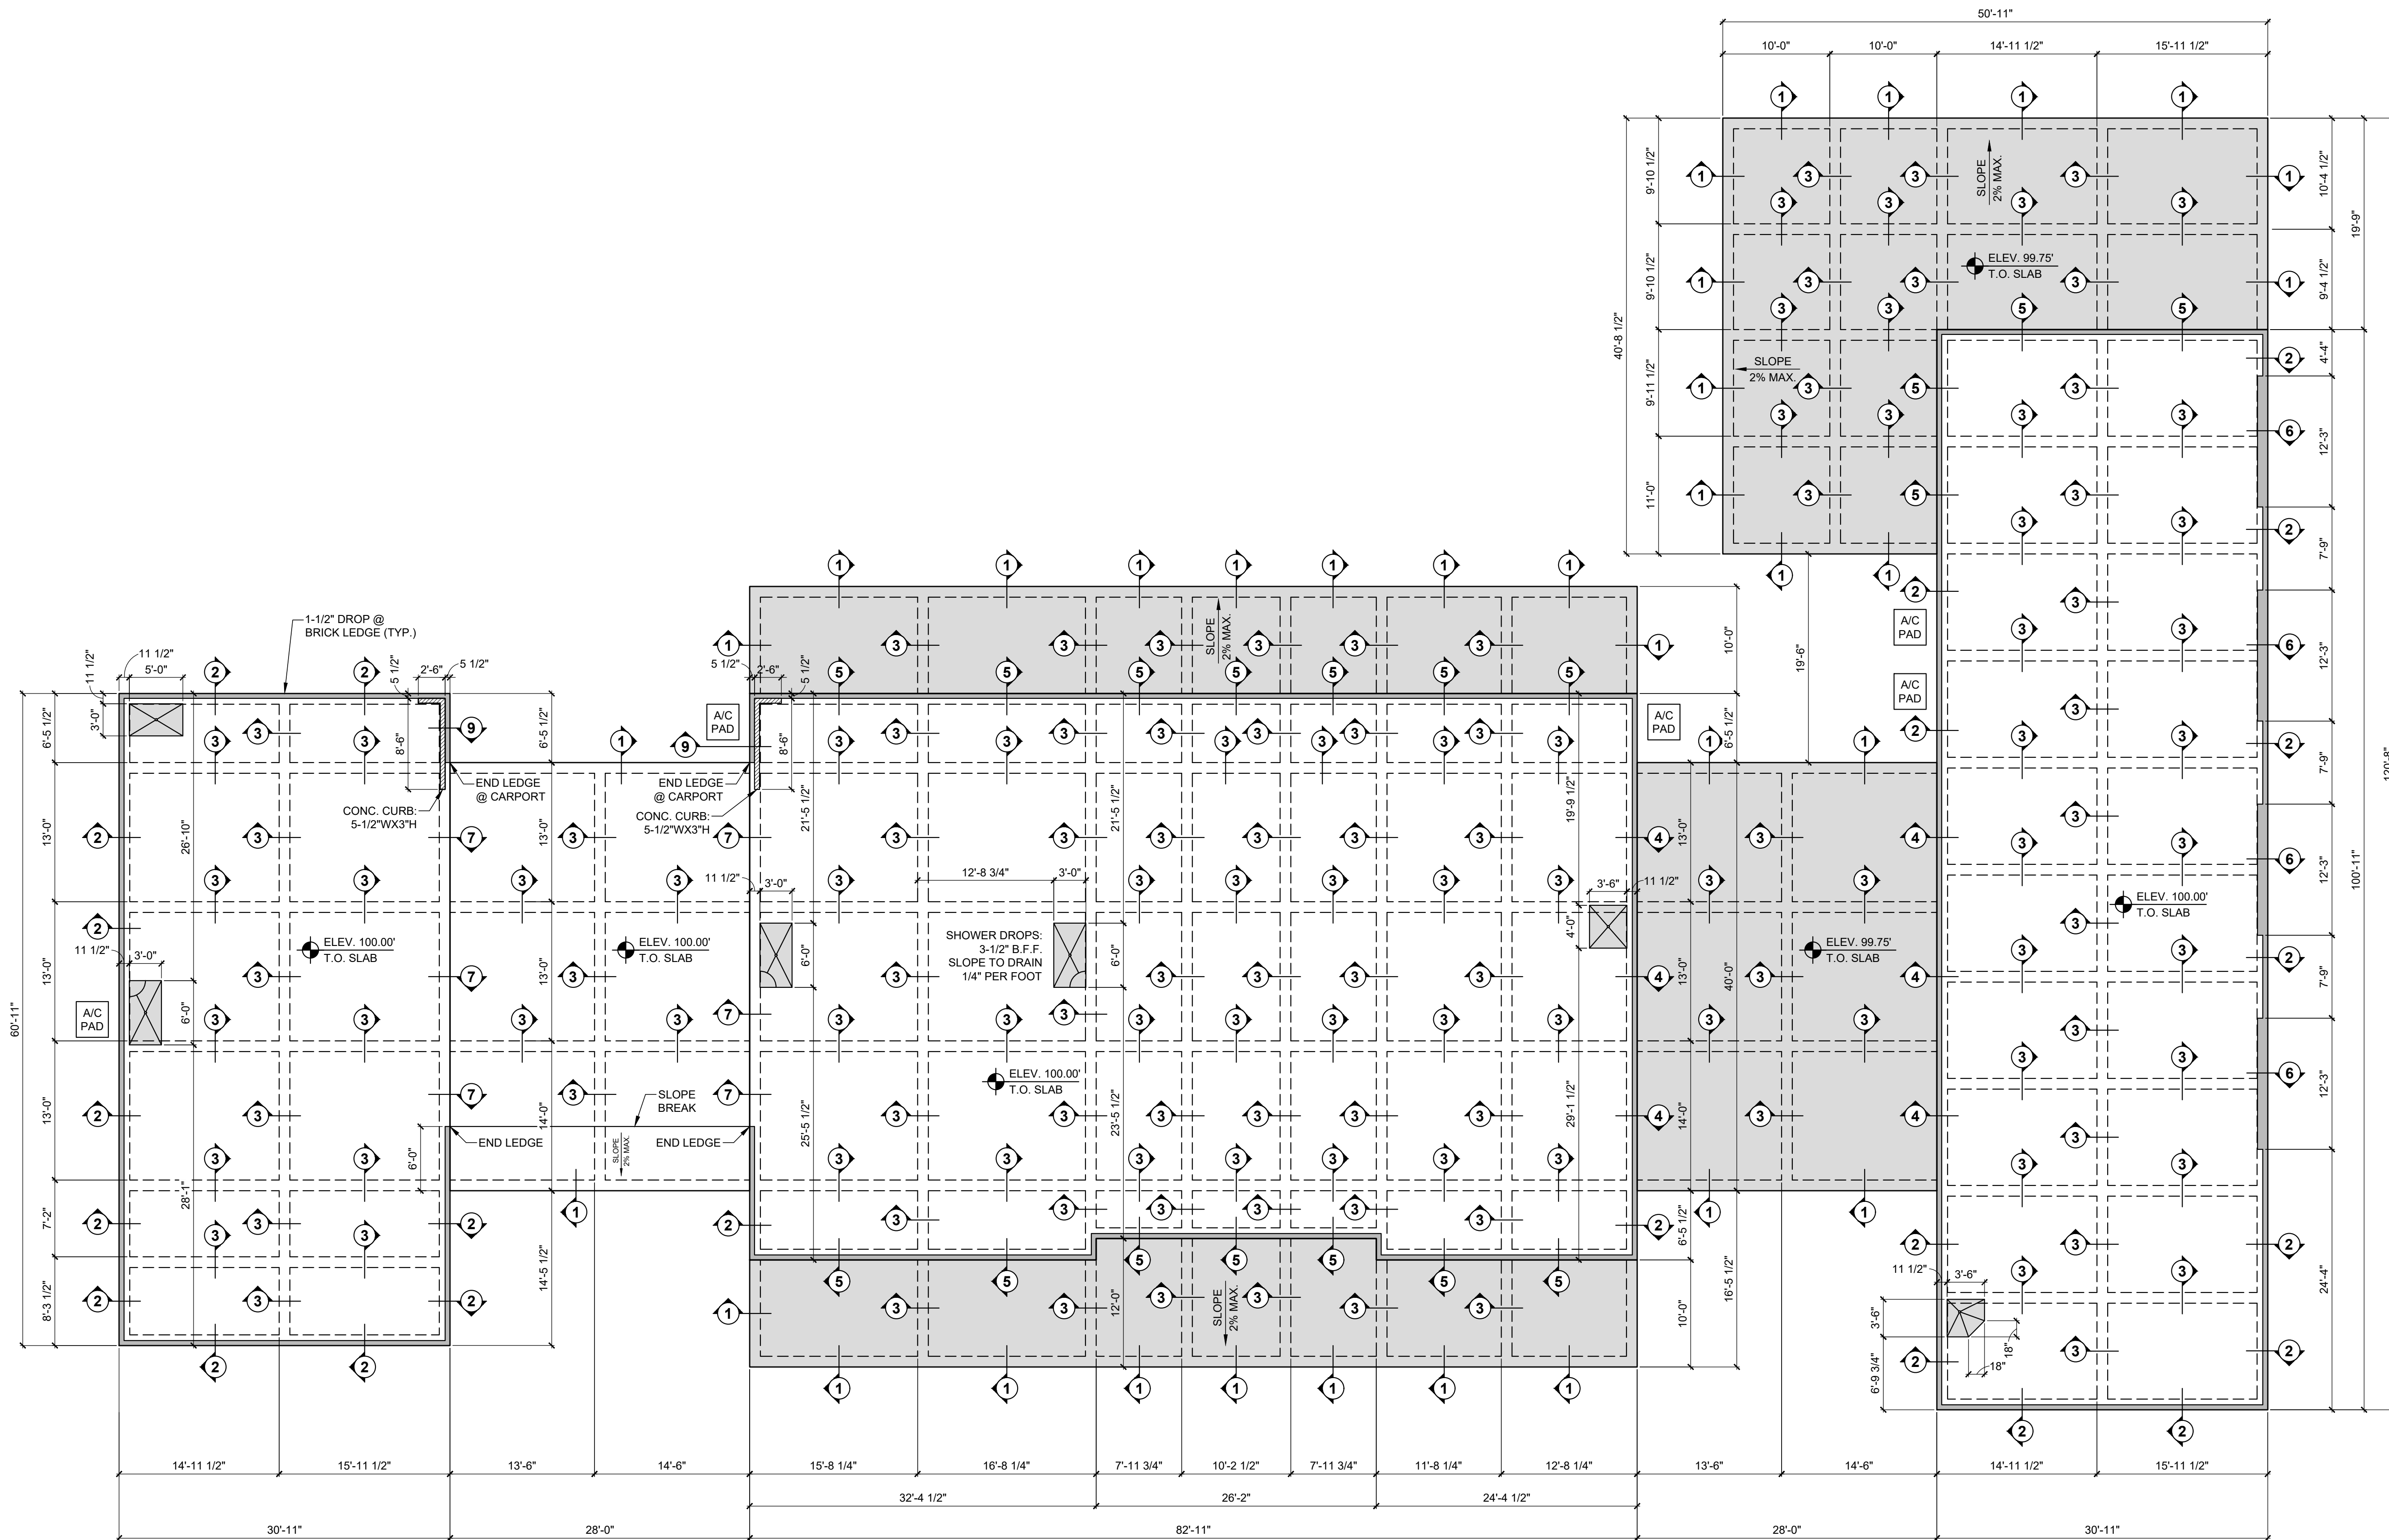
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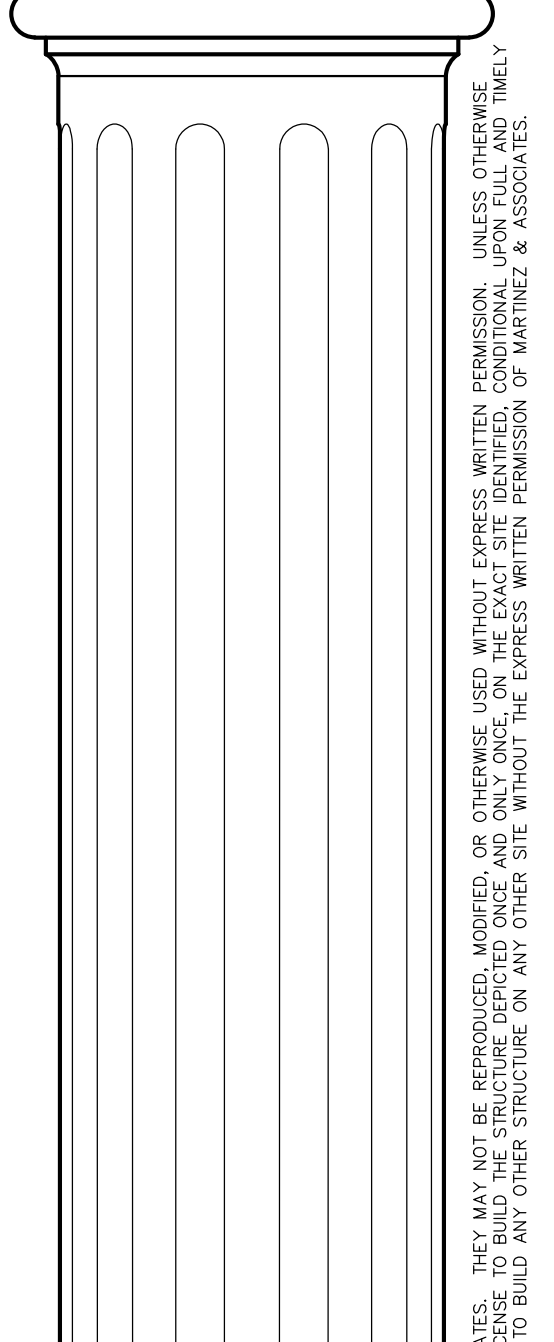
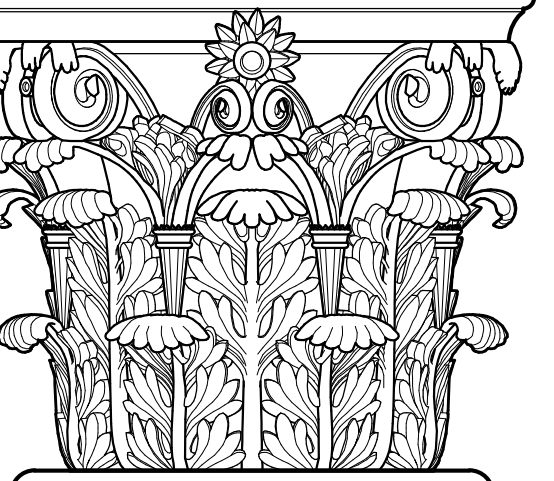
FOUNDATION  
BEAM & SLAB PLAN  
**S2.1**

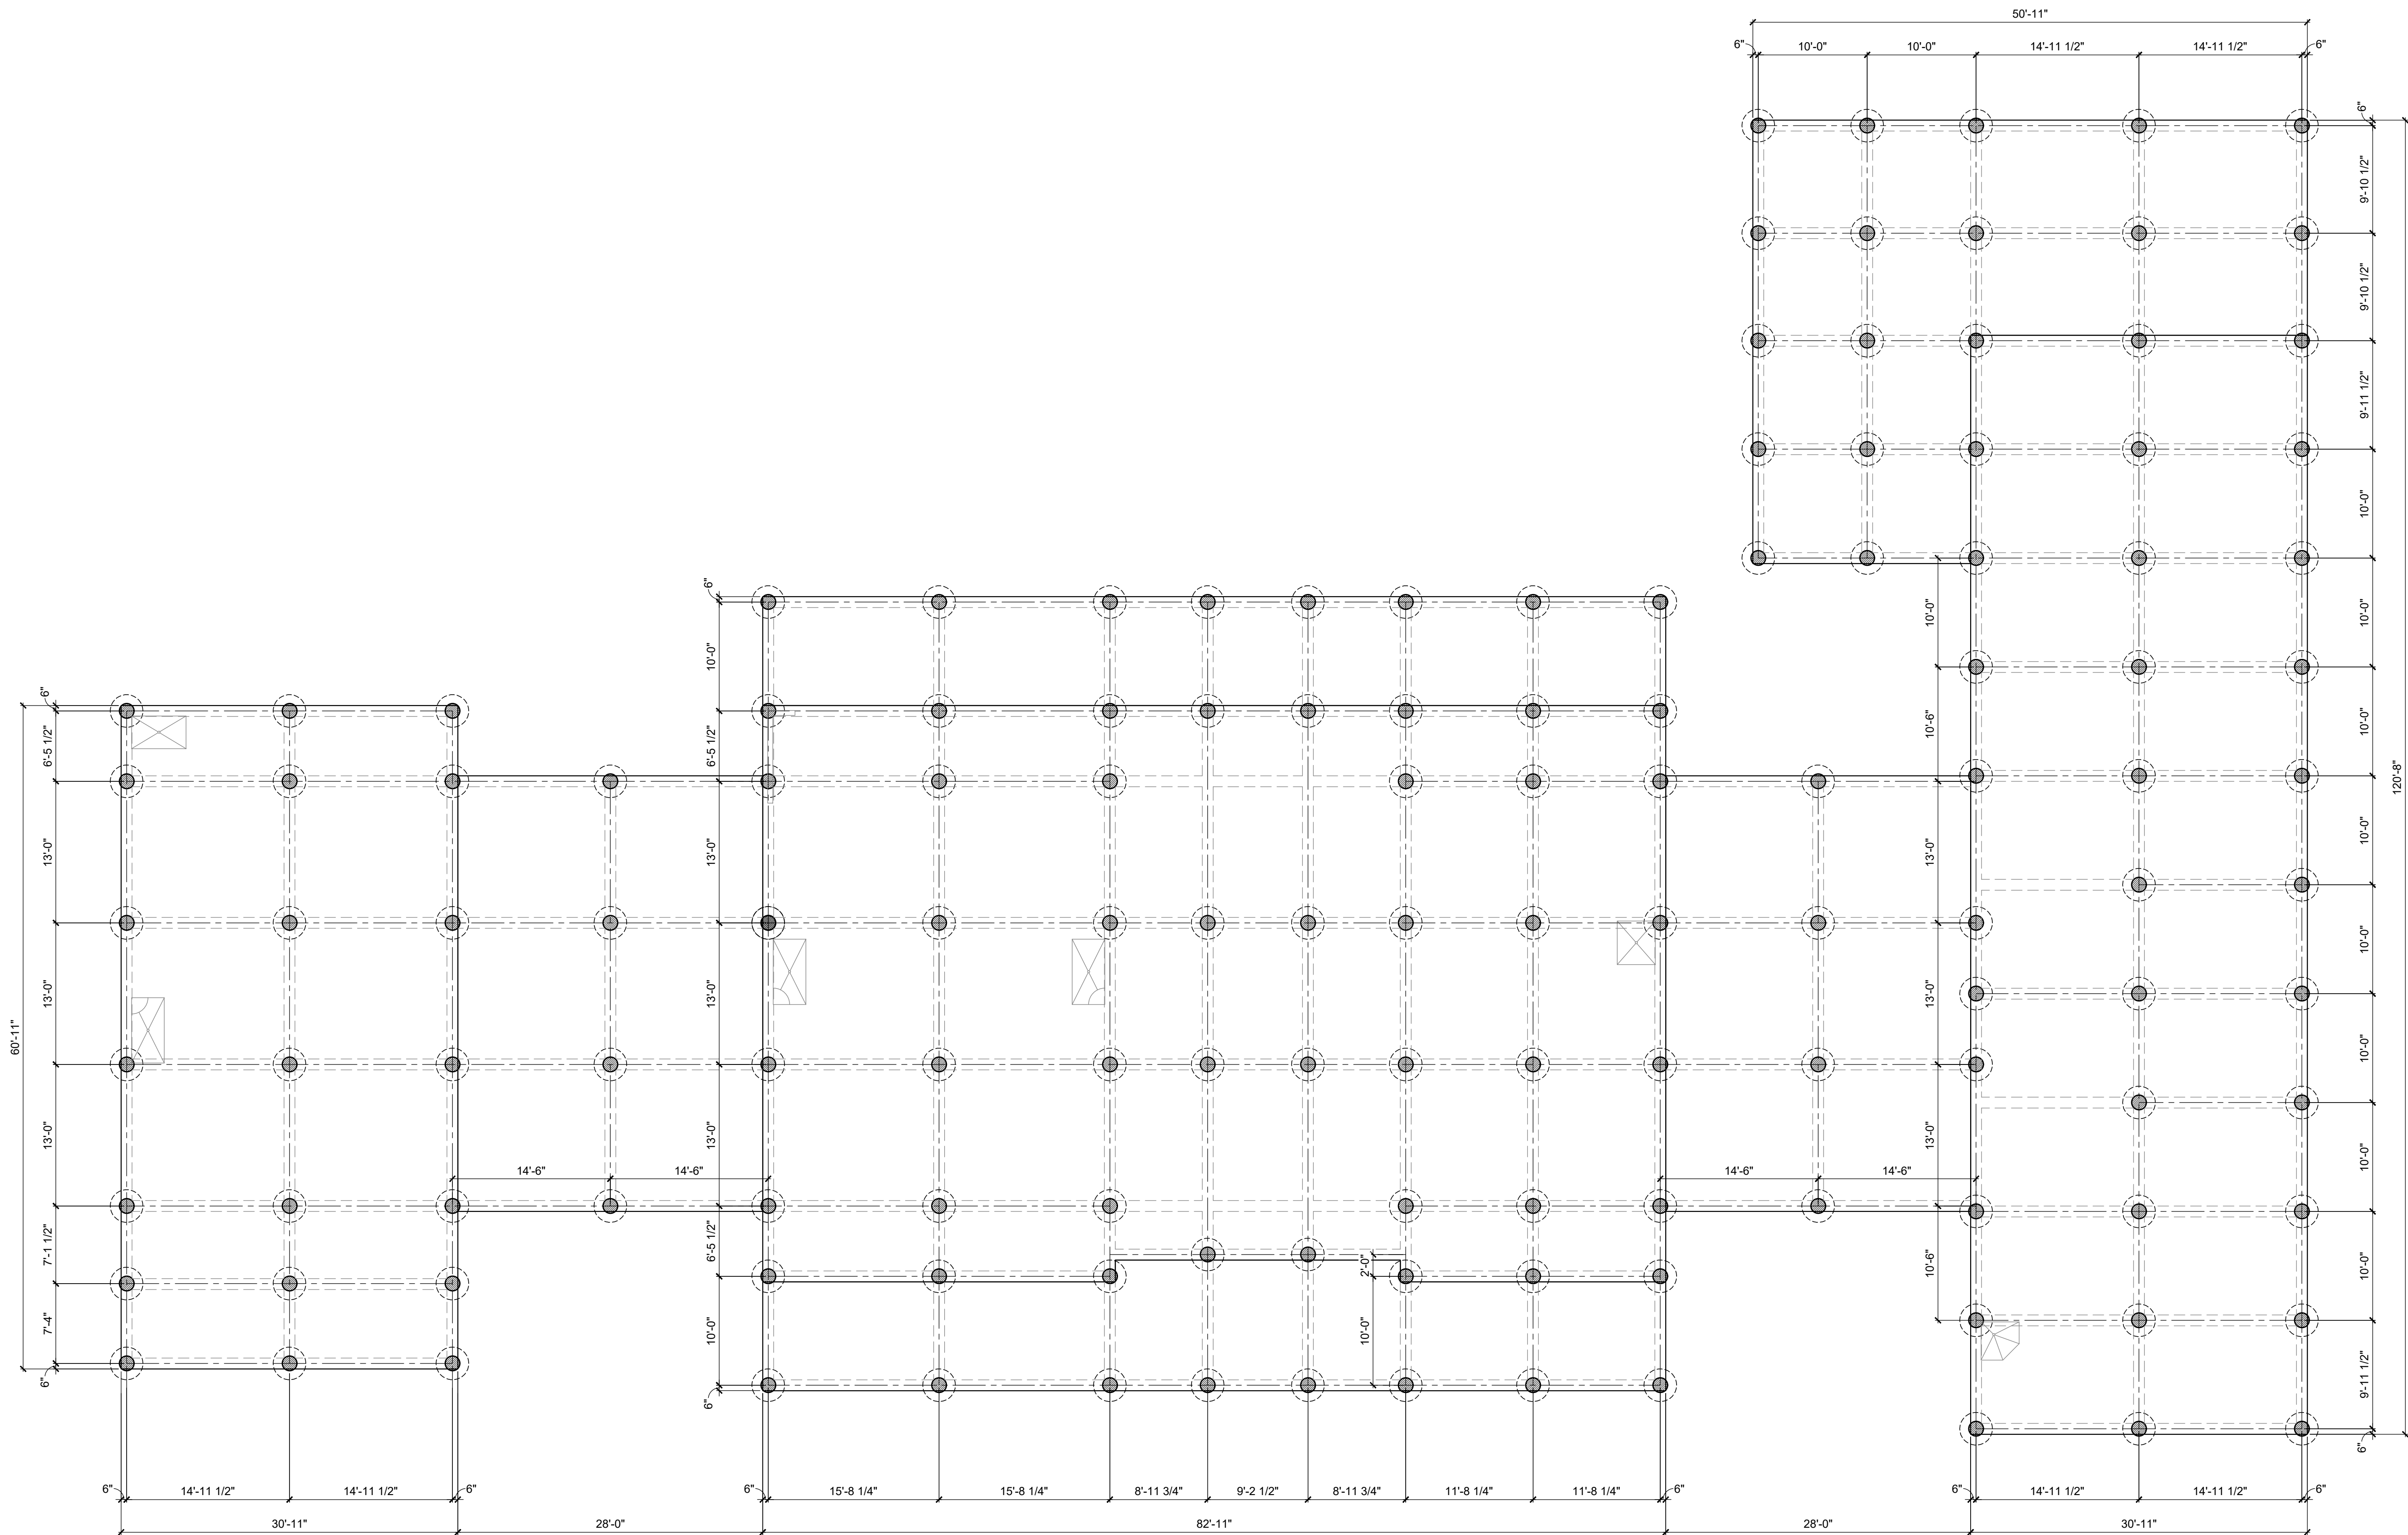

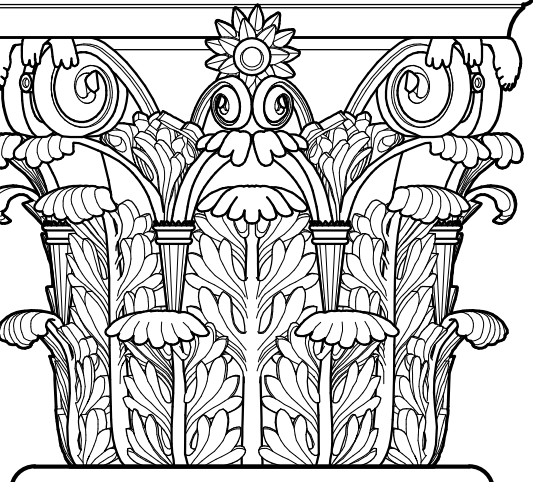REFER TO SHEET S3.1 FOR BEAM & SLAB DETAILS.




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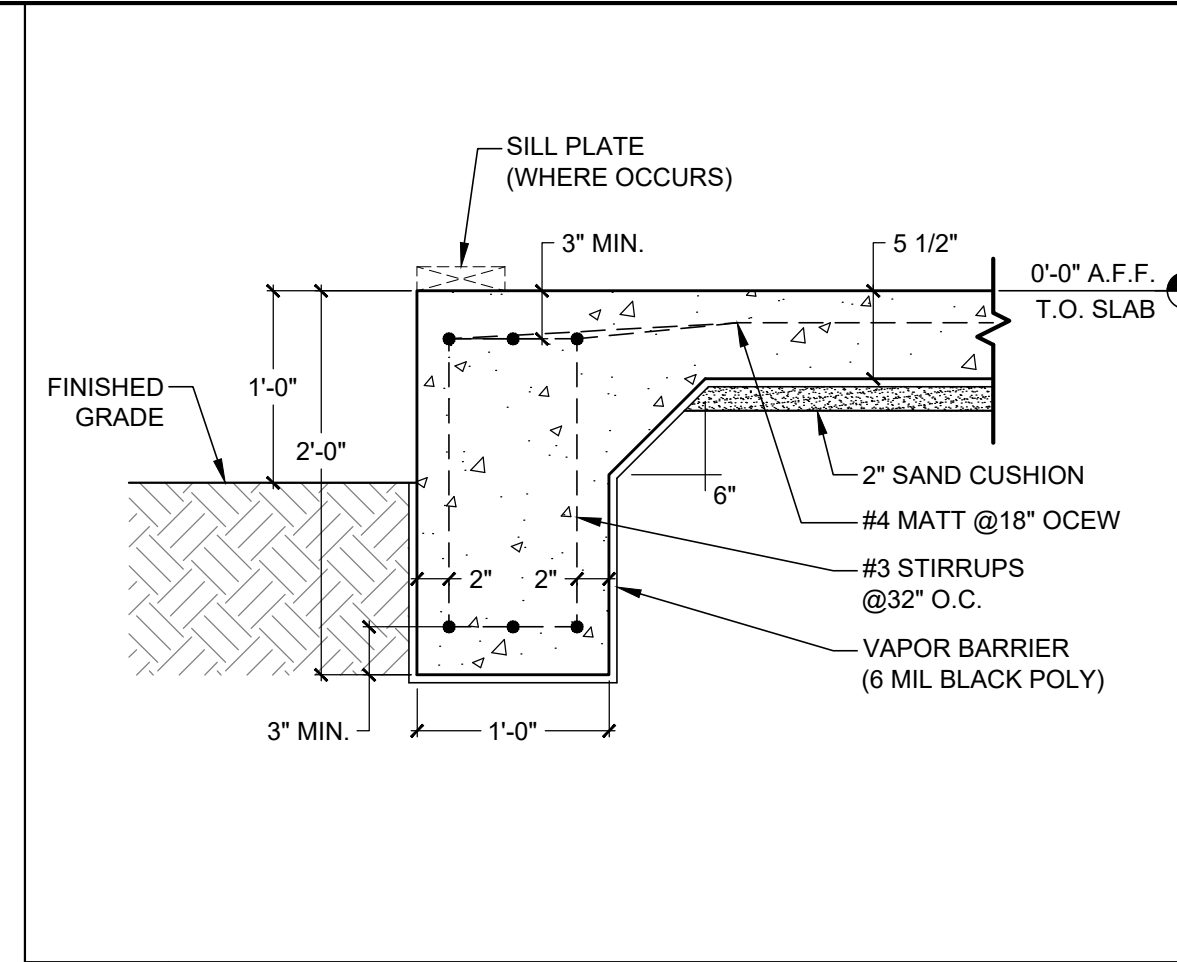
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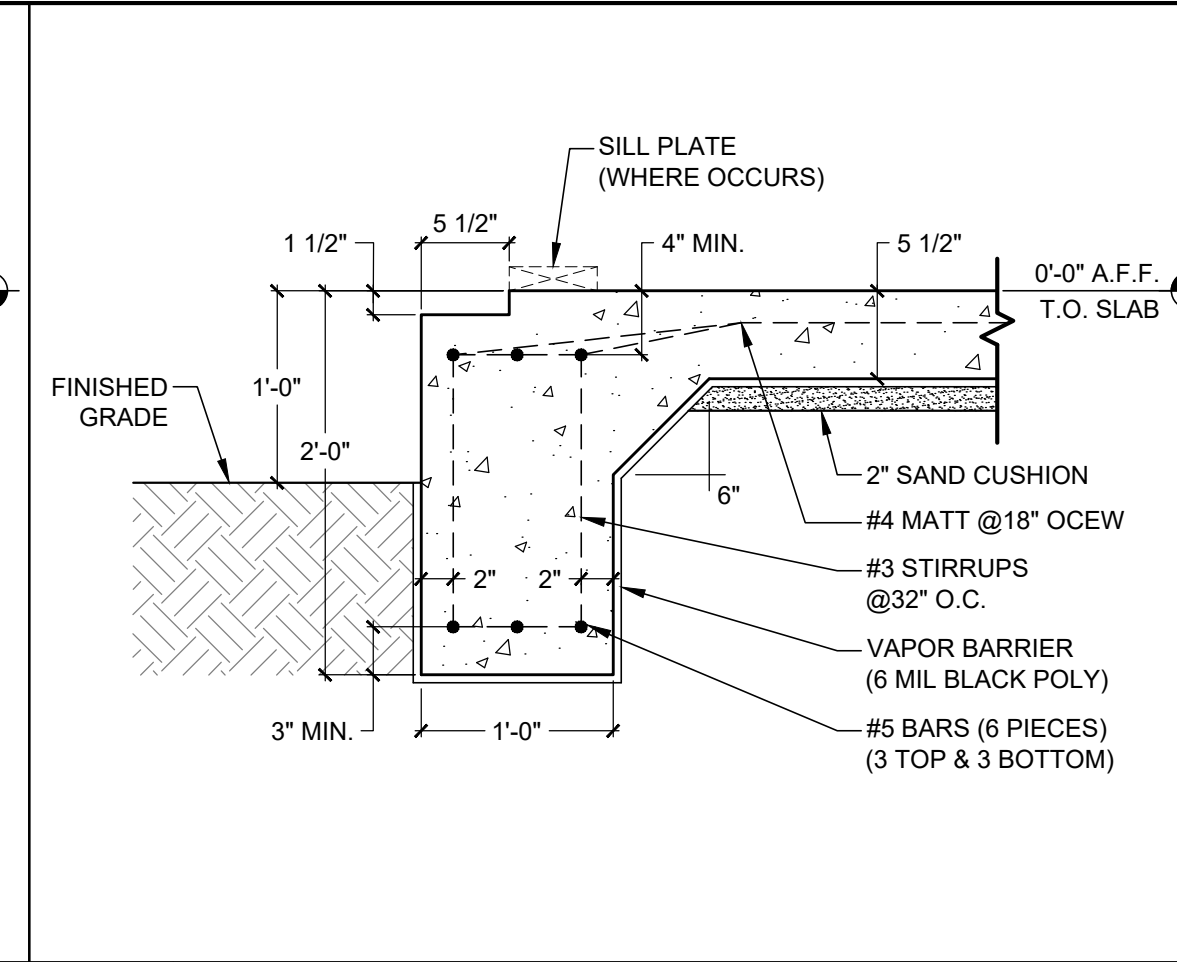
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**S3.1**




**1 TYP. EXTERIOR BEAM**

SCALE: 1" = 1'-0"

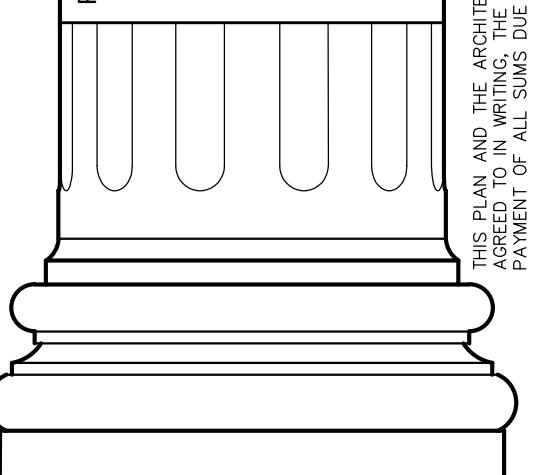


**2 EXT. BEAM W/ MASONRY LEDGE**

SCALE: 1" = 1'-0"

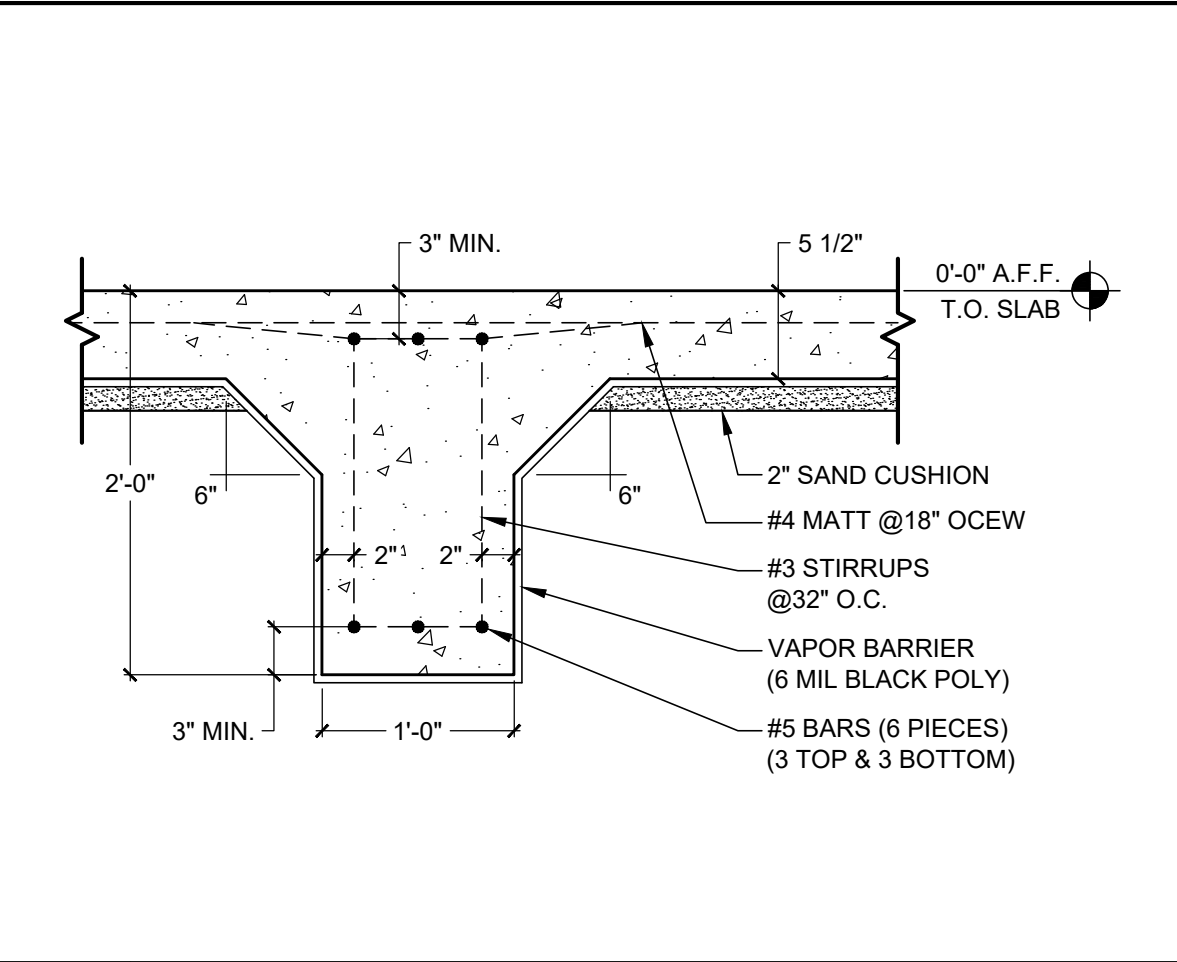


**3 TYP. INTERIOR BEAM**

SCALE: 1" = 1'-0"

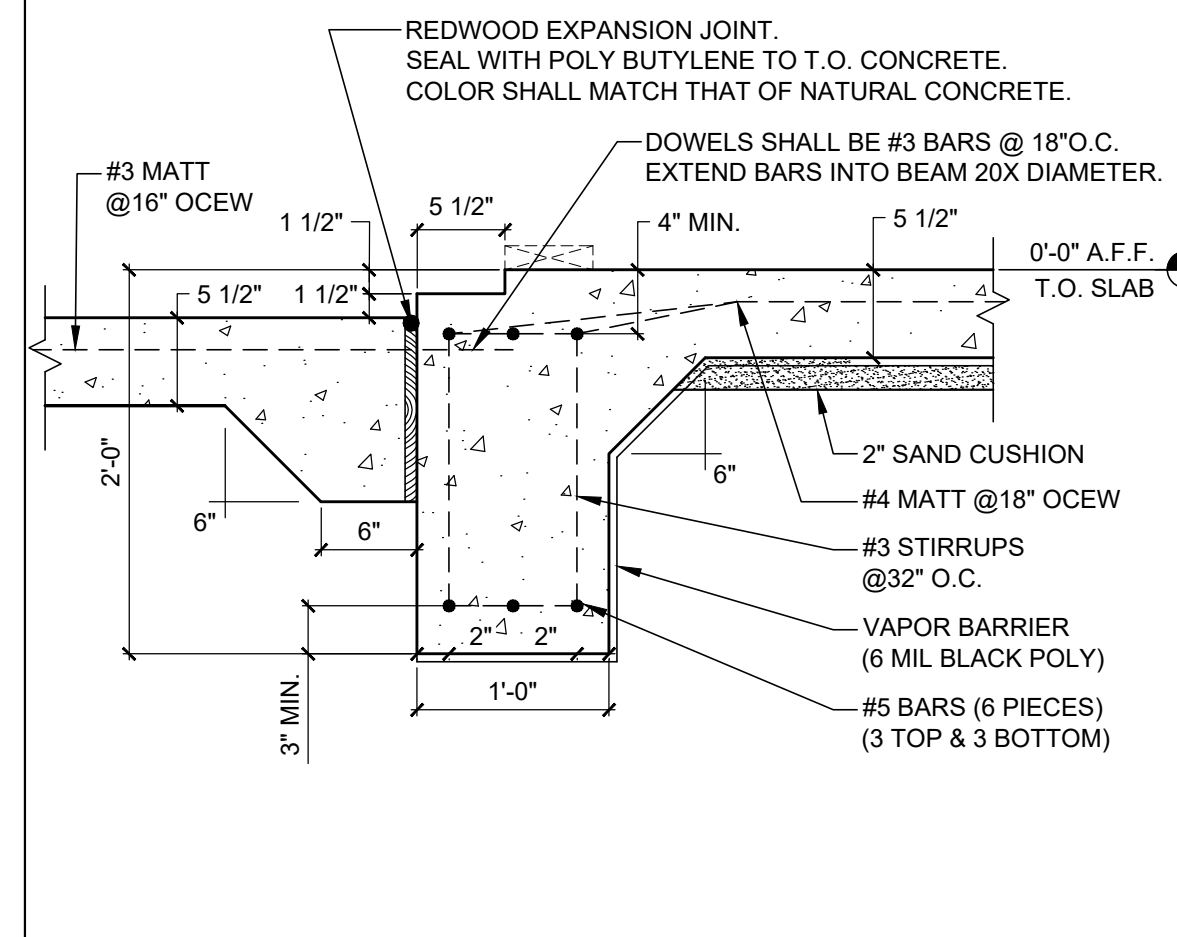


**4 EXT. BEAM W/ MASONRY LEDGE & DROP**

SCALE: 1" = 1'-0"

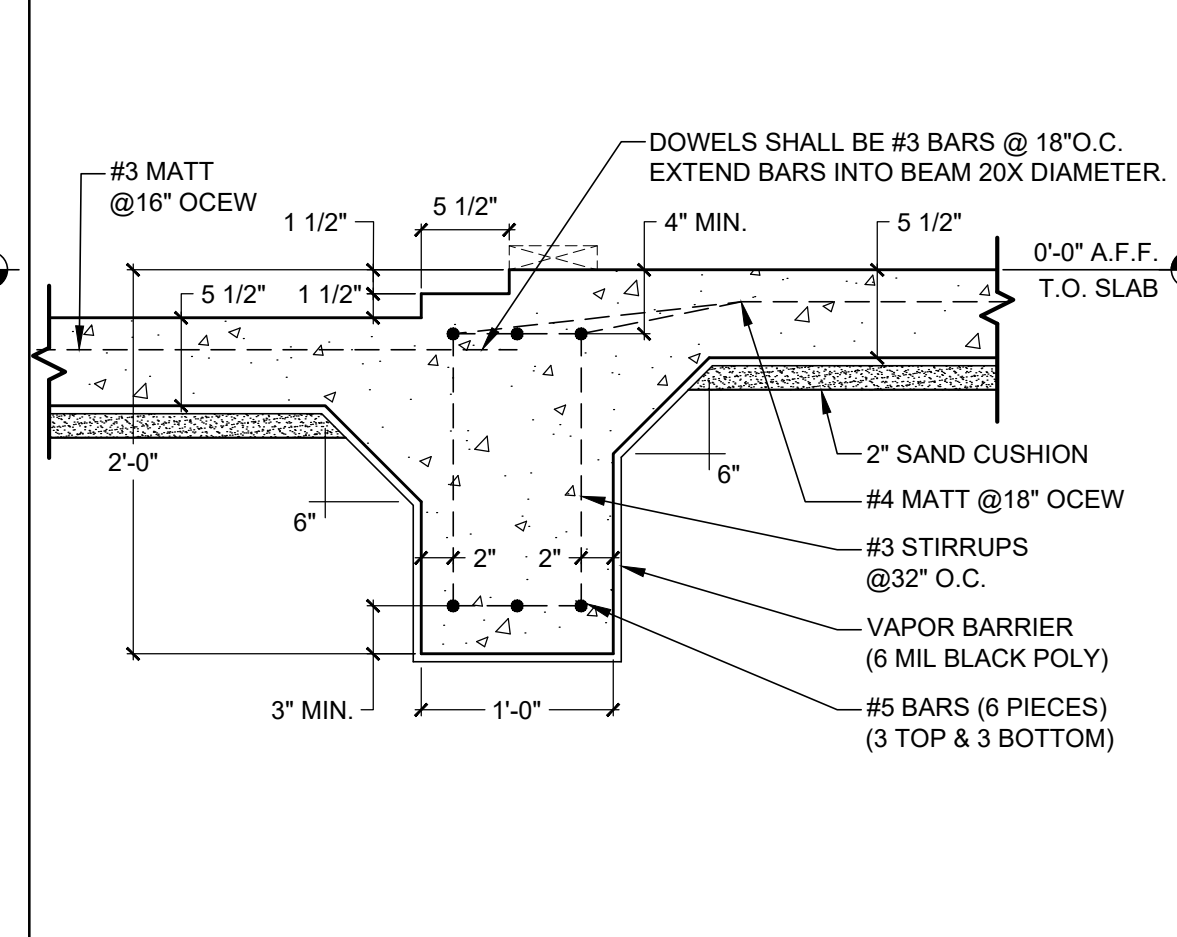


**5 INT. BEAM W/ MASONRY LEDGE & DROP**

SCALE: 1" = 1'-0"

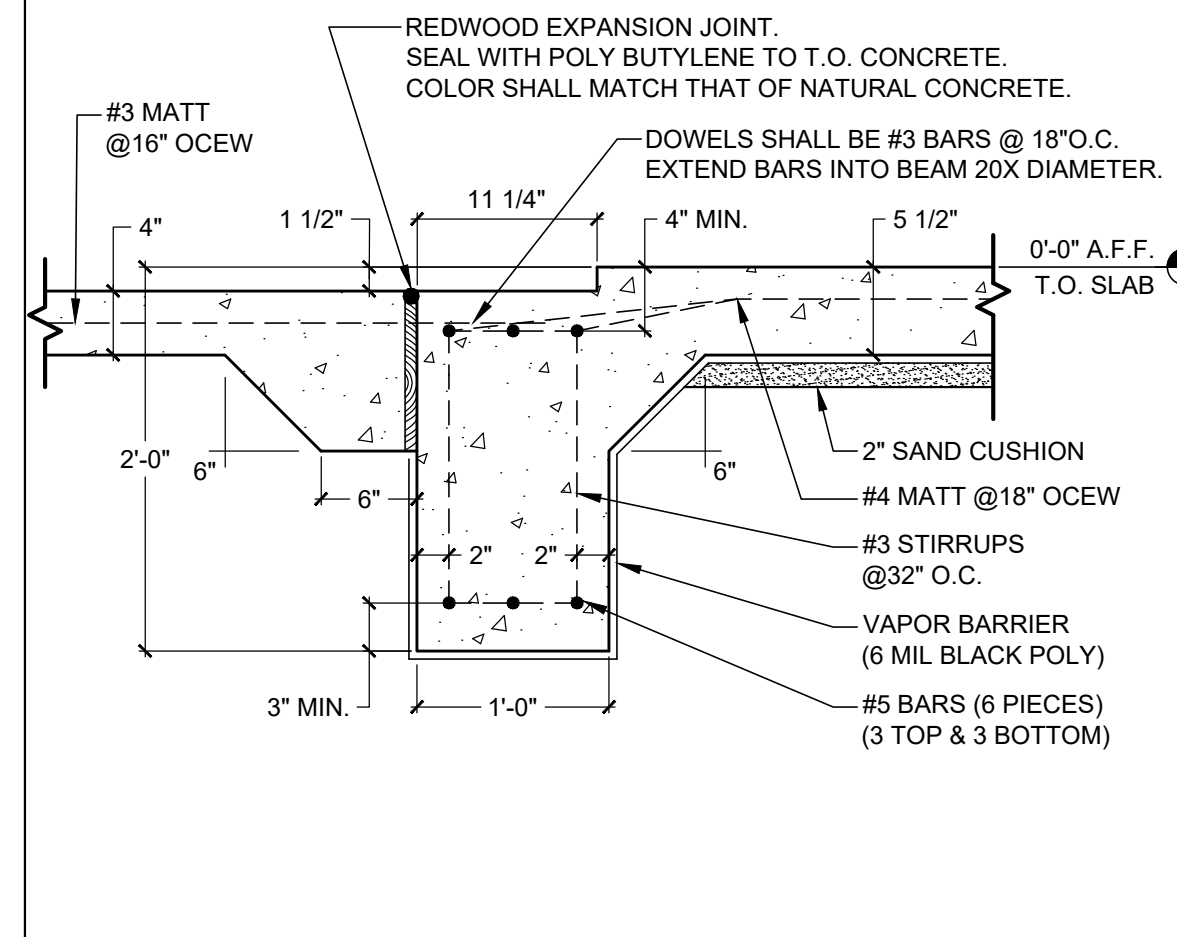


**6 EXT. BEAM AT GARAGE DOOR**

SCALE: 1" = 1'-0"

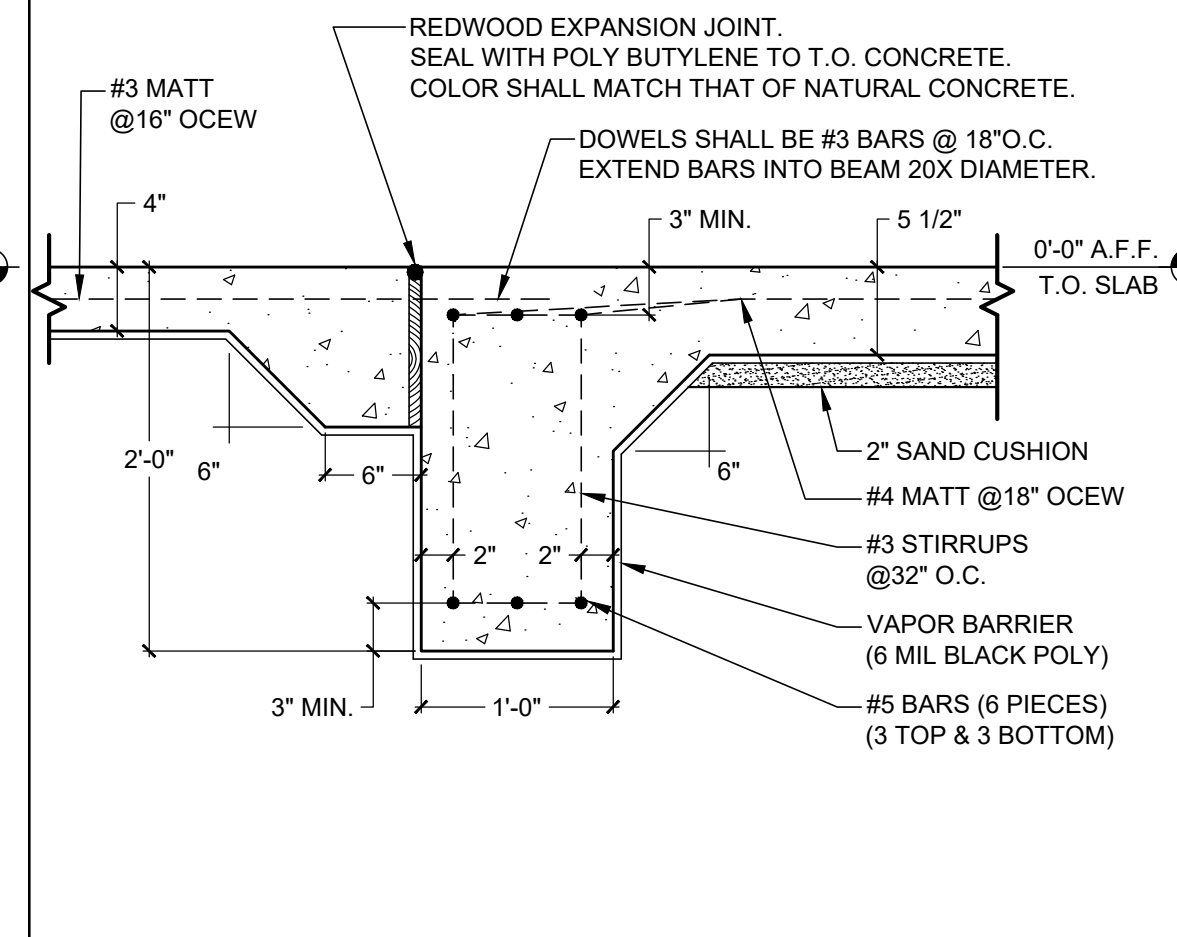


**7 EXT. BEAM AT CASITA CARPORT**

SCALE: 1" = 1'-0"

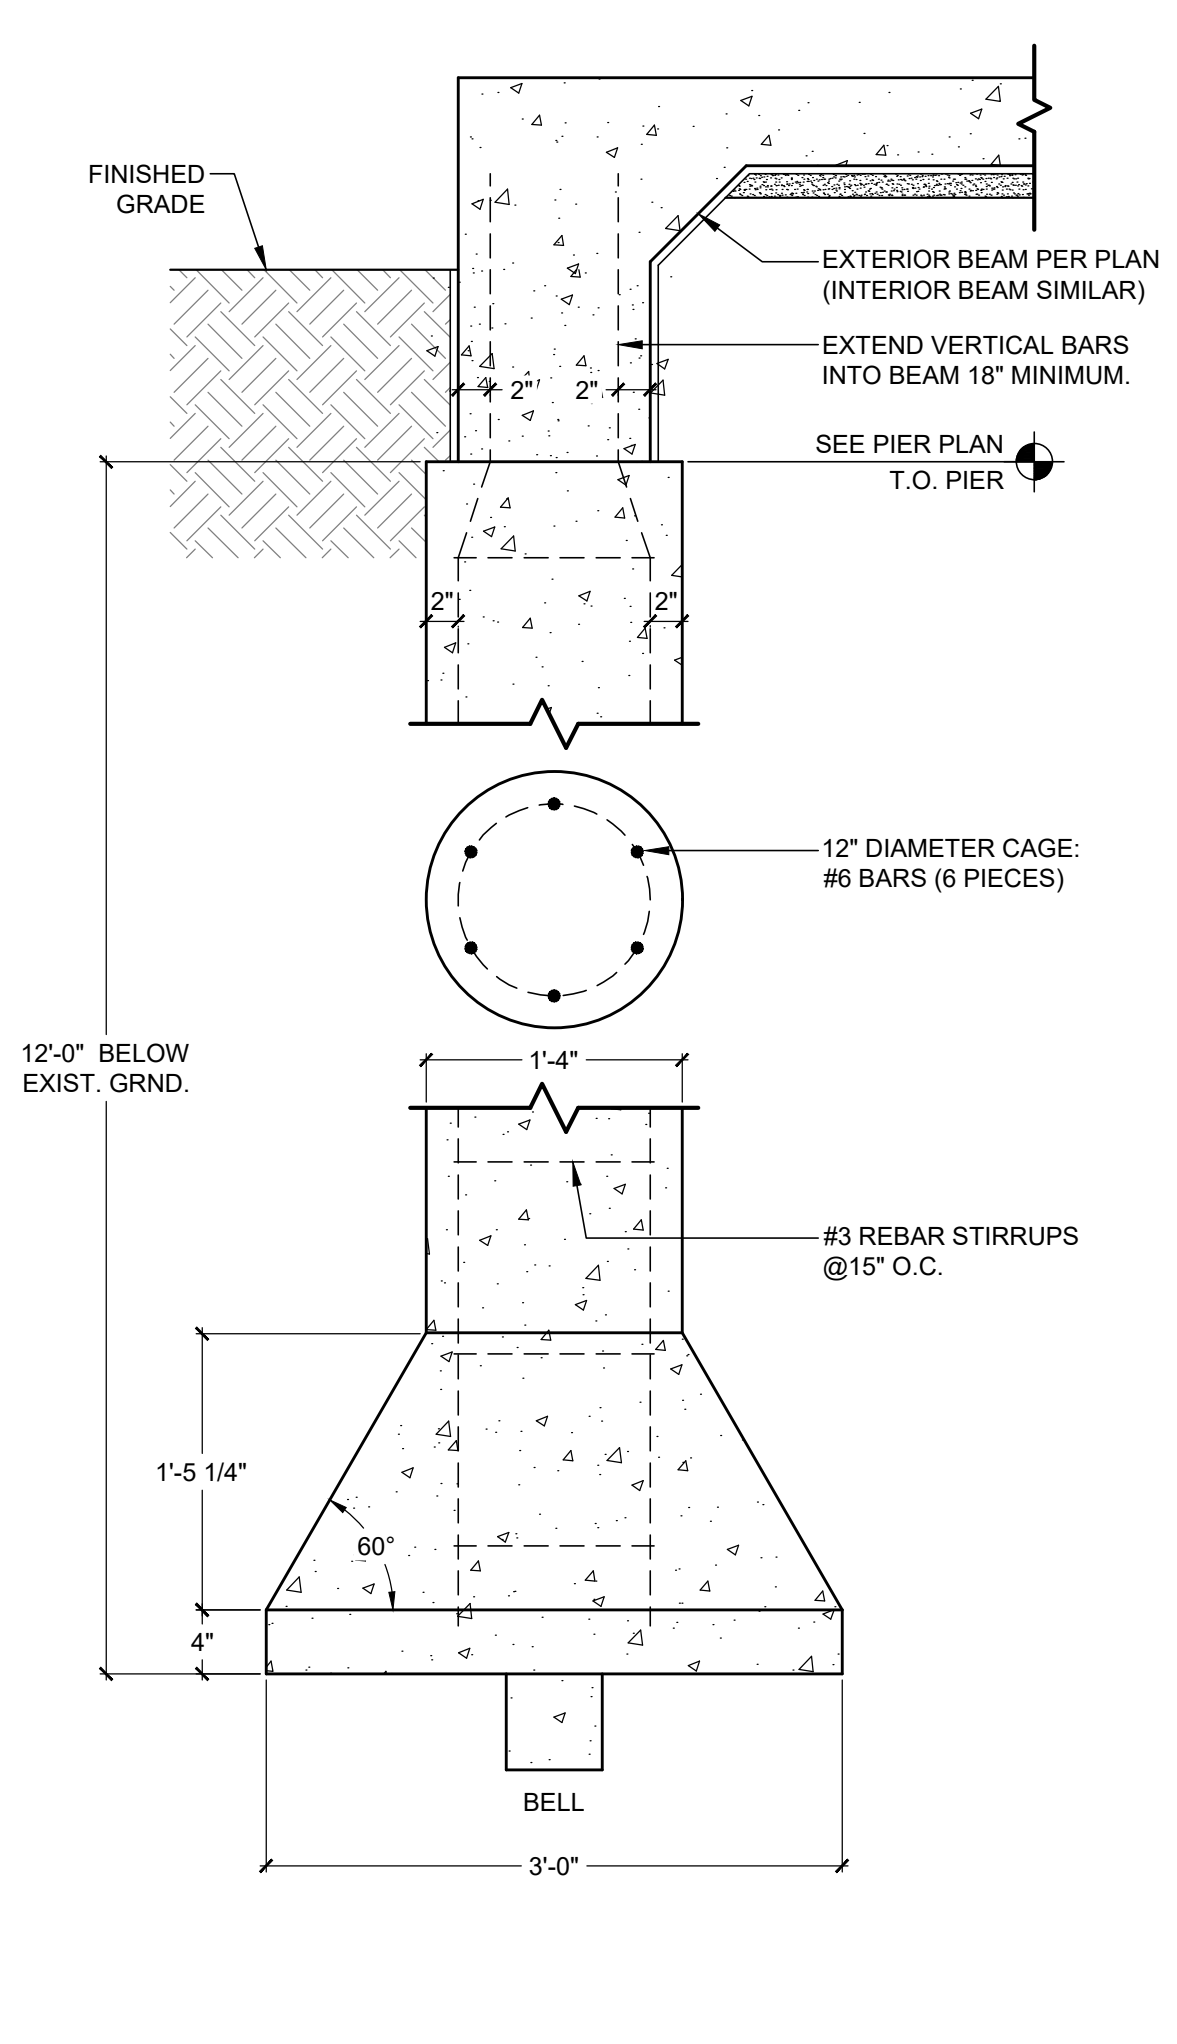

**8 TYP. FOUNDATION PIER**

SCALE: 1" = 1'-0"

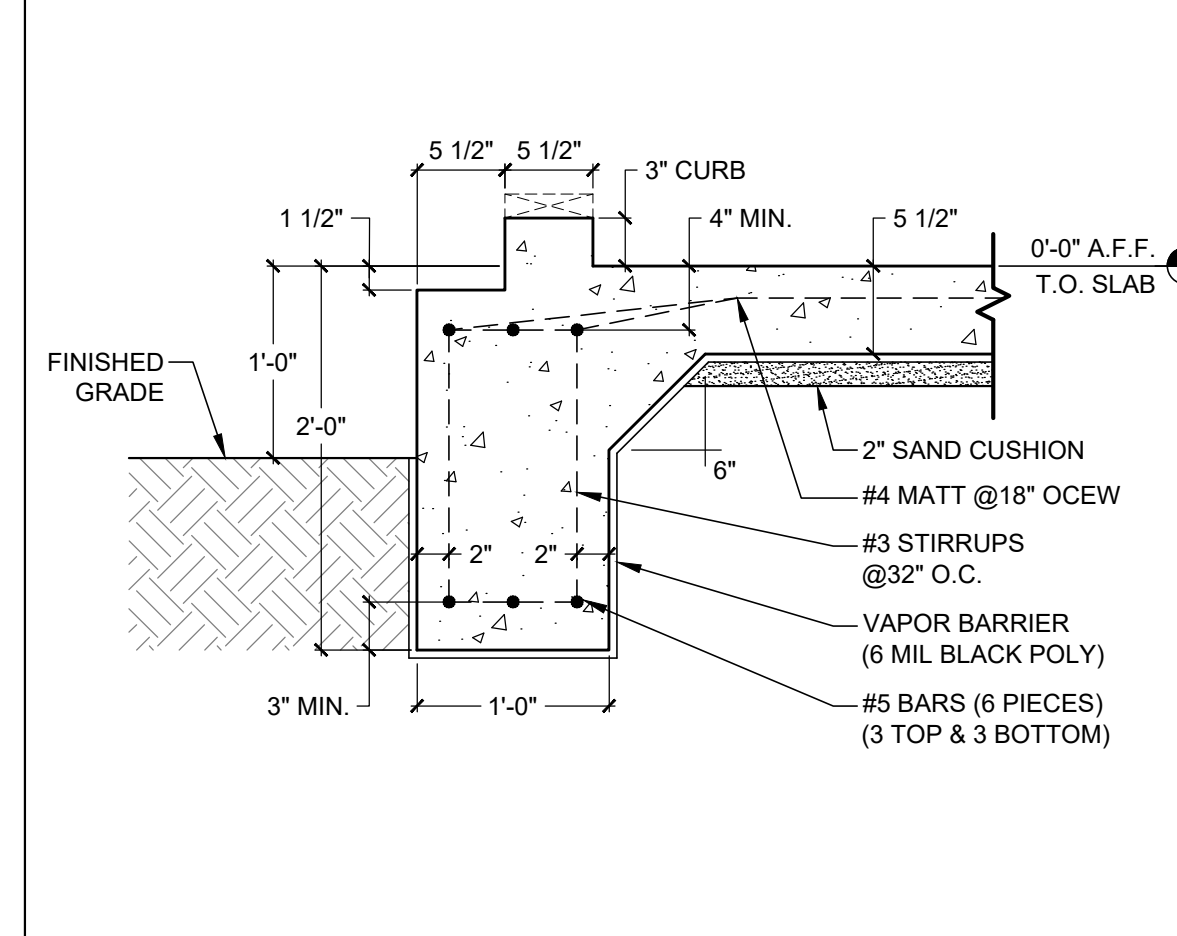

**9 EXT. BEAM W/ MASONRY LEDGE & CURB**

SCALE: 1" = 1'-0"

**DISCLAIMER:**  
 THIS FOUNDATION HAS BEEN DESIGNED FOR BID PURPOSES ONLY. MARTINEZ & ASSOCIATES ASSUMES NO RESPONSIBILITY FOR THE STRUCTURAL INTEGRITY OF ANY FOUNDATION. A GEOTECHNICAL INVESTIGATION HAS BEEN PERFORMED ON THIS PROPERTY BY THE MURILLO COMPANY OF HOUSTON, TX (REPORT #GEO37718). THIS FOUNDATION HAS BEEN DESIGNED IN ACCORDANCE WITH THE RECOMMENDATIONS CONTAINED WITHIN THE GEOTECHNICAL REPORT. THESE PLANS MUST BE APPROVED BY GEOTECHNICAL ENGINEER PRIOR TO CONSTRUCTION. MODIFICATIONS TO THIS DESIGN MAY BE REQUIRED.

**FOUNDATION NOTES:**

- DIMENSIONS SHOWN ARE FOR LAYOUT PURPOSES ONLY, BUT A TOLERANCE OF [+] OR [-] 1/2" ON ALL INTERIOR BEAMS SHALL BE ACCEPTED.
- FOUNDATION SHALL BE LOCATED ON THE LOT BY A LICENSED SURVEYOR AT THE ELEVATION INDICATED ON THE PROPOSED SITE PLAN. THE SURVEYOR SHALL BE RESPONSIBLE FOR COMPLETING THE FIELD FORM SURVEY AND FURNISHING COPIES TO ALL REQUIRED PARTIES. THE SURVEYOR SHALL ALSO PROVIDE A CERTIFICATION STATING THE STRUCTURE IS NOT WITHIN THE 500-YEAR FLOOD PLAIN.
- CONTRACTOR TO SCARIFY AND REMOVE ALL REDDISH-BROWN CLAY TOPSOILS TO EXISTING SANDY-CLAY LAYER (2'-3" DEPTH PER GEO. REPORT). REMOVE SOILS IN THE AREA OF THE BUILDING FOOTPRINT PLUS A MINIMUM OF 5'-0" BEYOND THE PERIMETER. BUILDING PAD TO BE 24" MIN. THICKNESS. PAD MATERIAL SHOULD CONSIST OF A NON-ACTIVE SANDY CLAY OR CLAYEY SANDS HAVING A P.I. BETWEEN 8% AND 25%. THE FILL SHOULD BE PLACED UNDER LABORATORY CONTROL, IN NO GREATER THAN 10" LOOSE LAYERS, AND COMPACTED TO A MIN. 95% OF STANDARD PROCTOR DENSITY. REFER TO GEOTECHNICAL REPORT FOR ADDITIONAL REQUIREMENTS.
- EXTERIOR GRADE BEAMS SHOULD EXTEND A MIN. OF 12" INTO THE REGRADED SURFACE OR COMPACTED BUILDING PAD. ALL MATERIAL EXCAVATED FROM FOUNDATION BEAMS TO BE PLACED IN ISLAND AREAS AND UNIFORMLY COMPACTED TO REMOVE VOIDS. ALLOW FOR 2" SAND PAD OVER ENTIRE PAD FOR FINAL GRADING.
- REINFORCING STEEL SHALL BE HELD IN PLACE WITH A SUFFICIENT NUMBER OF PLASTIC CHAIRS OR CONCRETE BLOCKS TO SUPPORT WORKERS DURING CONCRETE PLACEMENT. MAX. SPACING OF 48" BOTH DIRECTIONS.
- ALL REINFORCING STEEL OVERLAPS SHALL BE 30 TIMES THE BAR DIAMETER.
- ALL REINFORCING STEEL IN BEAMS SHALL RUN CONTINUOUSLY THROUGH THE BEAM INTERSECTIONS.
- EXTERIOR BEAM STEEL SHALL BE BENT CONTINUOUS AROUND CORNERS AND SHALL BE OVERLAPPED AND SPLICED AT 30 TIMES THE DIAMETER.
- INTERIOR BEAM STEEL SHALL BE CONNECTED TO EXTERIOR BEAM STEEL AND SHALL BE OVERLAPPED AND SPLICED AT 30 TIMES DIAMETER.
- ALL STEEL AT PORCH AREAS SHALL EXTEND THROUGH AND BE TIED TO EXTERIOR OR INTERIOR BEAMS.
- CONCRETE SHALL BE (5) SACK MIXTURE WITH NO MORE THAN A 6" SLUMP.
- ALL CONCRETE SHALL TEST 3000p.s.i. IN 28 DAYS.
- VIBRATE EXTERIOR BEAMS TO PREVENT HONEYCOMB EFFECT.
- SLOPES AT PORCH ENTRIES SHALL PROVIDE POSITIVE DRAINAGE AWAY FROM BUILDING WITH A MAXIMUM 2% SLOPE.
- INTERIOR SLAB SHALL HAVE A TROWEL FINISH. ALL EXTERIOR CONCRETE SURFACES SHALL HAVE A LIGHT BROOM FINISH.

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