

FOUNDATION NOTES:

- A. SEE FOUNDATION PLAN FOR LOCATIONS OF BEAMS, BELLBOTTOMS, DROPS, ETC. THE CONTRACTOR SHALL VERIFY OVERALL DIMENSIONS AND PLUMBING LOCATION PRIOR TO POURING CONCRETE.
- B. ALL FOUNDATION EXCAVATION TO BE CARRIED TO UNDISTURBED MATERIAL OR PLACED IN APPROVED ENGINEERED FILL. EXCAVATIONS SHALL BE FREE OF LOOSE MATERIAL AND WATER.
- C. OVER EVACUATION OF MATERIALS SHALL BE BACKFILLED WITH CONCRETE.
- D. ALL BACKFILL AROUND FOOTINGS, BEHIND WALLS AND UNDER SLABS SHALL BE COMPACTED.
- E. BACKFILLS AGAINST FOUNDATION WALLS WILL NOT BE PERMITTED UNTIL THE WALL HAS REACHED 28 DAY STRENGTH AND ALL SUPPORTING STRUCTURE IS IN PLACE.
- F. STEP FOOTING AT A RATIO OF ONE VERTICAL TO TWO HORIZONTAL, WITH A MAXIMUM VERTICAL STEP OF 2'-0" UNLESS NOTED OTHERWISE.
- G. WATERPROOFING OF FOUNDATIONS AND RETAINING WALLS SHALL BE THE RESPONSIBILITY OF THE OWNER OR CONTRACTOR AND IS NOT THE RESPONSIBILITY OF THE ENGINEER.
- H. ANY UNUSAL SITE CONDITIONS (e.g. LOOSE FILL, SUBSURFACE WATER, ETC.) SHALL BE REPORTED TO THE ENGINEER.


- I. ALL PIPES THROUGH EXTERIOR GRADE BEAMS SHALL BE SLEEVED. ALL PIPES SHALL BE LOCATED AT MID-DEPTH OF GRADE BEAMS. SIZE OF SLEEVES SHALL NOT EXCEED 1/3 OVERALL DEPTH OF GRADE BEAM. SPACING OF SLEEVES SHALL NOT BE CLOSER THAN 5 DIAMETERS ON THE CENTER.

3. REINFORCING STEEL:

- A. ALL REINFORCING STEEL SHALL CONFORM TO ASTM A615 GRADE 60 UNLESS OTHERWISE INDICATED, EXCEPT #3 OR SMALLER MAY BE ASTM A615 GRADE 40.
- B. WELDED WIRE FABRIC SHALL CONFORM TO ASTM A185.
- C. ALL REINFORCING STEEL SHALL BE ACCURATELY LOCATED AND ADEQUATELY SECURED IN POSITION BEFORE AND DURING PLACEMENT OF CONCRETE.
- D. ALL DETAILS OF FABRICATION AND INSTALLATION OF REINFORCING STEEL SHALL BE IN ACCORDANCE WITH THE ACI MANUAL OF STANDARD PRACTICE.
- E. LAP REINFORCING BAR SPLICES 40 BAR DIAMETERS, UNLESS OTHERWISE NOTED. (SPLICE REINFORCING STEEL 36" WHEN ALL BARS ARE SPLICED AT ANY ONE POINT).
- F. BEND ALL HORIZONTAL BEAM AND WALL BARS 40 BAR DIAMETERS AROUND ALL CORNERS, OR 40 BAR DIAMETERS, SPLICE CORNER BARS, UNLESS OTHERWISE NOTED.
- G. PROVIDE VERTICAL AND HORIZONTAL REINFORCING BARS IN CONCRETE AND MASONRY WALLS TO CONFORM TO THE MINIMUM PROVISIONS OF ACI 318, SECTION 14.3, UNLESS OTHERWISE NOTED.
- H. PROVIDE THE FOLLOWING MINIMUM CONCRETE COVER OVER REINFORCING STEEL:

2. REINFORCING CONCRETE:

- A. REINFORCING CONCRETE SHALL CONFORM TO APPLICABLE REQUIREMENTS OF THE IRC-2015 AND A.C.I. STANDARD 318.
- B. ALL CONCRETE USED IN FOUNDATIONS AND SLABS ON GRADE SHALL HAVE A 28 DAY COMPRESSIVE STRENGTH OF NOT LESS THAN 3000 psi.
- C. THE MAXIMUM SLUMP SHALL NOT EXCEED 5 INCHES.
- D. PROVIDE # 3's @ 16" ON CENTER BOTH WAY IN ALL SLABS ON GRADE, PLACED 1 1/2" DOWN FROM TOP OF SLAB, UNLESS OTHERWISE NOTED.
- E. PROVIDE WELDED WIRE FABRIC IN FLAT SHEETS, NOT IN ROLLS.
- F. PROVIDE CONTROL JOINTS IN ALL EXPOSED SLABS ON GRADE. THE MAXIMUM SPACING OF CONTROL JOINTS SHALL BE 20'-0" O.C., UNLESS OTHERWISE NOTED.
- G. POUR SLAB IN STRIP POURS, NOT IN CHECKERBOARD PATTERN.
- H. PROVIDE VERTICAL CONTROL JOINTS IN ALL CONCRETE WALLS. THE MAXIMUM SPACING OF CONTROL JOINTS SHALL BE 20'-0", UNLESS OTHERWISE NOTED. CUT ALTERNATE HORIZONTAL REINFORCING BARS, EACH FACE.
- I. ADDITIVES CONTAINING CALCIUM CHLORIDE SHALL NOT BE USED.

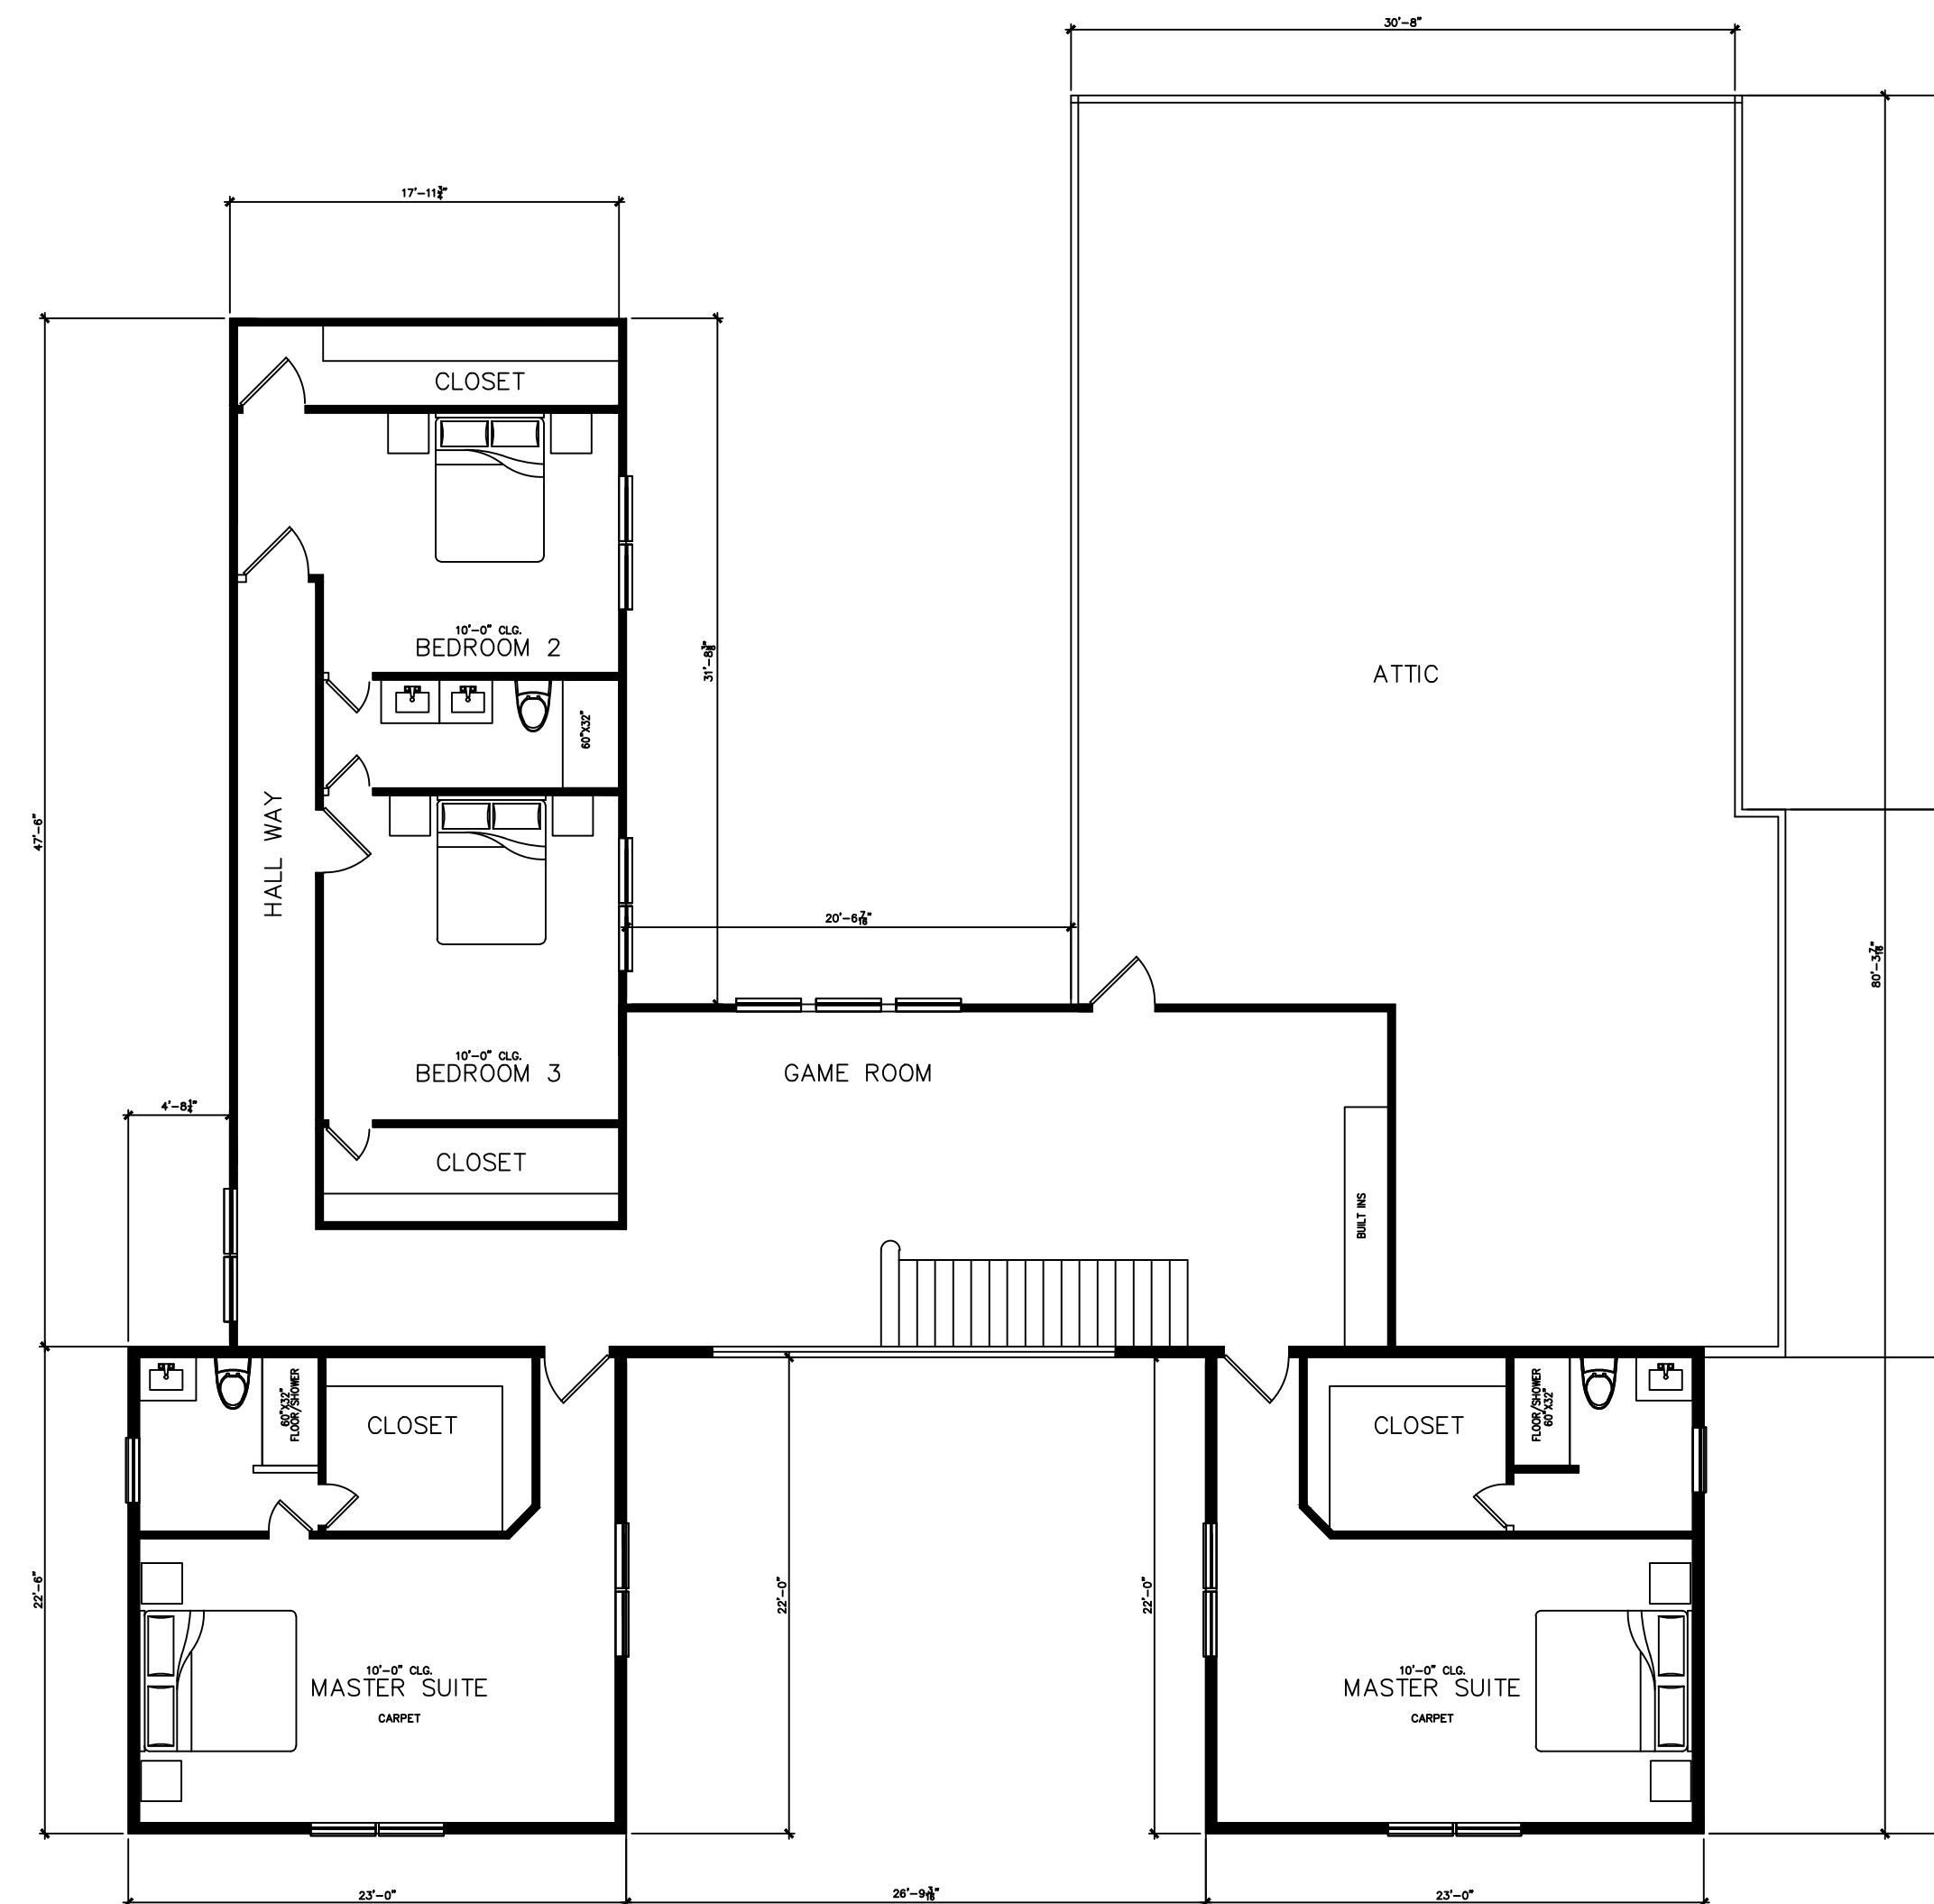

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DRAWN BY

06/26/2022

1/8"=1'-0"

A-2.0