## General Notes:

- . All work to be done as per 2015 I.R.C.
- Water resist gyp. board (full hgt.), @ shower, tub, and walls subject to water splash.
- 3. Tub and shower, if not fiber glass, shall be finished with a nonabsorbent tile to 70" above drain surface.
- 4. Glazing in shower, tub enclosure, & door, shall be impact resistant (tempered).
- 5. Provide access panels @ plumbing walls, especially tub walls.
- 6. For installation of AHU see contractor.
- 7. All exhaust fans must be vented to the outside.
- 8. Provide G.F.I. where shown as per National Electrical Code.
- 9. Gas installations and appliances are to be consistent with
- applicable codes and manufacturer's specifications.

  10. Hot water heater to be installed in mechanical room upstairs,
- and is to include metal pan with drain to the outside.
- 11. Fire box is to be installed as per 2015 I.R.C. Standard, and manufacturer's specifications are to be posted @ job site.
- 12. All exterior finishes shall be water resistant.
- 13. All french doors shall have safety (tempered) glass.
- 14. At all guardrails and balustrade, can not have any passage at any point for a 4" sphere or larger.

#### Notes:

- 1. Handrails & Guardrails (Design Loads) Table R301.5 and Footnoted 2015 IRC Handrails and guards shall be designed for a minimum 200 lb live load and a single concentrated load applied in any direction at any point along the top.
- 2. All smoke/ carbon monoxide detectors shall be hard-wired and inter-connected with battery backup.
- 3. The attic rough opening shall be 30"x54" and the stair load capacity shall be a minimum of 350 pounds.
- 4. Provide an unobstructed passageway not more than 20ft in length when measured along the certerline of passage way from the opening to the appliance with a minimum headroom height of 30" and a minimum width of 30".
- 5. A level surface space at least 30" deep and 30" wide shall be present along all side of the appliance where access is required.

AREA CALCULA	TION	
LIVING AREA		
1ST FLOOR	3211	
TOTAL LIVING AREA	3211	
ACCESSORIES AREA		
FRONT PORCH	92	
COVERED BACK PATIO	194	
THREE CAR TANDEM GARAGE	622	
TOTAL ACCESSORIES	908	
TOTAL AREA	4119	

## Egress Requirements 2015 IRC

R310.1 IRC 2015 Emergency Escape & Rescue Required
Basements w/habtable space and every sleeping room shall
have at least one openable emergency escape and rescue
window or exterior door opening for emergency escape and
rescue window or exterior door opening for emergency escape
and rescue. Where openings are provided as a means of
escape and rescue, they shall have a sill height of not more
than 44 inches (1118) above the floor.

R310.1.1 IRC 2015 Minimum Opening Area
All emergency escape and rescue openings shall heve a
minimum net clear opening of 5.7 sq. ft. (0.530m2)

R310.1.2 IRC 2015 Minimum Opening Height

The minimum net clear opening height shall be 24 inches
(610 mm)

R310.1.3 IRC 2015 Minimum Opening Width

The minimum net clear opening width sall be 20 inches
(508mm)


R310.1.4 IRC 2015 Operational Constraints

Emergency escape and rescue openings shall be operational from the inside of the room without the use of keys or tools

Operable window sill height - a minimum of 25" off of finish floor height at second floor and above

#### IMPORTANT NOTE:

TO THE BEST OF MY KNOWLEDGE, THESE PLANS ARE DRAWN TO COMPLY WITH OWNER'S SPECIFICATIONS. CONTRACTOR AND/ OR OWNERS SHALL BE VERIFY ALL DIMENSIONS, DETAILS AND SPECIFICATIONS WITH ARCHITECTURAL DRAWINGS BEFORE CONSTRUCTION. DESIGNER WILL NOT BE LIABLE FOR HUMAN ERROR AFTER CONSTRUCTION IS STARTED.

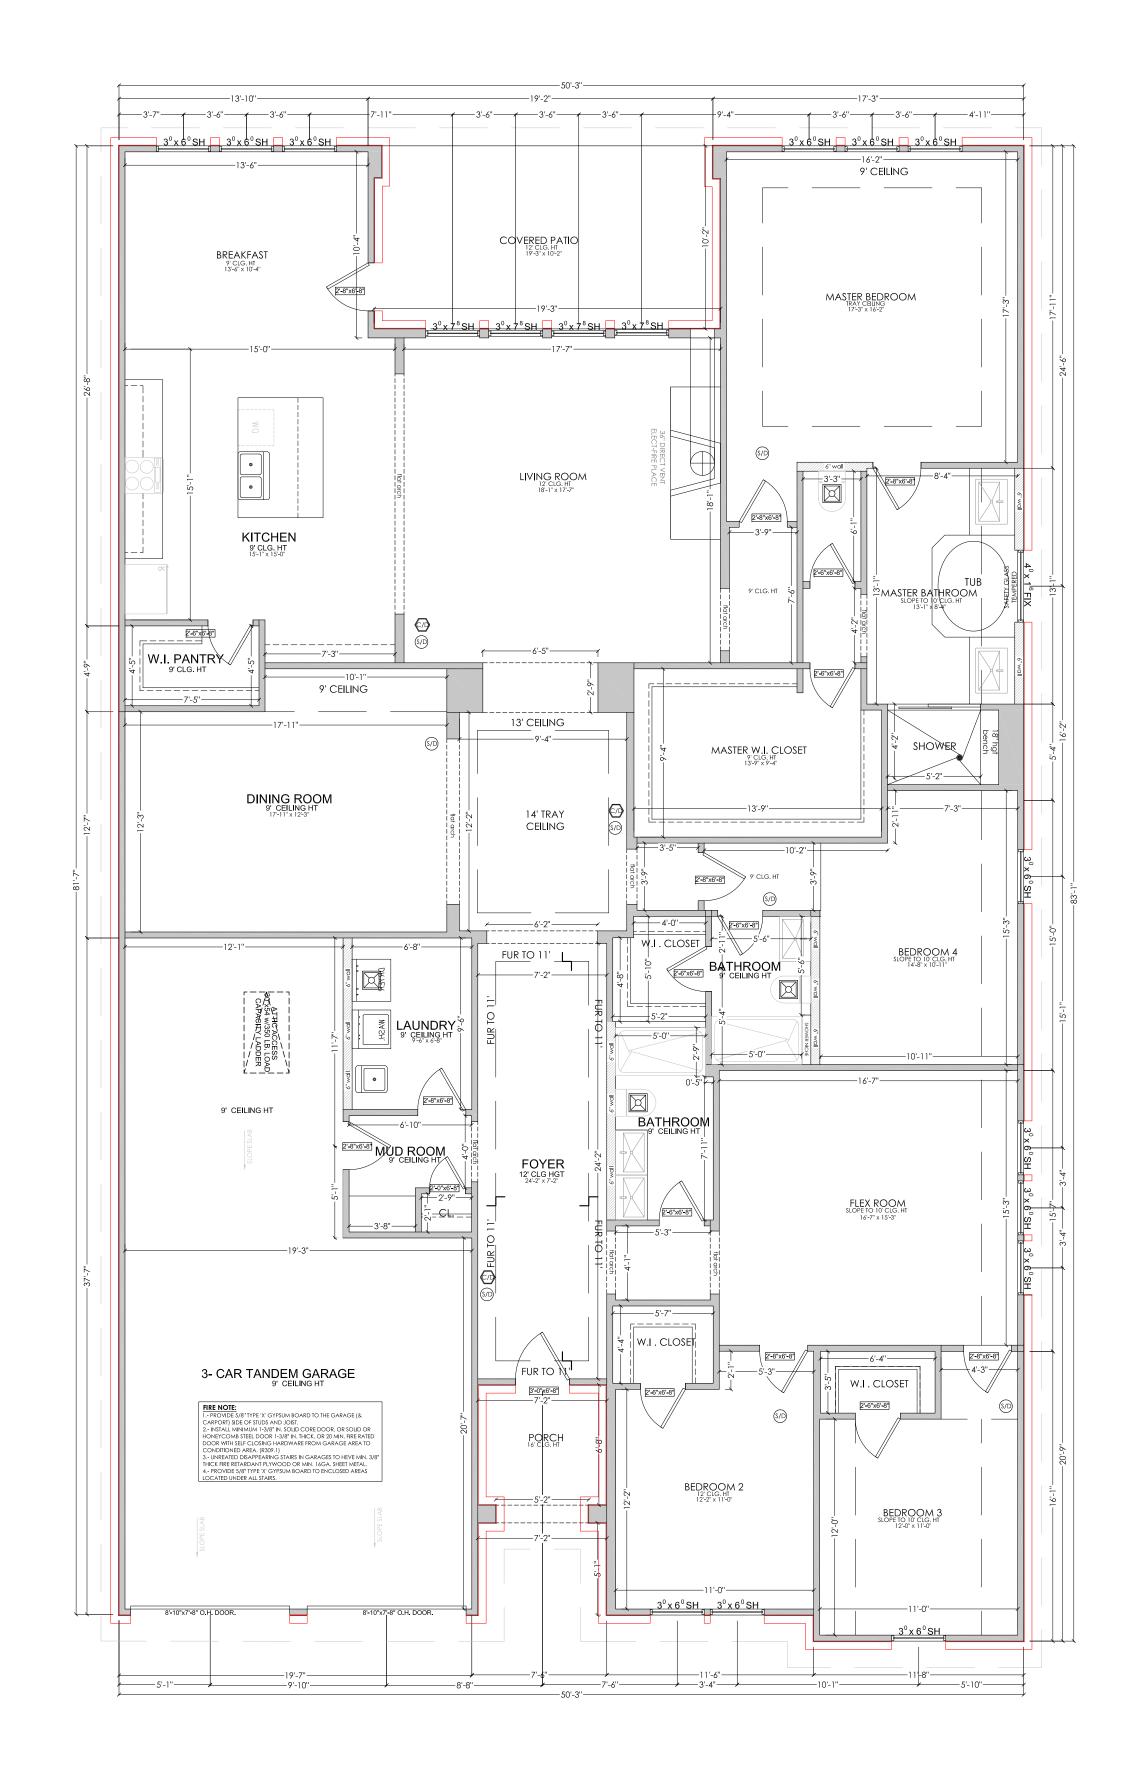

# FLOOR PLAN

SCALE: 3/16" = 1'-0"

Associates P.L.L.C    Complete Name	No.  1 2 3 4 5 6 Designd b Drawn by:	Alejandro i	<sup>2</sup> ineda
JL Trevino & Associates P.L.L.C  This is an originate of the scale of			515 Manor Av Arcola Tx 77583
This is an original design by JL TREVINO & ASSOCIATES and is solely owned by and for the exclusive use of and by JL TREVINO & ASSOC All rights are reserved.  All rights are reserved.  any infringement of this copyright is prohibited by law  (281) 433	Project Name:		
by JL TREVINO & ASSOCIATES and is solely owned by and for the exclusive use of and by JL TREVINO & ASSOC All rights are reserved. any infringement of this copyright is prohibited by law			 5450 Northwest Central 123 Houston, Texas 77092 (281) 433-8688
	©	by JL TRE and is sol and for th of and by All rights any infrince	VINO & ASSOCIATES ely owned by ne exclusive use JL TREVINO & ASSOC. are reserved. gement of this
	Seal:	copyright <sup>5</sup>	s prohibited by law
N40 0000	Job No.	ne:	
Plot Date: May 12, 2023  Job No.  Sheet Name:  FLOOR PLAN	Scale: Sheet Nun	_	<b>\-2</b>