GENERAL NOTES

A. GENERAL NOTES:

- THE GENERAL CONTRACTOR AND ALL SUBCONTRACTORS SHALL CAREFULLY AND THOROUGHLY EXAMINE THE PROJECT SITE, FIELD VERIFY ALL CONDITIONS, GRADES, ELEVATIONS AND DIMENSIONS OF THE VARIOUS FEATURES OF THE EXISTING SITE CONDITIONS, ANY DISCREPANCIES AND/OR CONDITIONS NEEDING CLARIFICATION SHALL BE REPORTED IMMEDIATELY TO THE ARCHITECT, IN WRITING,
- THE GENERAL CONTRACTOR AND ALL SUBCONTRACTORS SHALL REVIEW AND THOROUGHLY EXAMINE AND FAMILIARIZE THEMSELVES WITH ALL ELEMENTS AND CONDITIONS IN THE CONTRACT DRAWINGS AND SPECIFICATIONS. THE GENERAL CONTRACTOR AND ALL SUB-CONTRACTORS SHALL VERIFY ALL DIMENSIONS ON THE DRAWINGS. ANY DISCREPANCIES AND/OR CONDITIONS NEEDING CLARIFICATION SHALL BE REPORTED IMMEDIATELY TO THE ARCHITECT, IN WRITING, BEFORE WORK BEGINS.
- THE GENERAL CONTRACTOR AND ALL SUBCONTRACTORS SHALL BE RESPONSIBLE FOR THE ENFORCEMENT OF ALL REQUIREMENTS AND REGULATIONS AND SHALL PERFORM ALL WORK ON THIS PROJECT IN COMPLIANCE WITH O.S.H.A., AND ALL LOCAL, STATE, AND FEDERAL SAFETY AND HEALTH STANDARDS, LAWS, AND REGULATIONS. ALL CONSTRUCTION FABRICATION AND INSTALLATIONS SHALL CONFORM TO THE LATEST ADOPTED EDITIONS OF THE U.B.C., U.P.C., N.E.C., AND ANY OTHER FEDERAL, STATE AND LOCAL CODES. REGULATIONS AND ORDINANCES OF THE GOVERNING AGENCY HAVING JURISDICTION OVER THE PROJECT.
- DUE TO THE REPROGRAPHIC PROCESS. THESE PLANS MAY NOT BE ACCURATELY TO SCALE, ALL DIMENSIONS SHALL TAKE PRECEDENCE OVER SCALE SHOWN AND IN NO CASE SHALL WORKING DIMENSIONS BE SCALED FROM THE PLANS, SECTIONS, ELEVATIONS, OR DETAILS.
- WHERE CONSTRUCTION DETAILS ARE NOT SHOWN OR NOTED FOR ANY PART OF THE WORK, DETAILS SHALL BE THE SAME AS FOR OTHER SIMILAR FIRST CLASS WORK FOR THE TRADE INVOLVED. THE ARCHITECT SHALL BE NOTIFIED IMMEDIATELY, IN WRITING, FOR ANY ALTERNATE NONSTANDARD, OR UNTESTED METHOD(S) PROPOSED.
- IT IS CONSIDERED ESSENTIAL THAT THE CONTRACTOR INSPECT THE PREMISES DURING THE COURSE OF BIDDING PRIOR TO THE START OF CONSTRUCTION TO BE FAMILIAR WITH FIELD CONDITIONS. SUCH CONDITIONS SHOULD BE REFLECTED AND QUALIFIED IN THE FINAL BID. ANY CONDITION OR CIRCUMSTANCE WHICH DOES NOT CONFORM TO THE INTENT INDICATED IN THESE DRAWINGS SHALL BE BROUGHT TO THE ATTENTION OF THE ARCHITECT PRIOR TO THE ACCEPTANCE OF THE BID FOR THIS WORK. NO ADDITIONAL PAYMENTS WILL BE MADE TO COMPENSATE FOR ANY ADDITIONAL WORK REQUIRED FOR A PROFESSIONAL COMPLETION OF THE WORK, DUE TO LACK OF FIELD VERIFICATION BY CONTRACTOR.
- SHOULD THERE BE ANY DISCREPANCY BETWEEN THE VARIOUS DRAWINGS, IT SHALL BE BROUGHT TO THE ARCHITECTS ATTENTION FOR CLARIFICATION. THE CONTRACTOR SHALL COORDINATE WITH OWNER'SHIP FOR INSTALLATION OF ANY SPECIAL EQUIPMENT NOT
- THE CONTRACTOR SHALL VERIFY EQUIPMENT LOCATIONS WITH OWNER'SHIP AND/OR EQUIPMENT MANUFACTURER FOR PROPER SIZE AND LOCATION OF FOUNDATION OR SLAB DEPRESSIONS, DRAINS, AND WARPS.
- THE CONTRACTOR SHALL TAKE ALL NECESSARY PRECAUTIONS TO LOCATE AND PROTECT ANY UNDERGROUND OR CONCEALED CONDUIT, PLUMBING, OR OTHER UTILITIES WHERE NEW WORK IS BEING PERFORMED.
- 10. NOTES AND DETAILS ON THE DRAWINGS SHALL TAKE PRECEDENCE OVER THESE STANDARD NOTES ON THIS SHEET IN CASE OF
- 11. THE CONTRACTOR SHALL COMPLY WITH SAFETY RESTRICTIONS AS REQUIRED FOR WORKERS AND PEDESTRIAN PROTECTION DURING
- 12. RUBBISH AND DEBRIS RESULTING FROM THE WORK OF VARIOUS TRADES SHALL BE REGULARLY COLLECTED AND REMOVED FROM THE PROJECT SITE AND LEGALLY DISPOSED OF PRIOR TO DELIVERY OF MATERIALS TO THE CONSTRUCTION ZONE AND REMOVAL OF WASTE FROM THE SITE. THE CONTRACTOR SHALL CHECK WITH THE OWNER FOR AN ACCEPTABLE ACCESS ROUTE AND TIME. UNDER NO CIRCUMSTANCES SHALL THE CONTRACTOR, HIS SUBCONTRACTORS, OR ANY OF THEIR EMPLOYEES USE ANY AREA OUTSIDE THE CONSTRUCTION ZONE WITHOUT PRIOR APPROVAL FROM THE OWNER.
- 13. ANY REVISION OR ADDITIONAL WORK REQUIRED BY FIELD CONDITIONS OR LOCAL GOVERNING AUTHORITIES SHALL BE BROUGHT TO THE ATTENTION OF THE ARCHITECT BEFORE PROCEEDING, REGARDLESS OF COST, TIME OR MATERIAL INCREASE.
- 14. ANY AND ALL REVISIONS TO THE SCOPE SHALL BE BY WRITTEN CHANGE ORDER, APPROVED BY OWNER
- 15. PROVIDE PROTECTION AS REQUIRED TO PREVENT ANY DAMAGE TO EXISTING AND NEW MATERIALS AND CONSTRUCTION PREVIOUS TO AND DURING CONSTRUCTION AND AFTER INSTALLATION. ALSO EXISTING CONSTRUCTION WITHIN AND ADJACENT TO JOB SITE. WHERE DAMAGE OCCURS, REPAIR OR REPLACE AS REQUIRED TO THE OWNER'S APPROVAL AT NO ADDITIONAL COST.
- WELDING SHALL BE BY A CERTIFIED WELDER OR IN THE SHOP OF AN APPROVED FABRICATOR

ORDINANCES, AND REGULATIONS, THE MOST STRINGENT SHALL GOVERN.

- 17. THE CONTRACTOR SHALL PROVIDE ALL NECESSARY BLOCKING, BACKING, FRAMING, HANGERS OR OTHER SUPPORT FOR ALL FIXTURES, EQUIPMENT AND ALL OTHER ITEMS AS NECESSARY WHETHER OR NOT DETAILS HAVE BEEN PROVIDED.
- 18. GENERAL CONTRACTOR SHALL NOT MAKE ANY SUBSTITUTION OF MATERIALS OR EQUIPMENT WITHOUT THE WRITTEN CONSENT OF THE
- 19. BEFORE ACCEPTANCE BY THE OWNER, THE COMPLETED CONSTRUCTION SHALL BE CLEANED, LABELS REMOVED, AND ALL OTHER TOUCHUP COMPLETED TO THE SATISFACTION OF THE OWNER.
- ALL CONSTRUCTION SHALL BE IN ACCORDANCE WITH THE CODES LISTED UNDER THIS GENERAL NOTES HEADING ON THIS SHEET. SHALL BE THE CONTRACTOR'S RESPONSIBILITY TO BE FAMILIAR WITH ALL CODES AND ORDINANCES, CITY OR STATE, AS REQUIRED FOR THE CONSTRUCTION OF THIS PROJECT. WHERE ANY CONFLICTS OCCUR BETWEEN FEDERAL, STATE AND LOCAL LAWS, CODES,
- THE CONTRACTOR SHALL PROVIDE ADEQUATE AND SAFE BRACES AND CONNECTIONS TO SUPPORT THE COMPONENT PARTS OF THE STRUCTURE, UNTIL THE STRUCTURE ITSELF (INCLUDING ROOF DIAPHRAGM) IS COMPLETE ENOUGH TO SUPPORT ITSELF. THE DESIGN ADEQUACY, SAFETY, AND ERECTION OF BRACING, SHORING, SCAFFOLDING, AND TEMPORARY SUPPORTS AND RESTRAINTS IS THE SOLE RESPONSIBILITY OF THE CONTRACTOR.
- 22. IT IS THE INTENT OF THESE DRAWINGS TO INDICATE A COMPLETE AND FINISHED PRODUCT MATCHING AND/OR ABUTTING EXISTING CONSTRUCTION IN A NEAT AND PROFESSIONAL MANNER.
- 23. THE FACILITY IS TO REMAIN OCCUPIED DURING THE CONSTRUCTION. THE CONTRACTOR SHALL COORDINATE AND SCHEDULE WITH THE
- 24. THE CONTRACTOR SHALL PROVIDE WRITTEN REQUESTS FOR SHUTDOWNS AT LEAST THREE DAYS PRIOR TO THE EVENT. WORK REQUIRING SHUTDOWNS WILL BE REQUIRED TO BE PERFORMED OUTSIDE NORMAL WORKING HOURS.
- 25. STORAGE OF ALL MATERIALS, EQUIPMENT AND SUPPLIES SHALL BE LIMITED TO SCHEDULED AREAS OF WORK IN PROGRESS, OR TO DESIGNATED LOCATIONS APPROVED AND ARRANGED WITH THE OWNER. THE CONTRACTOR SHALL THOROUGHLY CAULK, FLASH AND/OR SEAL AROUND ALL WALL AND/OR ROOF PENETRATIONS THAT ARE MADE AS A PART OF THE CONTRACT WORK TO CREATE A WATERTIGHT CONDITION.
- 26. WHEN INSTALLING DRILLED IN ANCHORS OR POWER DRIVEN PINS INTO EXISTING REINFORCED CONCRETE OR REINFORCED CONCRETE MASONRY, CARE SHALL BE TAKEN TO AVOID CUTTING OR DAMAGING THE REINFORCING BARS.
- 27. WHERE PAVING, WALKS AND/OR LANDSCAPED AREAS ARE DISTURBED OR DAMAGED DURING CONSTRUCTION, THEY SHALL BE REPAIRED OR REPLACED TO MATCH EXISTING CONDITIONS.
- 28. ALL STEEL COMPONENTS EXPOSED TO WEATHER SHALL BE GALVANIZED.
- 29. ALL FINISH COMPONENTS, NOT PRE FINISHED, SHALL BE PAINTED.
- 30. EXIT DOORS TO BE OPENABLE FROM INSIDE WITHOUT USE OF A KEY OR ANY SPECIAL KNOWLEDGE OR EFFORT.
- 31. ANY NEW PROPOSED SIGNS ARE TO BE ISSUED UNDER SEPERATE PERMIT.
- 32. CONTRACTOR SHALL REMOVE ANY TEMPORARY TRAILERS AND DUMPSTERS RELATED TO PROJECTCONSTRUCTION PRIOR TO FINAL
- 33. CONTRACTOR SHALL RESLURRY AND RE-STRIP PARKING LOT AS NEEDED TO ENSURE THAT PORTION OF LOT SERVING TENANT SPACE IS IN GOOD REPAIR AND APPEARANCE PRIOR TO FINAL SIGN-OFF BY PLANNING DIVISION. PARKING STALL STRIPPING SHALL BE CLEARLY VISIBLE OR SHALL BE RE-STRIPED BY CONTRACTOR.
- 34. THE GENERAL CONTRACTOR SHALL RED LINE ALL FIELD CHANGES ON A SET OF PRINTS TO REMAIN ON SITE THROUGHOUT THE CONSTRUCTION OF THE PROJECT. IT IS THE GC'S RESPONSIBILITY TO RECORD ALL FIELD CHANGES AND SUBMIT THE 'AS BUILTS' TO
- 35. THE CONTRACTOR SHALL BE RESPONSIBLE FOR CLEANUP OF ALL SILT AND MUD ON ADJACENT STREETS DUE TO CONSTRUCTION VEHICLES OR ANY OTHER CONSTRUCTION ACTIVITY, AT THE END OF EACH WORKDAY, OR AFTER A STORM EVENT THAT CAUSES A BREECH IN INSTALLED CONSTRUCTION BMP:S WHICH MAY COMPROMISE STORM WATER QUALITY WITHIN ANY STREET. A STABILIZED CONSTRUCTION EXIT MAY BE REQUIRED TO PREVENT CONSTRUCT. VEHICLES OR EQUIPMENT FROM TRACKING MUD OR SILT INTO THE

GENERAL NOTES (continued)

B. DEFINITIONS:

- "TYPICAL" OR "TYP" INDICATES IDENTICAL COMPLETE SYSTEM SHALL BE PROVIDED FOR EACH OCCURRENCE OF THE CONDITION
- "SIMILAR" INDICATES COMPLETE SYSTEM AND COMPONENTS SHALL BE PROVIDED COMPARABLE TO THE CHARACTERISTICS FOR THE
 - "AS REQUIRED" INDICATES COMPONENTS REQUIRED TO COMPLETE THE NOTED SYSTEM AS INDICATED IN THE PROJECT DOCUMENTS.
- "ALIGN" INDICATES ACCURATELY PROVIDE FINISH FACES OF MATERIALS IN STRAIGHT, TRUE AND PLUMB RELATION TO ADJACENT
- C. DIMENSIONS:
- DIMENSIONS ARE INDICATED TO THE CENTERLINE OF THE STRUCTURAL GRID, FACE OF CONCRETE WALL, NOMINAL FACE OF CMU WALL, FACE OF PARTITION AS SCHEDULED, UNLESS OTHERWISE NOTED.
- MINIMUM DIMENSIONS FOR ACCESSIBILITY CLEARANCES AND BUILDING CODE REQUIREMENTS SHALL BE MAINTAINED.
- FLOOR ELEVATIONS ARE INDICATED TO THE FACE OF THE STRUCTURAL SLAB, UNLESS OTHERWISE NOTED.
- VERTICAL DIMENSIONS ARE INDICATED FROM THE FLOOR ELEVATION TO FACE OF FINISHED MATERIAL, UNLESS NOTED ABOVE FINISH
- CEILING HEIGHTS ARE INDICATED FROM THE FLOOR ELEVATION TO THE FACE OF SUSPENDED ACOUSTIC PANEL CEILING GRID OR FACE OF FINISH MATERIAL FOR OTHER CEILING TYPES, UON.
- DIMENSIONS SHOWN ON THE DRAWINGS SHALL INDICATE THE REQUIRED SIZE, CLEARANCE AND DIMENSIONAL RELATIONSHIP BETWEEN PROJECT SYSTEMS AND COMPONENTS. DIMENSIONS SHALL NOT BE DETERMINED BY SCALING THE DRAWINGS.
- ALIGNMENT OF PARTITIONS AND FINISHES AS SCHEDULED SHALL BE STRAIGHT, TRUE & PLUMB. THE PRIORITY FOR PROJECT DIMENSIONS SHALL BE IN THE FOLLOWING ORDER:
 - STRUCTURAL DRAWINGS
 - LARGE SCALE DETAILS SMALL SCALE DETAILS
 - ENLARGED VIEWS
 - FLOOR PLANS AND ELEVATIONS

D. DRAWING SET ORGANIZATION:

- EACH DRAWING SET SHEET IS IDENTIFIED BY THE SHEET NUMBER IN THE LOWER RIGHT HAND CORNER OF THE DRAWING TITLE BLOCK. THE SHEET TITLE PROVIDES A GENERAL DESCRIPTION OF THE CONTENTS OF THE SHEET.
- SHEET NUMBER


 - "A" INDICATES THE DISCIPLINE THAT CREATED THE DRAWING "2" INDICATES THE DRAWING CATEGORY CONTAINED ON THE SHEET
- "01" INDICATES THE SHEET NUMBER SHEET NUMBERS MAY INCLUDE SUPPLEMENTAL CHARACTERS TO PROVIDE ADDITIONAL INFORMATION, SUCH AS DRAWING CONTENT,
- PROJECT SECTOR OR PHASE. REFER TO THE DRAWING INDEX FOR A COMPLETE LIST OF SHEETS INCLUDED IN THE DOCUMENT SET.
- "EL" INDICATES THE DISCIPLINE THAT CREATED THE DRAWING AND THE DRAWING CONTENT = ELECTRICAL LIGHTING "A" INDICATES SECTOR "A" OF PLAN SHEET "201". REFER TO THE PROJECT KEY PLAN OR COMPOSITE PLAN INDICATING THE
- DRAWING SET INDEX INDICATES THE COMPLETE LIST OF SHEETS CONTAINED IN THE DRAWING SET, INDEXED BY DISCIPLINE, SHEET NUMBER AND SHEET TITLE, IN SEQUENTIAL ORDER. NOTE THAT ALL SEQUENTIAL SHEET NUMBERS MAY BE NOT USED IN THE DRAWING
- DISCIPLINE IDENTIFICATION, IN ORDER BOUND IN THE DRAWING SET. REFER TO THE DRAWING SET INDEX FOR DISCIPLINE CONTAINED
- IN THIS DRAWING SET:
 - G GENERAL INFORMATION Q EQUIPMENT F FIRE PROTECTION C CIVIL P PLUMBING
 - L LANDSCAPE M MECHANICAL

INTERNATIONAL RESIDENTIAL CODE, 2018 ED.

- S STRUCTURAL
- A ARCHITECTURAL
- I INTERIORS

E ELECTRICAL T TELECOMMUNICATIONS

SYMBOL LEGEND

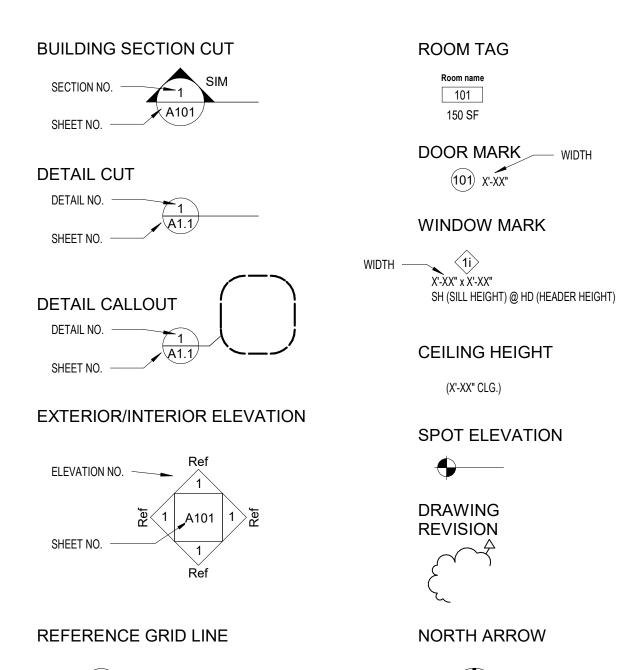

CODE INFORMATION

'ODESSA' MODEL - ELEVATION D



17819 SOUTH BLUE HERON BAY CIRCLE

KEY SITE PLAN

PROJECT DATA

17819 SOUTH BLUE HERON BAY CIRCLE ADDRESS: SUBDIVISON: BLUE HERON BAY BLOCK: SECTION: COUNTY:

ODESSA-D

PLAN:

MONTGOMERY

PROPOSED AREAS

CONDITIONED FIRST FLOOR AREA SECOND FLOOR AREA TOTAL CONDITONED	ELEVATION C 2,159 SQ. FT. 1,545 SQ. FT. 3,704 SQ. FT.	ELEVATION D 2,112 SQ. FT. 1,533 SQ. FT. 3,671 SQ. FT.
NON-CONDITIONED		
FIRST FLOOR AREA	932 SQ. FT.*	925 SQ. FT.*
SECOND FLOOR AREA	133 SQ. FT.	133 SQ. FT.
TOTAL NON-CONDITIONED	1,040 SQ. FT.	1,058 SQ. FT.
* DESIGN OPTION 5 ADD 240 SF TO FIRST FLOOR CONDITIONED AREA AND		

DEMOVE ON OF FROM NON CONDITIONED AREA

REMOVE 240 SF FROM NON-CONDITIONED AREA		
SLAB AREAS		
HOUSE SLAB	2,132 SQ. FT.	2,112 SQ. FT
GARAGE SLAB	698 SQ. FT.*	726 SQ. FT
PORCHES SLAB	235 SQ. FT.	199 SQ. FT
TOTAL SLAB	3,064 SQ. FT.	3,037 SQ. FT.
* DESIGN OPTION 5 ADD 240 SF TO HOUSE SLAB AREA AND REMOVE 240 SF		

FROM GARAGE SLAB AREA

FLATWORK AREAS		
DRIVEWAY	973 SQ. FT.	987 SQ.
TOTAL FLATWORK	973 SQ. FT.	987 SQ.

SHEET		CURREN
NUMBER SHEET NAME	ISSUE DATE	REVISIO
A 0.01 INDEX AND PROJECT DATA	09/19/23	
A 1.00 SITE PLAN	09/19/23	1
A 1.01 FIRST FLOOR PLAN	09/19/23	1
A 1.02 SECOND FLOOR PLAN	09/19/23	1
A 1.03 ROOF PLAN	09/19/23	1
A 1.11 EOS PLAN	09/19/23	1
A 1.21 FIRST FLOOR REFLECTED CEILING PLAN	09/19/23	1
A 1.22 SECOND FLOOR REFLECTED CEILING PLAN	09/19/23	1
A 1.31 FIRST FLOOR PLAN CONSTRUCTION DIMENSIONS	09/19/23	1
A 1.32 SECOND FLOOR PLAN CONSTRUCTION DIMENSIONS	09/19/23	1
A 2.00 EXTERIOR ELEVATIONS	09/19/23	1
A 2.01 EXTERIOR ELEVATIONS	09/19/23	1
A 2.02 EXTERIOR ELEVATIONS	09/19/23	1
A 2.03 EXTERIOR ELEVATIONS	09/19/23	1
A 3.00 BUILDING SECTIONS	09/19/23	1
A 3.01 BUILDING SECTIONS	09/19/23	1
A 4.00 TYPICAL WALL SECTIONS	09/19/23	
A 5.01 INTERIOR ELEVATIONS	09/19/23	1
A 5.02 INTERIOR ELEVATIONS	09/19/23	1
A 5.10 DETAILS	09/19/23	
A 5.11 DETAILS	09/19/23	
A 6.00 WINDOW AND DOOR SCHEDULES	09/19/23	1

DRAWING SET INDEX

ARCHITECTURAL CAD


HITECTURAL C&I	0		
ET			CURRENT
BER	SHEET NAME	ISSUE DATE	REVISION
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A 1.00 SITE PLAN		09/19/23	1
A 1.01 FIRST FLOOR PLAN		09/19/23	1
A 1.02 SECOND FLOOR PLA	AN	09/19/23	1
A 1.03 ROOF PLAN		09/19/23	1
A 1.11 EOS PLAN		09/19/23	1
A 1.21 FIRST FLOOR REFLE	ECTED CEILING PLAN	09/19/23	1
A 1.22 SECOND FLOOR RE	FLECTED CEILING PLAN	09/19/23	1
A 1.31 FIRST FLOOR PLAN	CONSTRUCTION DIMENSIONS	09/19/23	1
A 1.32 SECOND FLOOR PLA	AN CONSTRUCTION DIMENSIONS	09/19/23	1
A 2.00 EXTERIOR ELEVATION	DNS	09/19/23	1
A 2.01 EXTERIOR ELEVATION	DNS	09/19/23	1
A 2.02 EXTERIOR ELEVATION	DNS	09/19/23	1
A 2.03 EXTERIOR ELEVATION	DNS	09/19/23	1
A 3.00 BUILDING SECTIONS	8	09/19/23	1
A 3.01 BUILDING SECTIONS	3	09/19/23	1
A 4.00 TYPICAL WALL SECT	TIONS	09/19/23	
A 5.01 INTERIOR ELEVATION	NS	09/19/23	1
A 5.02 INTERIOR ELEVATION	NS	09/19/23	1
A 5.10 DETAILS		09/19/23	
A 5.11 DETAILS		09/19/23	
A 6.00 WINDOW AND DOOF	RSCHEDULES	09/19/23	1

ARCHITECT:

based

Based Architects, LLC info@wearebased.com 832-422-7337 www.wearebased.com


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INDEX AND PROJECT DATA

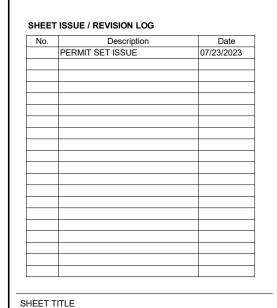JOB NUMBER SHEET NUMBER

DESIGN OPTIONS 07/23/2023




ARCHITECT: based

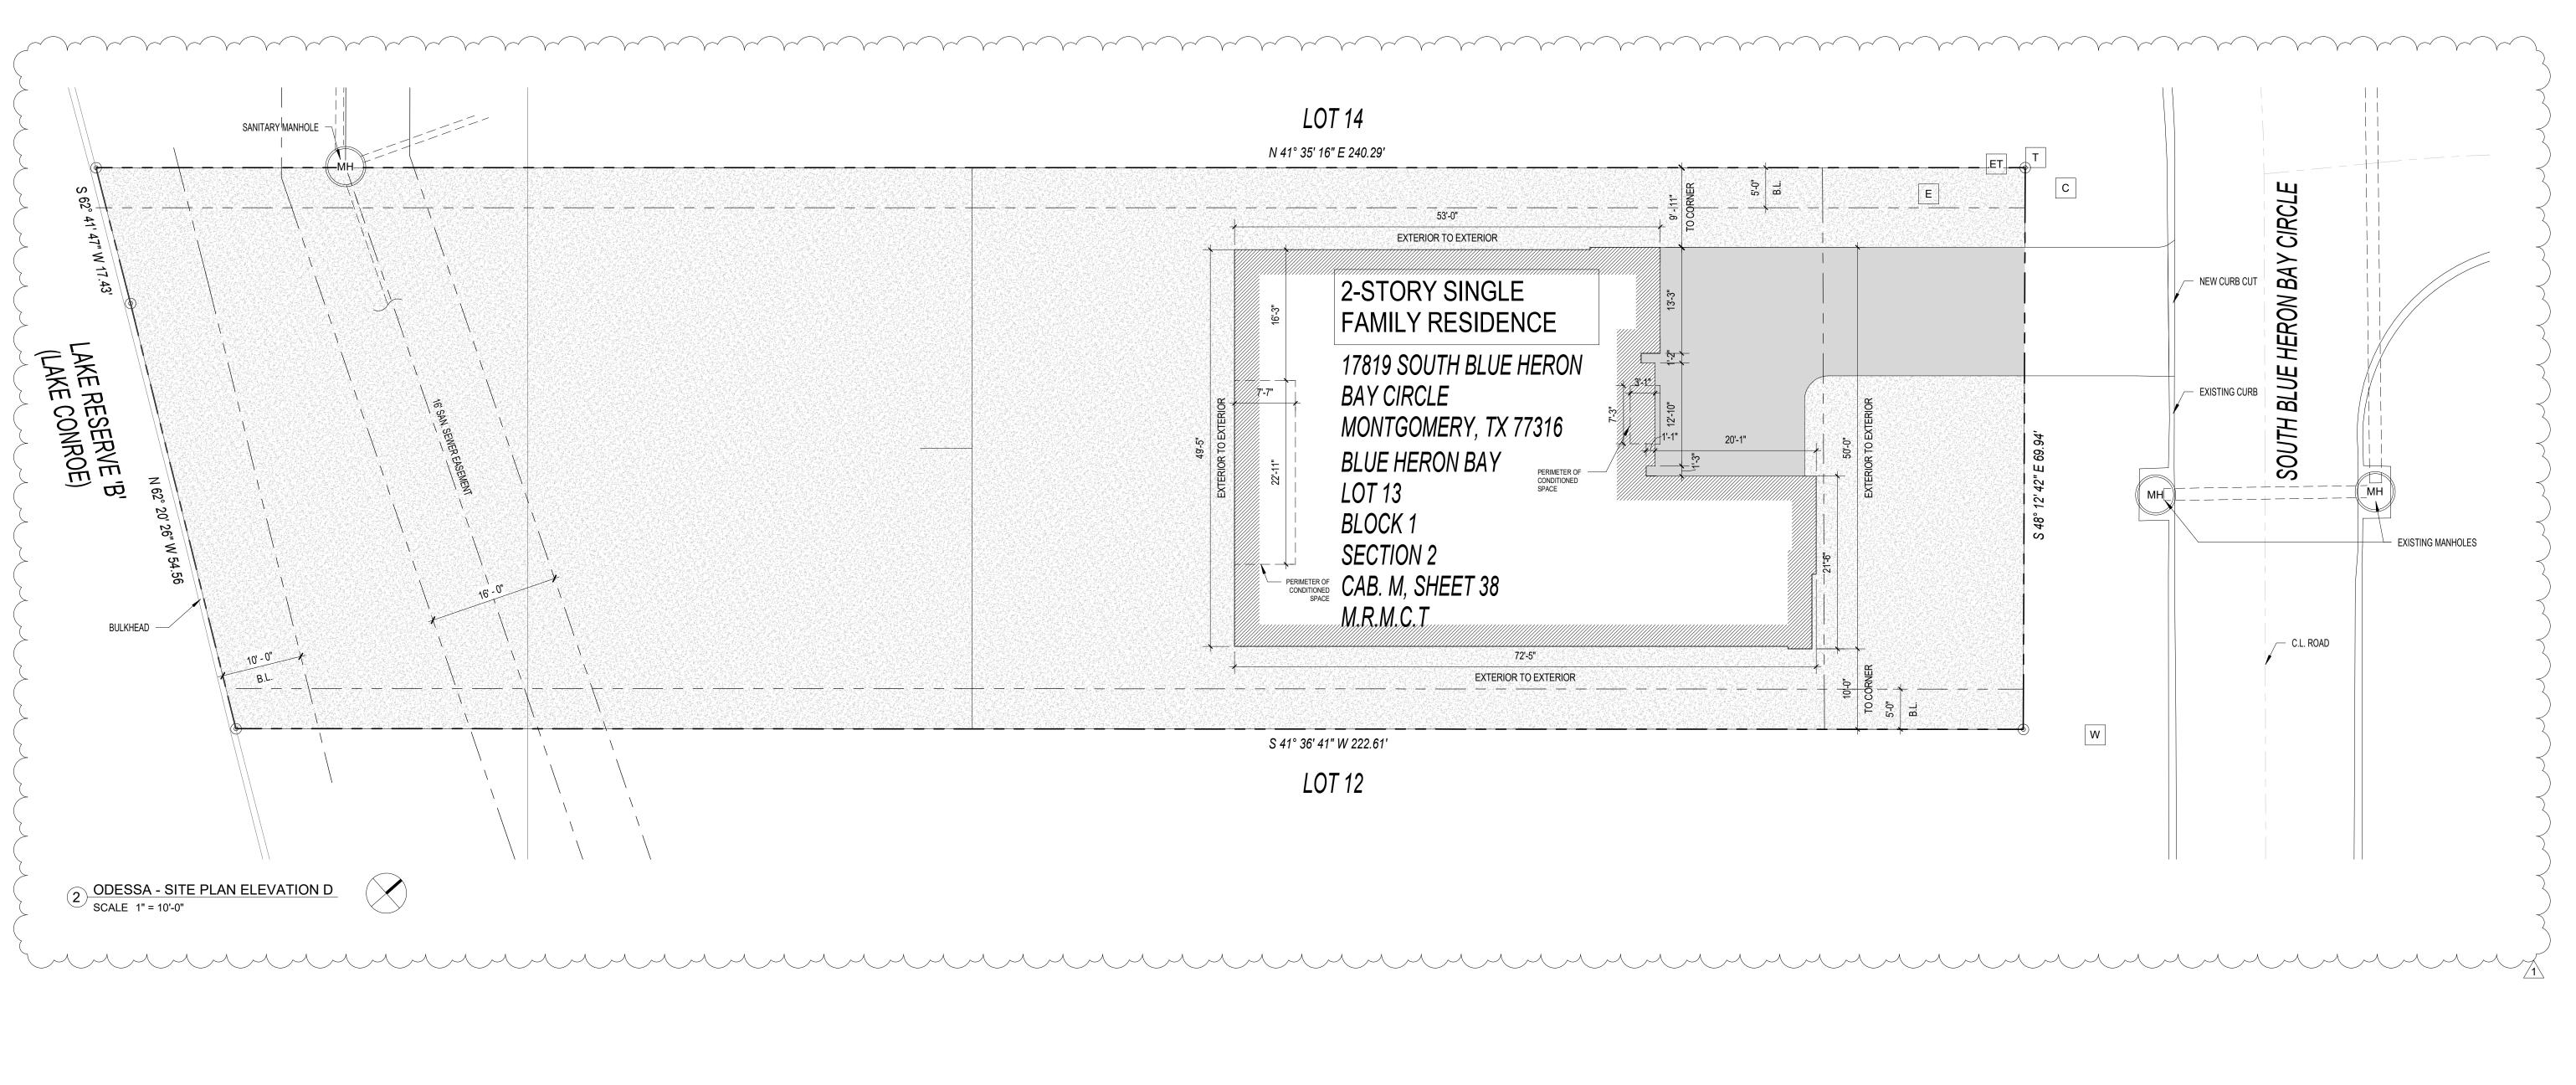
Based Architects, LLC info@wearebased.com 832-422-7337

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DRAWINGS, SPECIFICATIONS AND OTHER DOCUMENTS DRAWINGS, SPECIFICATIONS AND OTHER DOCUMENTS PREPARED BY THE ARCHITECT AND ARCHITECT'S CONSULTANTS ARE INSTRUMENTS OF SERVICE FOR USE SOLELY WITH RESPECT TO THIS PROJECT. IT IS A VIOLATION OF THE LAW FOR ANY PERSON, UNLESS ACTING UNDER THE DIRECTION OF BASED ARCHITECTS, LLC TO ALTER AN ITEM IN THESE CONSTRUCTION DOCUMENTS IN ANY WAY. IN THE EVENT THESE DOCUMENTS ARE TO BE ADOPTED BY A SUCCESSOR ARCHITECT, THE SUCCESSOR ARCHITECT SHALL BE REQUIRED, PRIOR TO ADOPTING SAID WORK, TO NOTIFY THE ORIGINAL ARCHITECT BY CERTIFIED LETTER OF THE SUCCESSOR'S INTENTION TO ADOPT THE ORIGINAL ARCHITECT WORK. THE SUCCESSOR ARCHITECT ALTERING ANY PORTION OF SUCCESSOR ARCHITECT ALTERING ANY PORTION OF THE WORK WILL TAKE FULL RESPONSIBILITY FOR THE ENTIRE PROJECT AS THOUGH THEY WERE THE SUCCESSOR ARCHITECT'S ORIGINAL PRODUCT. PROFESSIONAL SEAL(S):

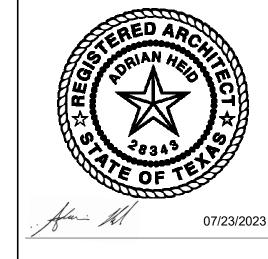

ODESSA FRENCH QUARTER PERMIT DOCUMENTS
17819 SOUTH BLUE HERON BAY CIRCLE
MONTGOMERY, TX 77316

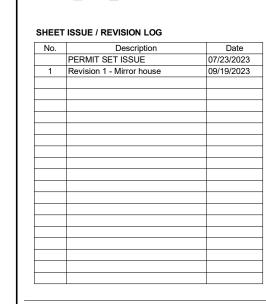

SITE PLAN

JOB NUMBER SHEET NUMBER

07/23/2023

IMPERVIOUS COVER:

LOT SIZE: 16,173 SQ. FT.

ELEVATION C 4,037 SQ. FT.

ELEVATION D 3,986 SQ. FT.

SITE PLAN LEGEND

PERVIOUS AREA PROPOSED BUILDING PAVED AREA AREA NOT IN SCOPE

GENERAL NOTES


GENERAL CONTRACTOR TO VERIFY ALL FIELD CONDITIONS PRIOR TO COMMENCEMENT AND REPORT ANY DISCREPANCIES TO THE ARCHITECT. GENERAL CONTRACTOR TO VERIFY ALL EXISTING SITE UTILITIES PRIOR TO


CONSTRUCTION. EXISTING DRIVEWAY TO REMAIN. NO NEW SITE WORK.


HARDSCAPE FROM CONSTRUCTION WORK.


EXISTING LANDSCAPE TO REMAIN. GENERAL CONTRACTOR TO PROTECT EXISTING LANDSCAPE AND


IMPERVIOUS COVER PERCENTAGE: 24.6%

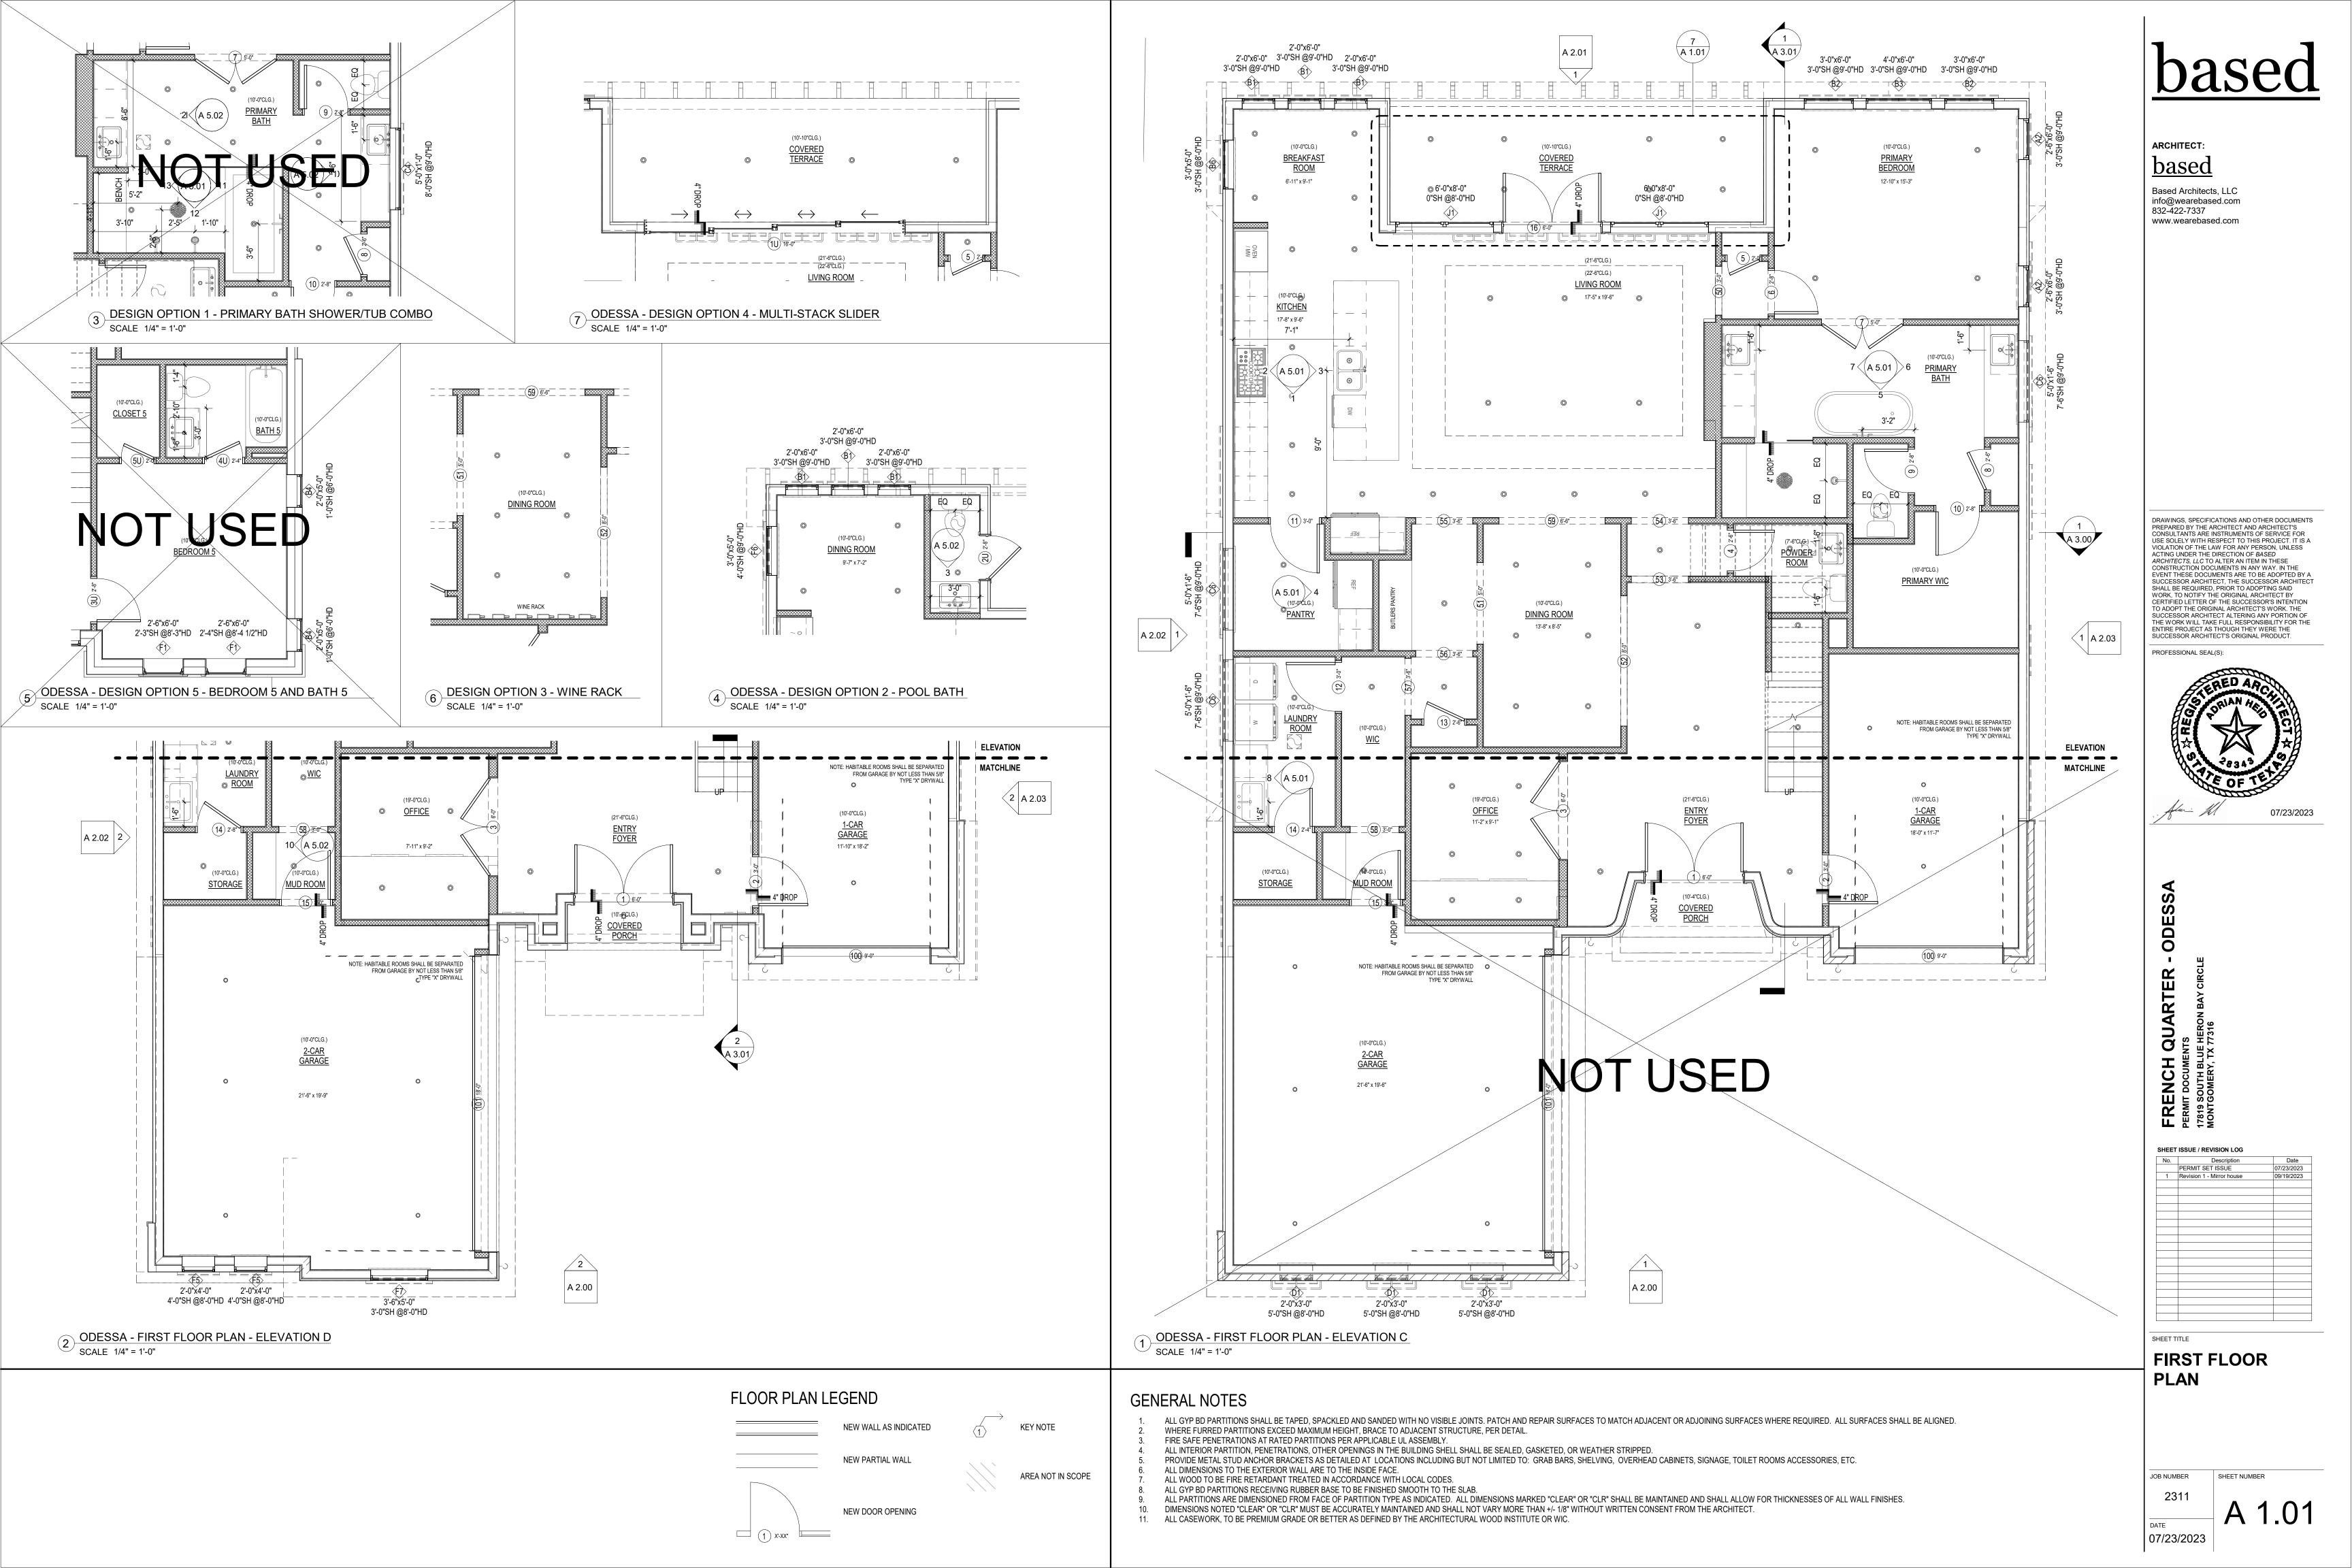


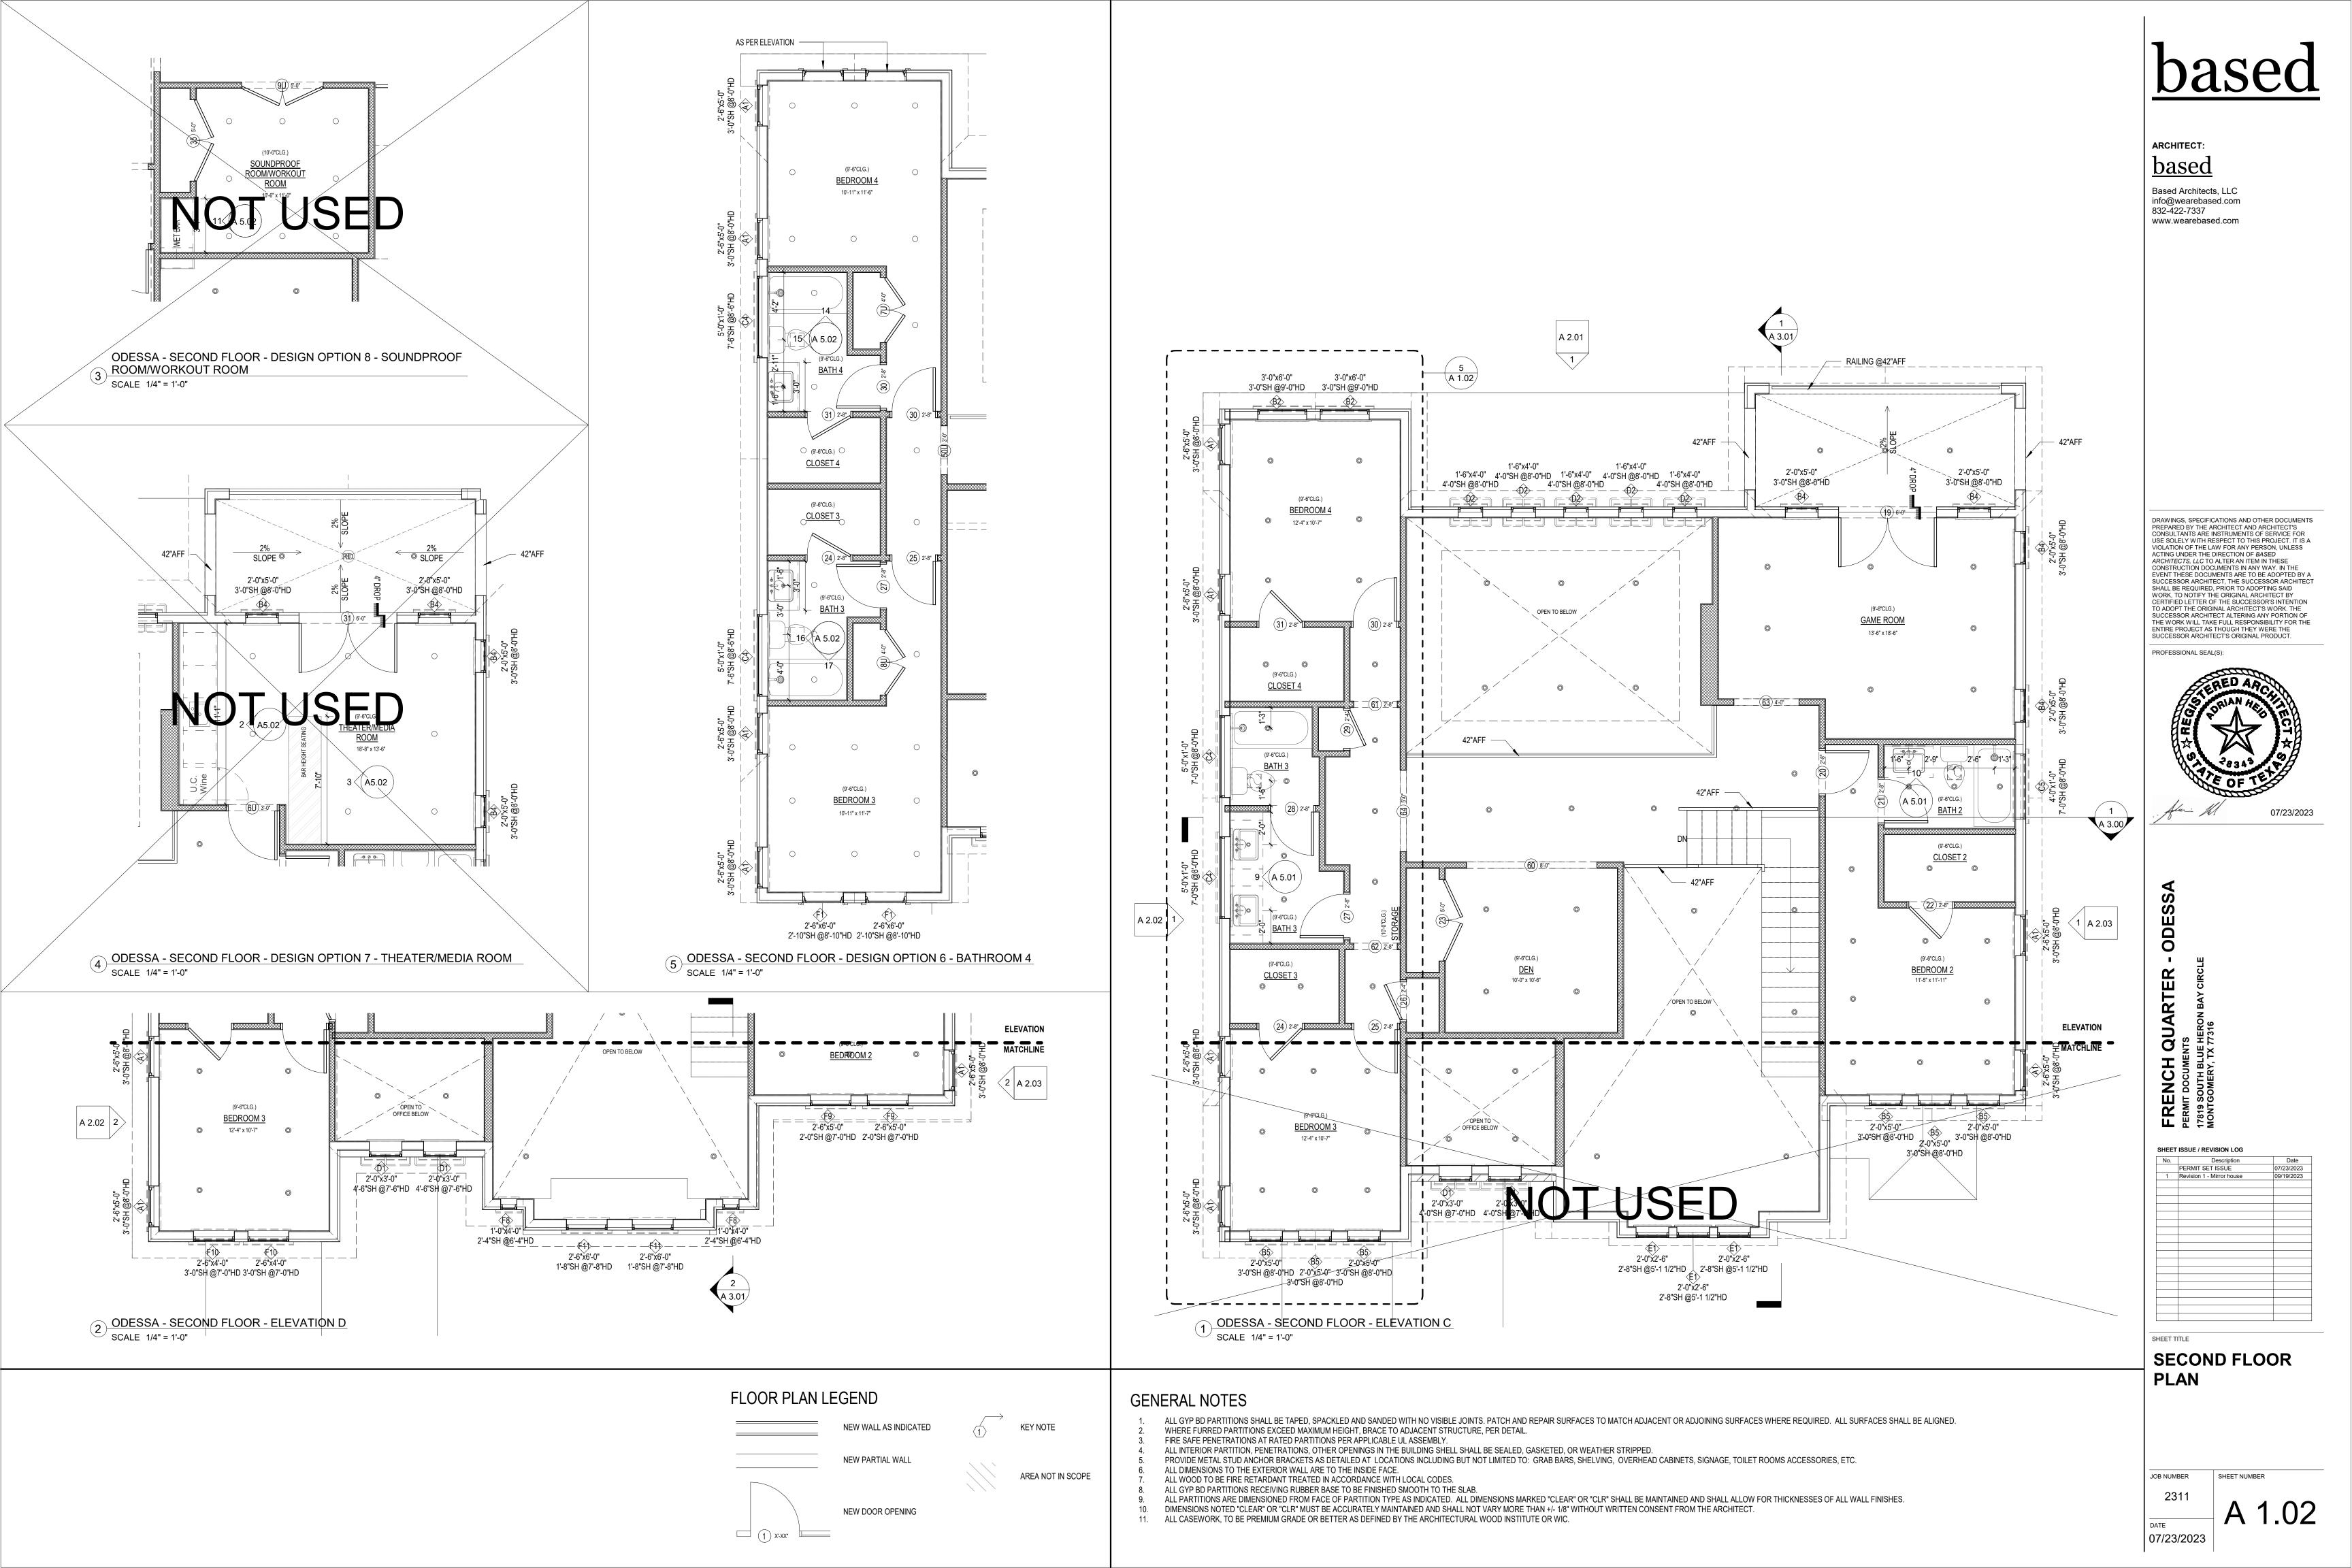


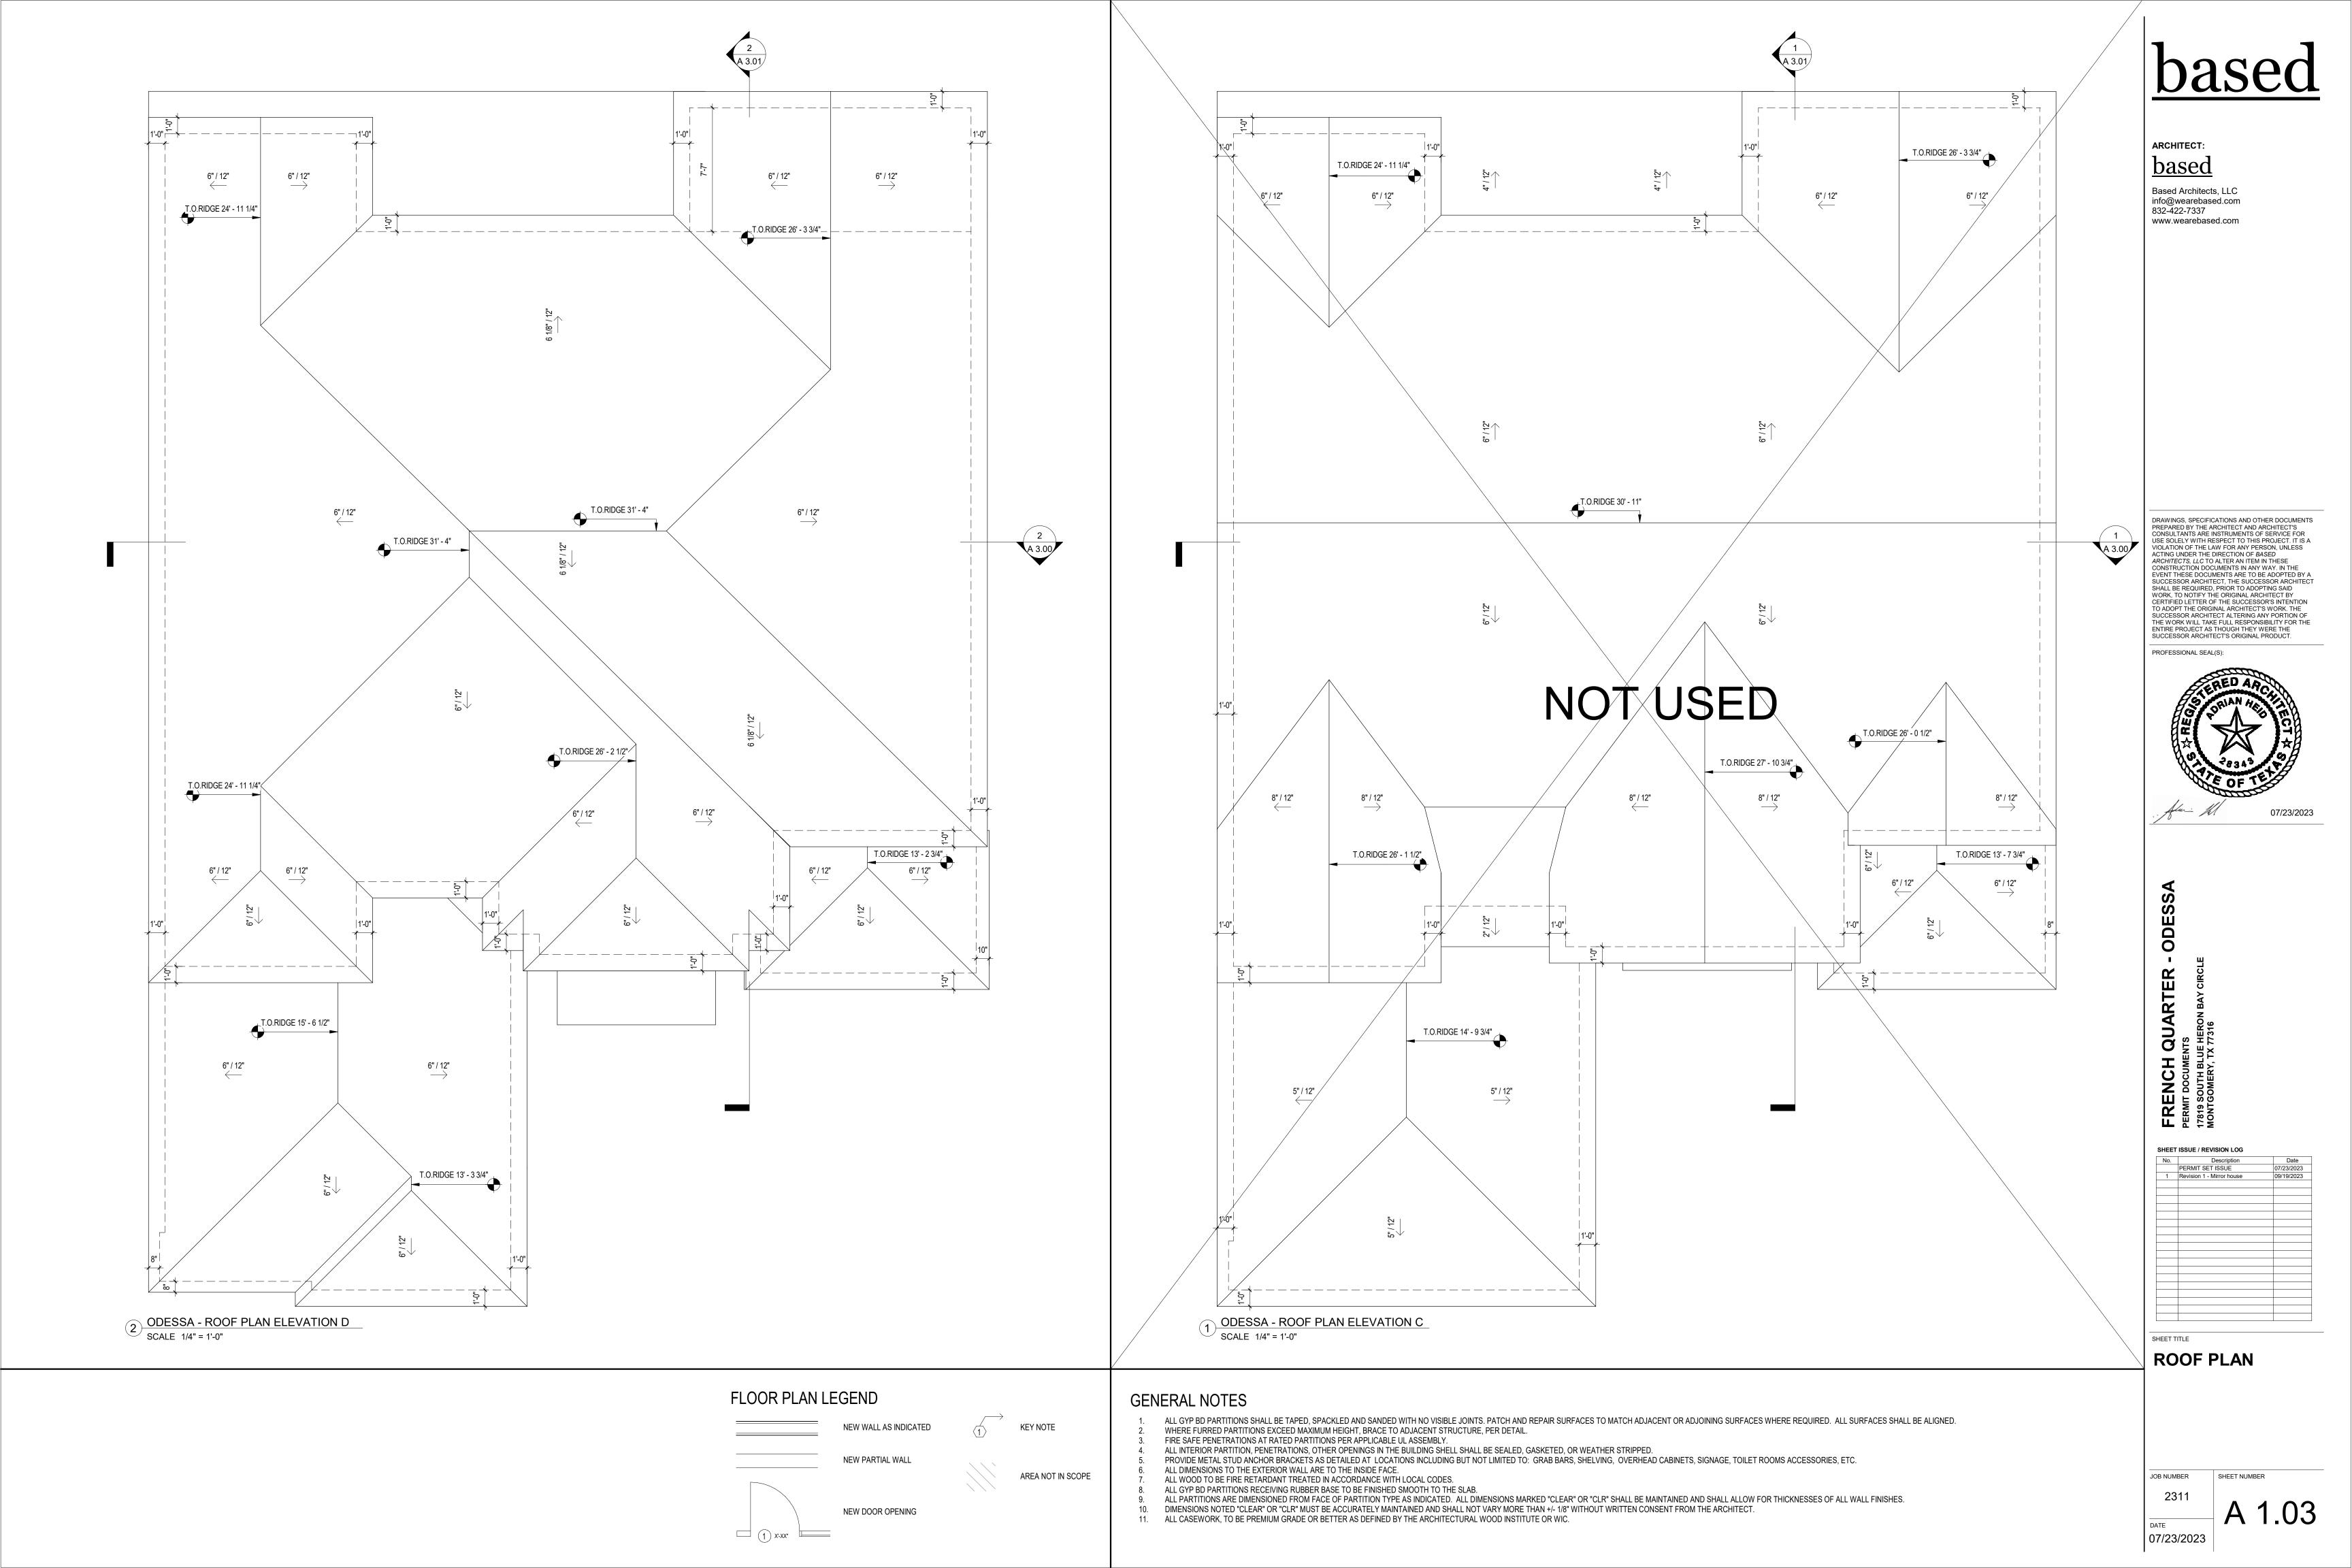


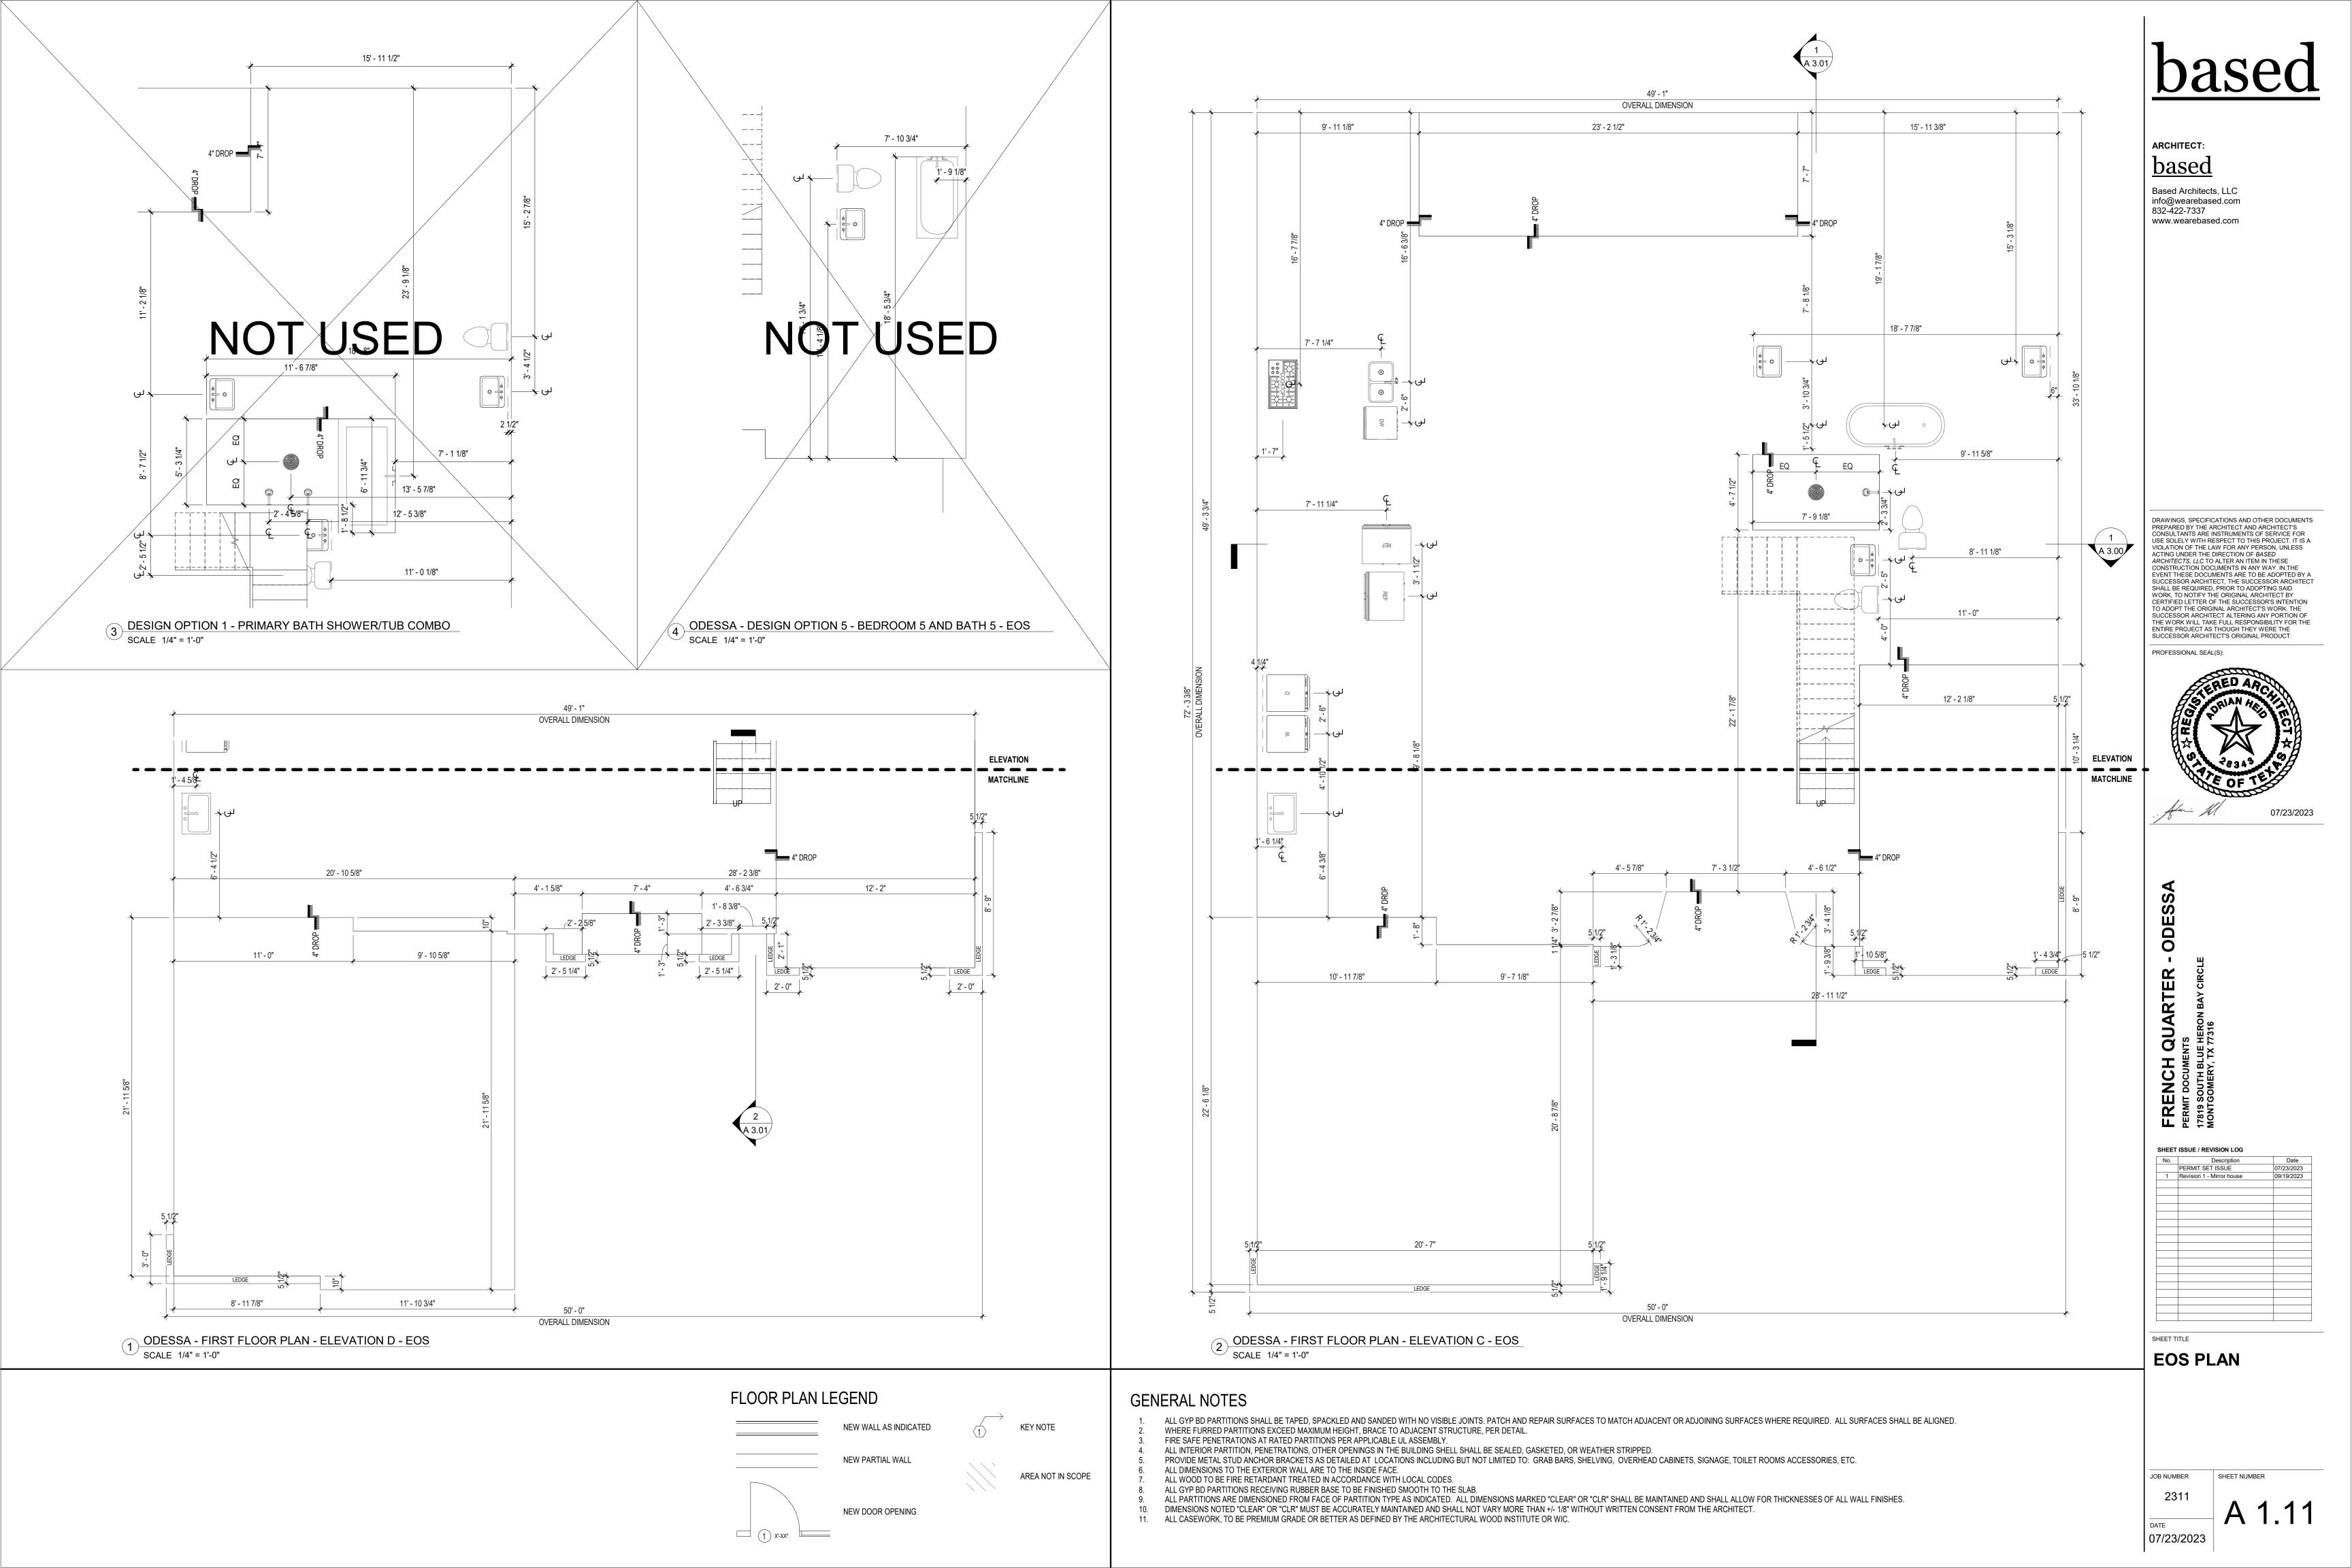


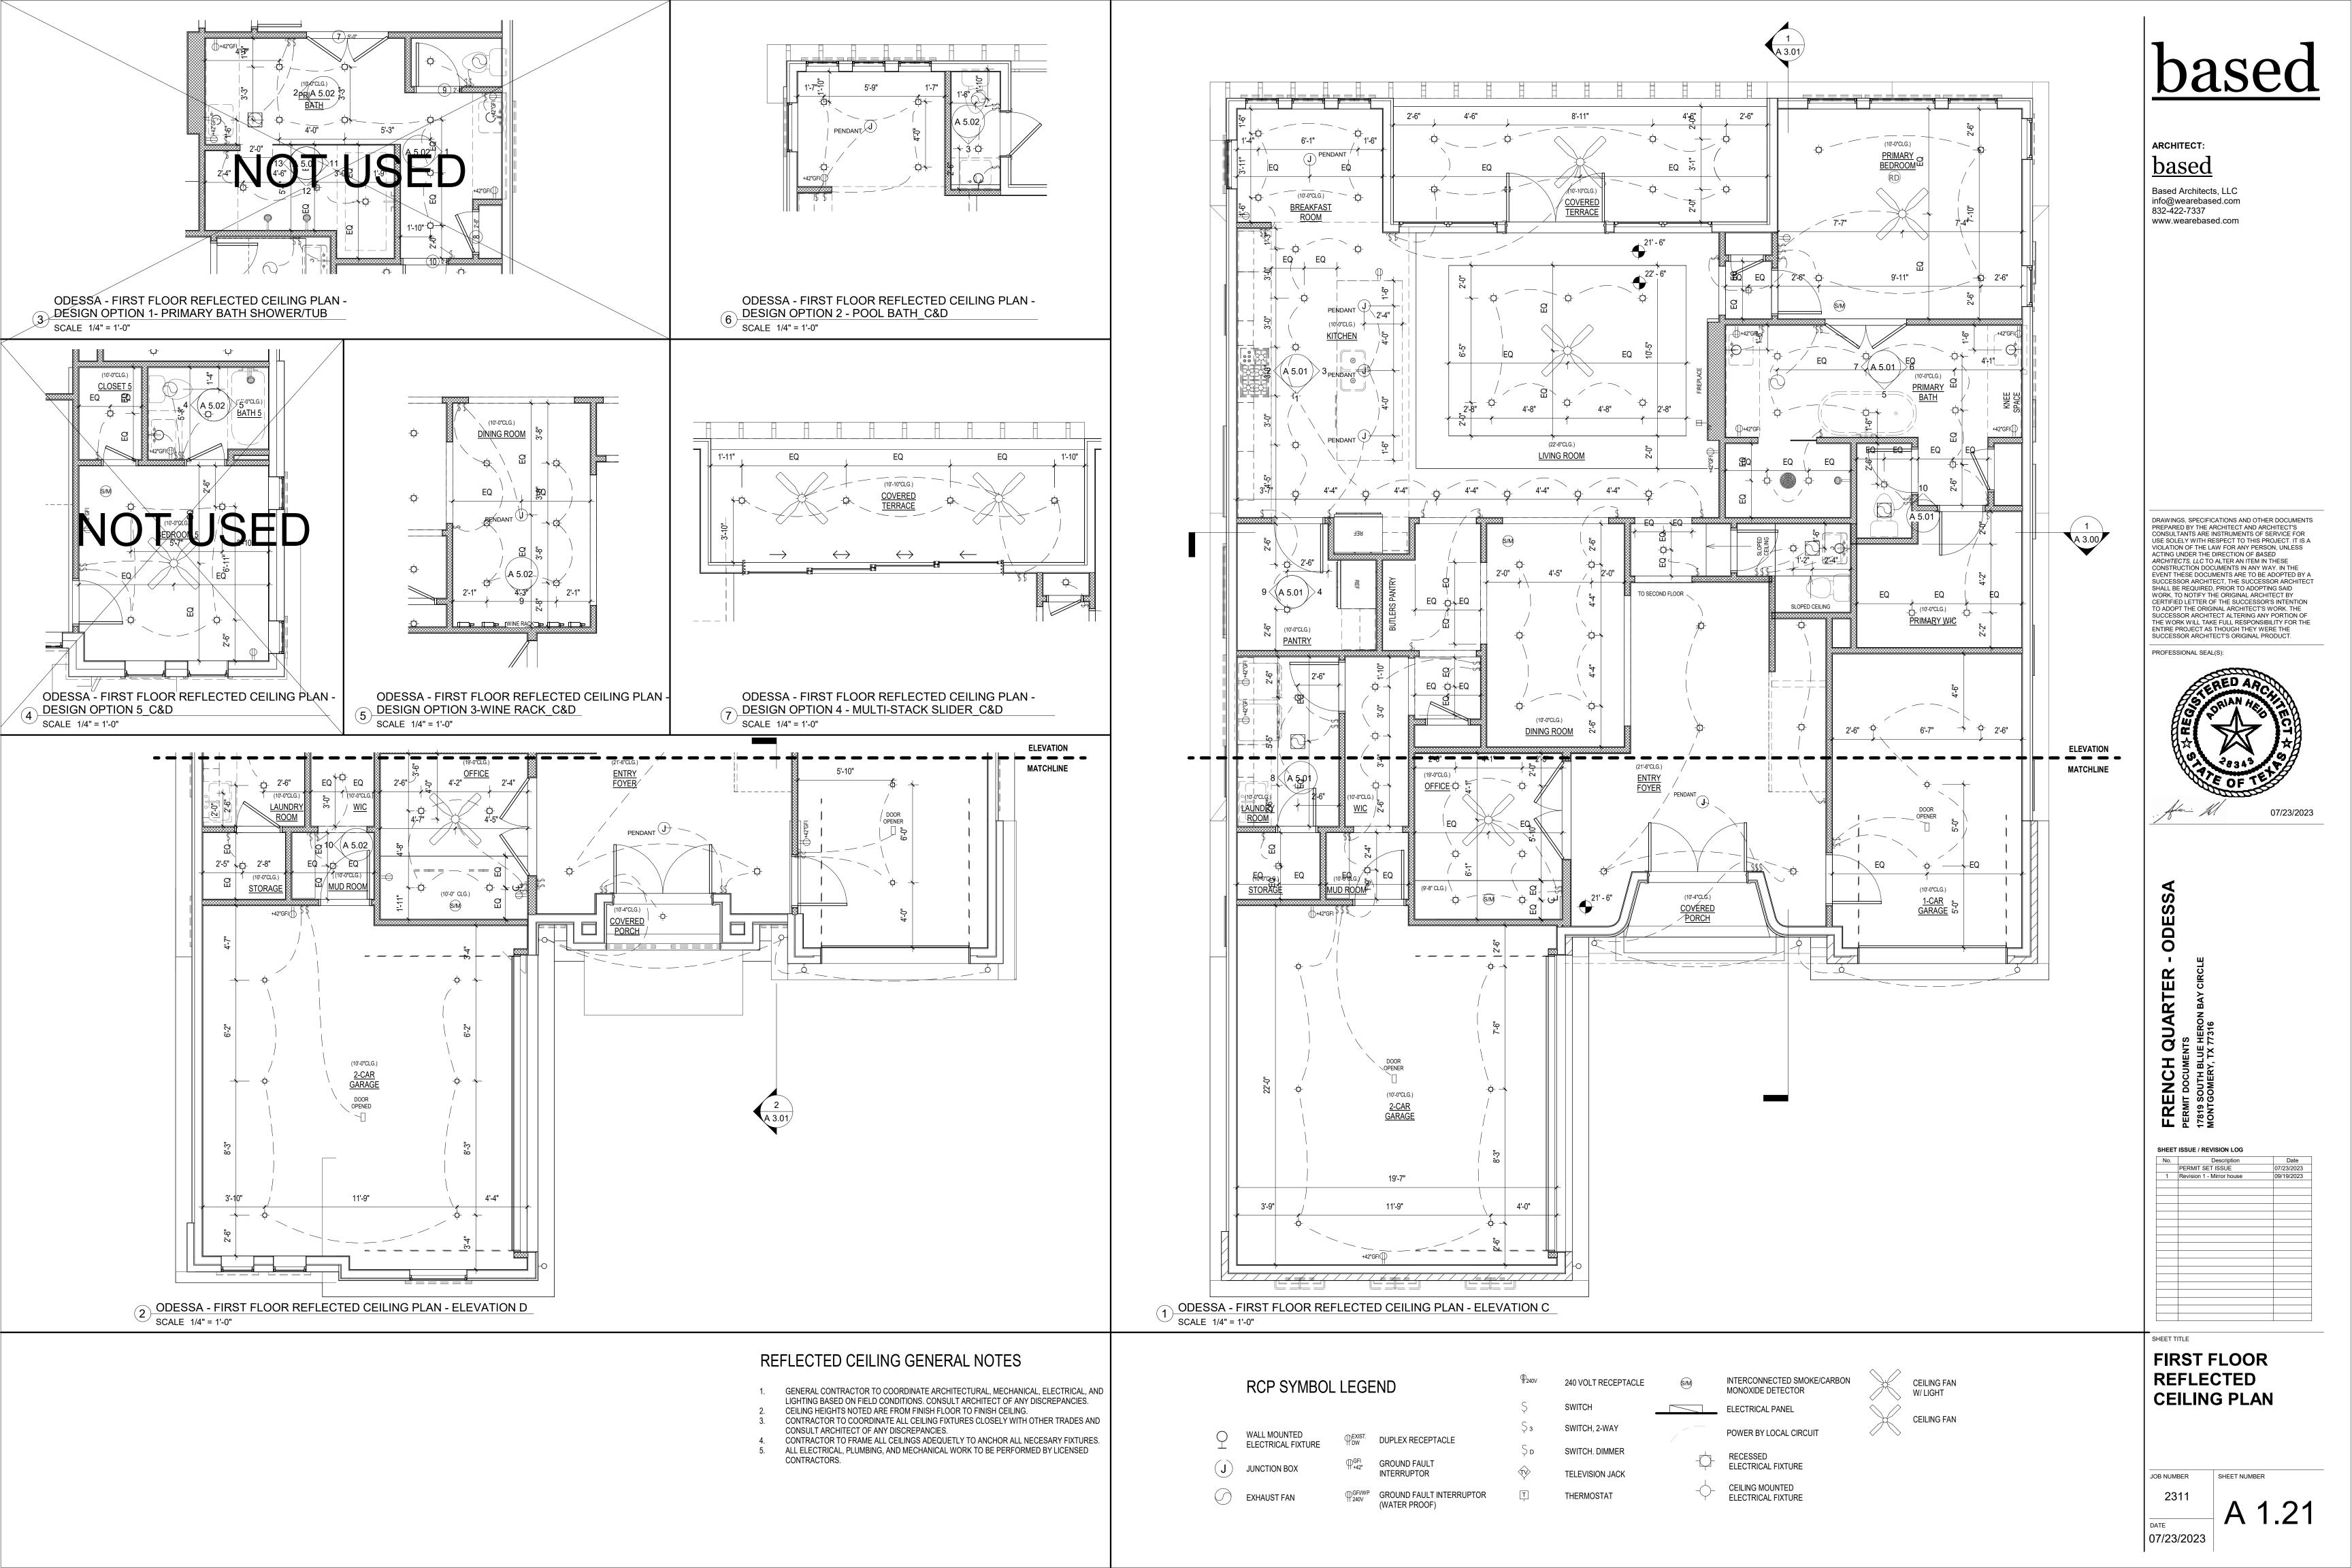


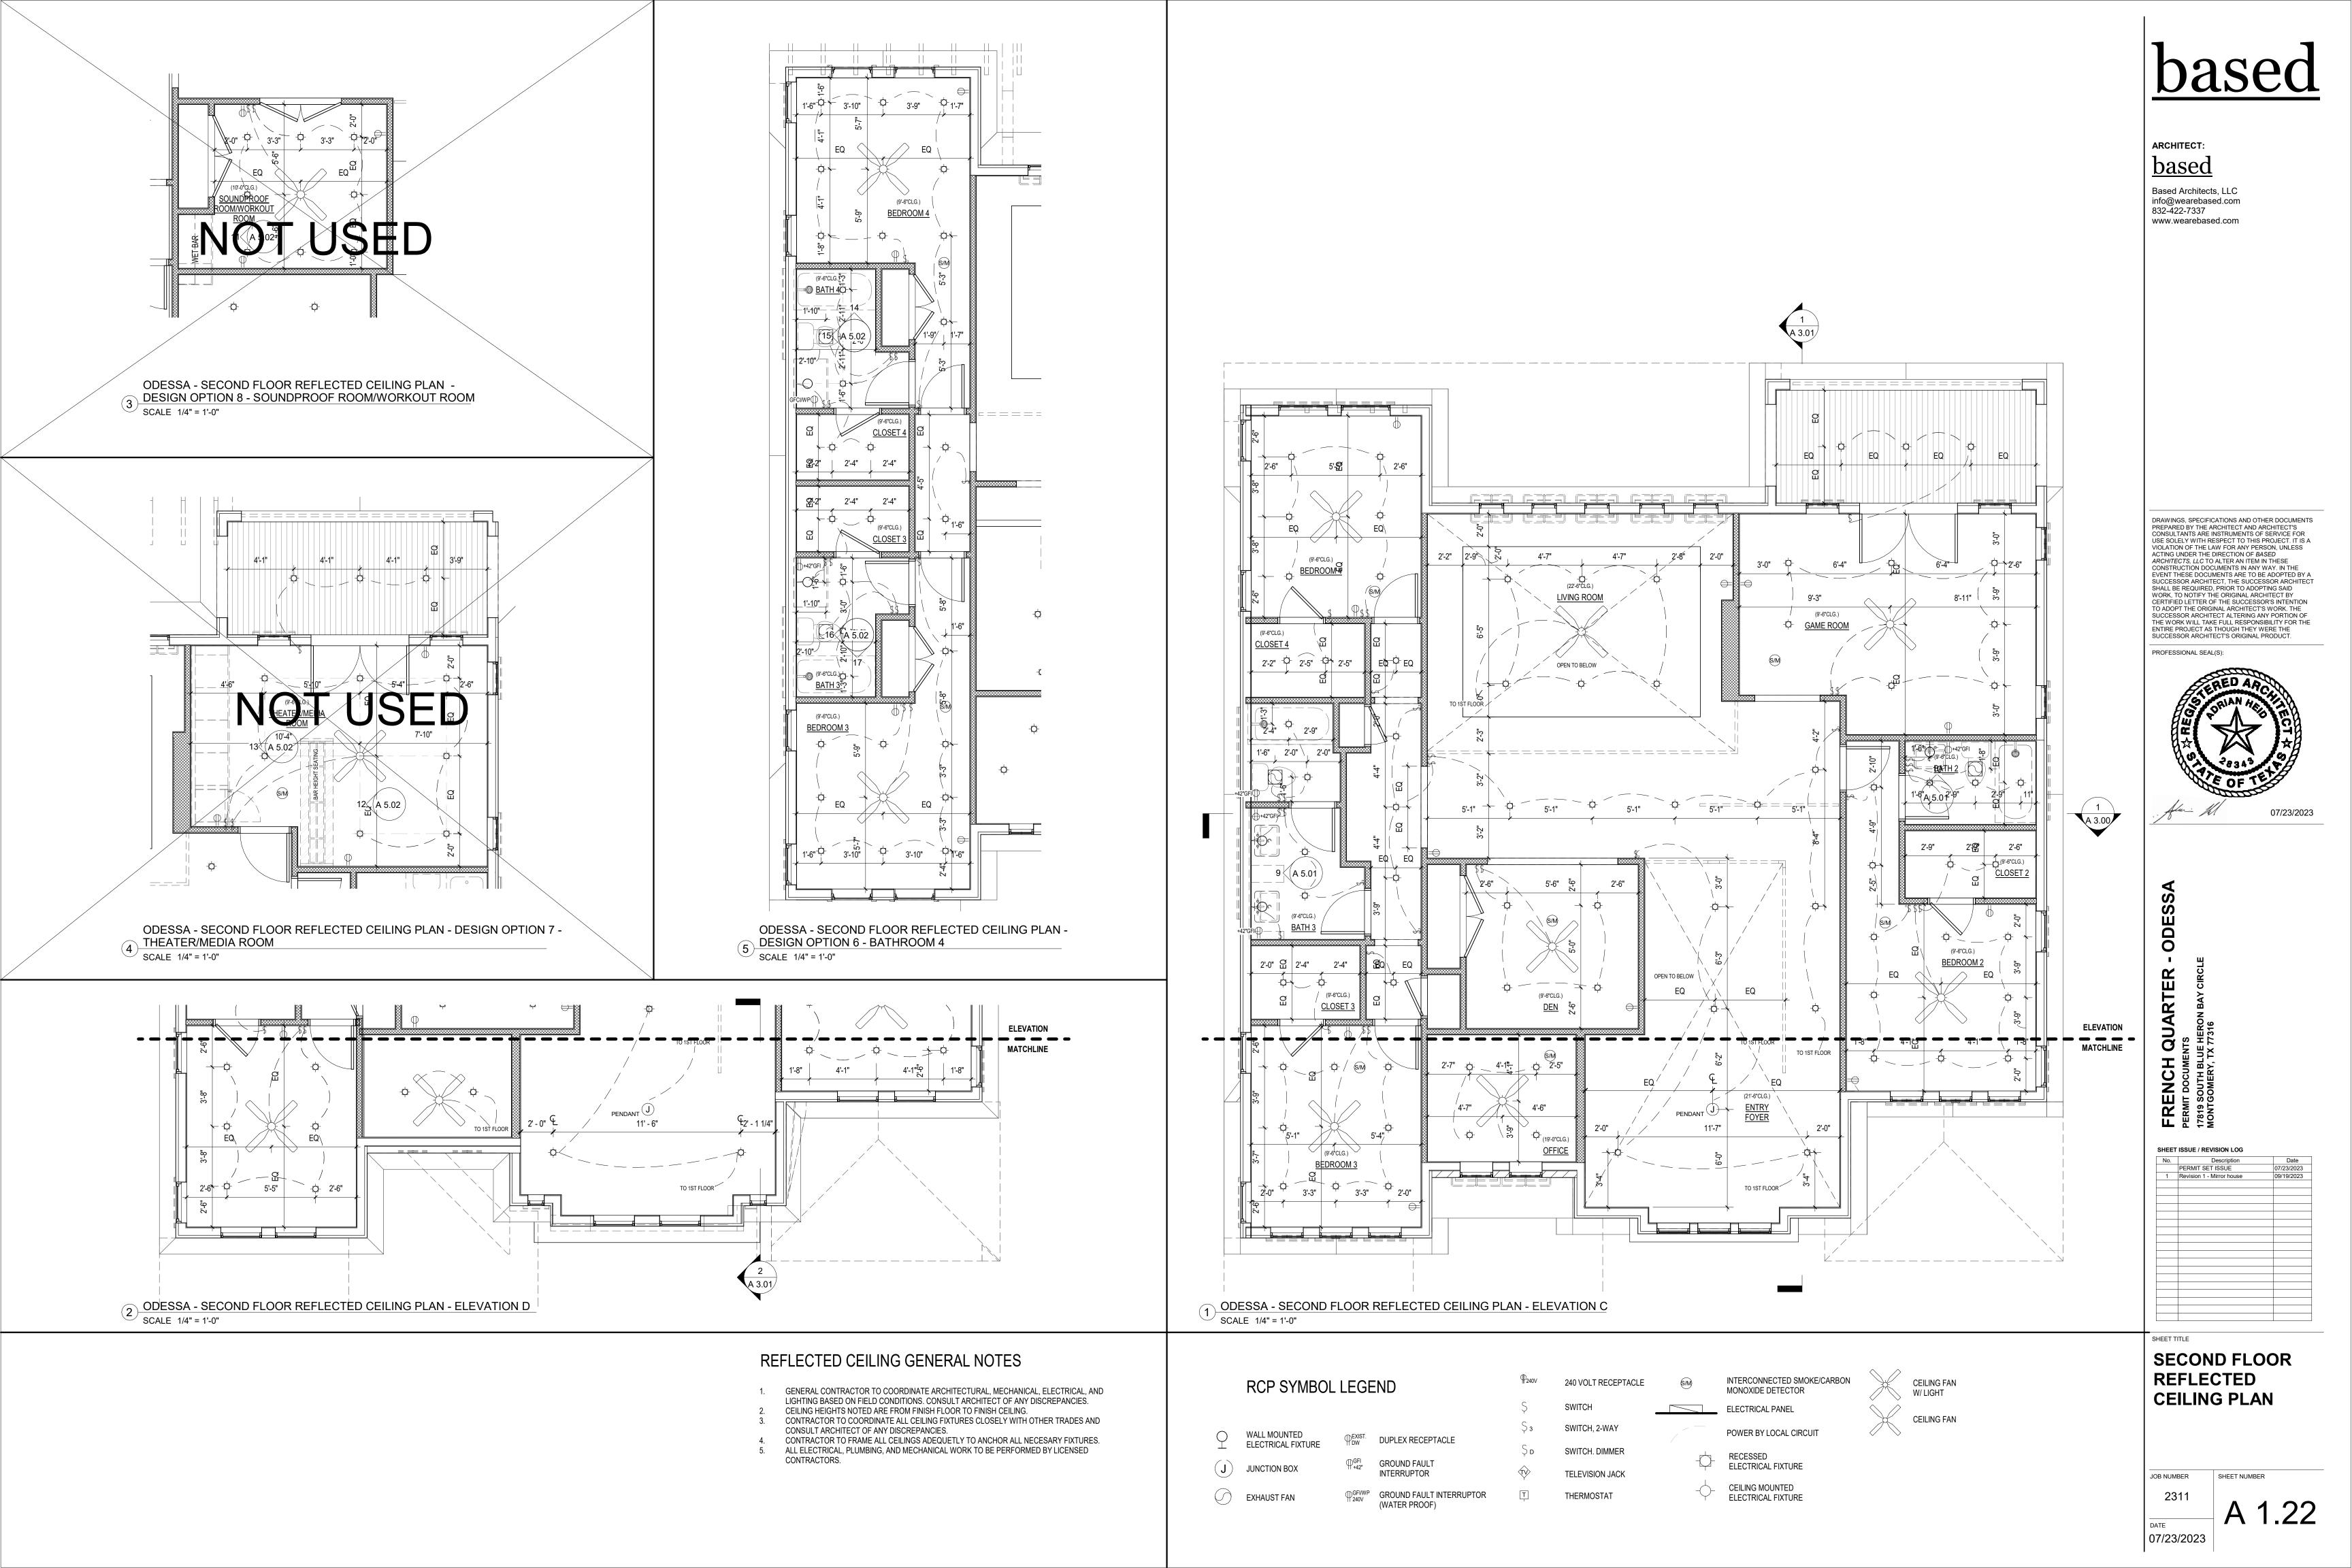

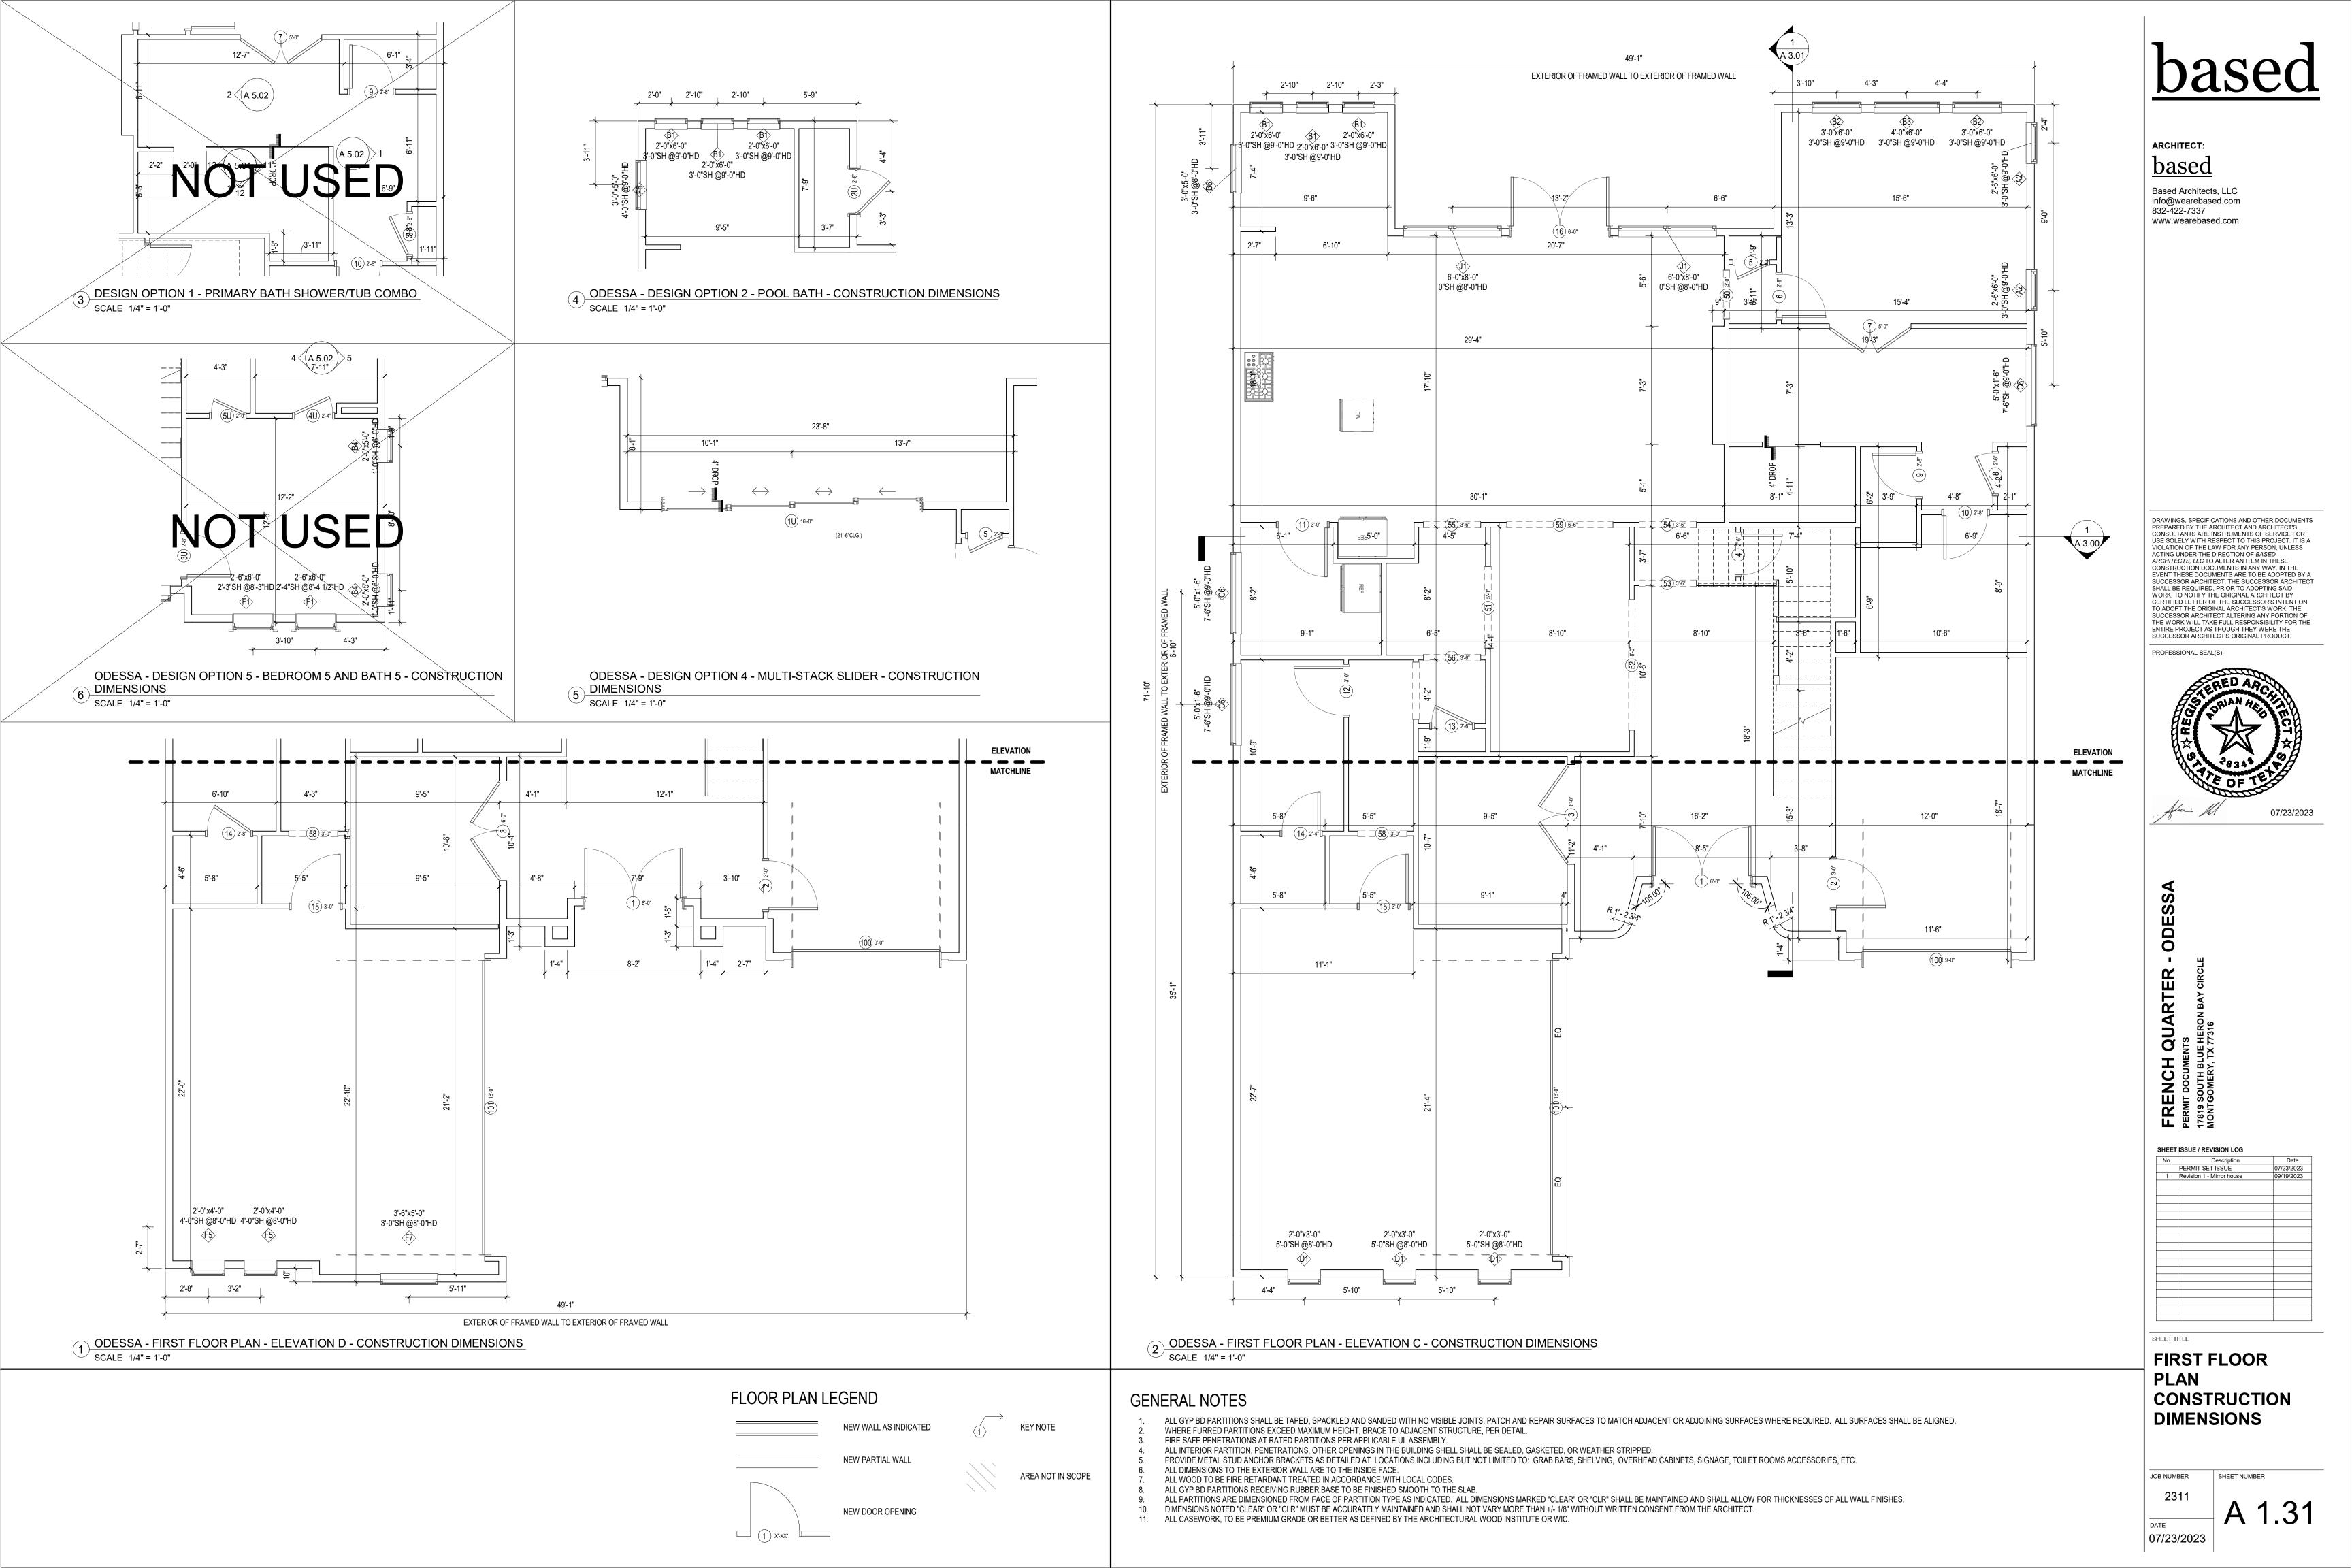

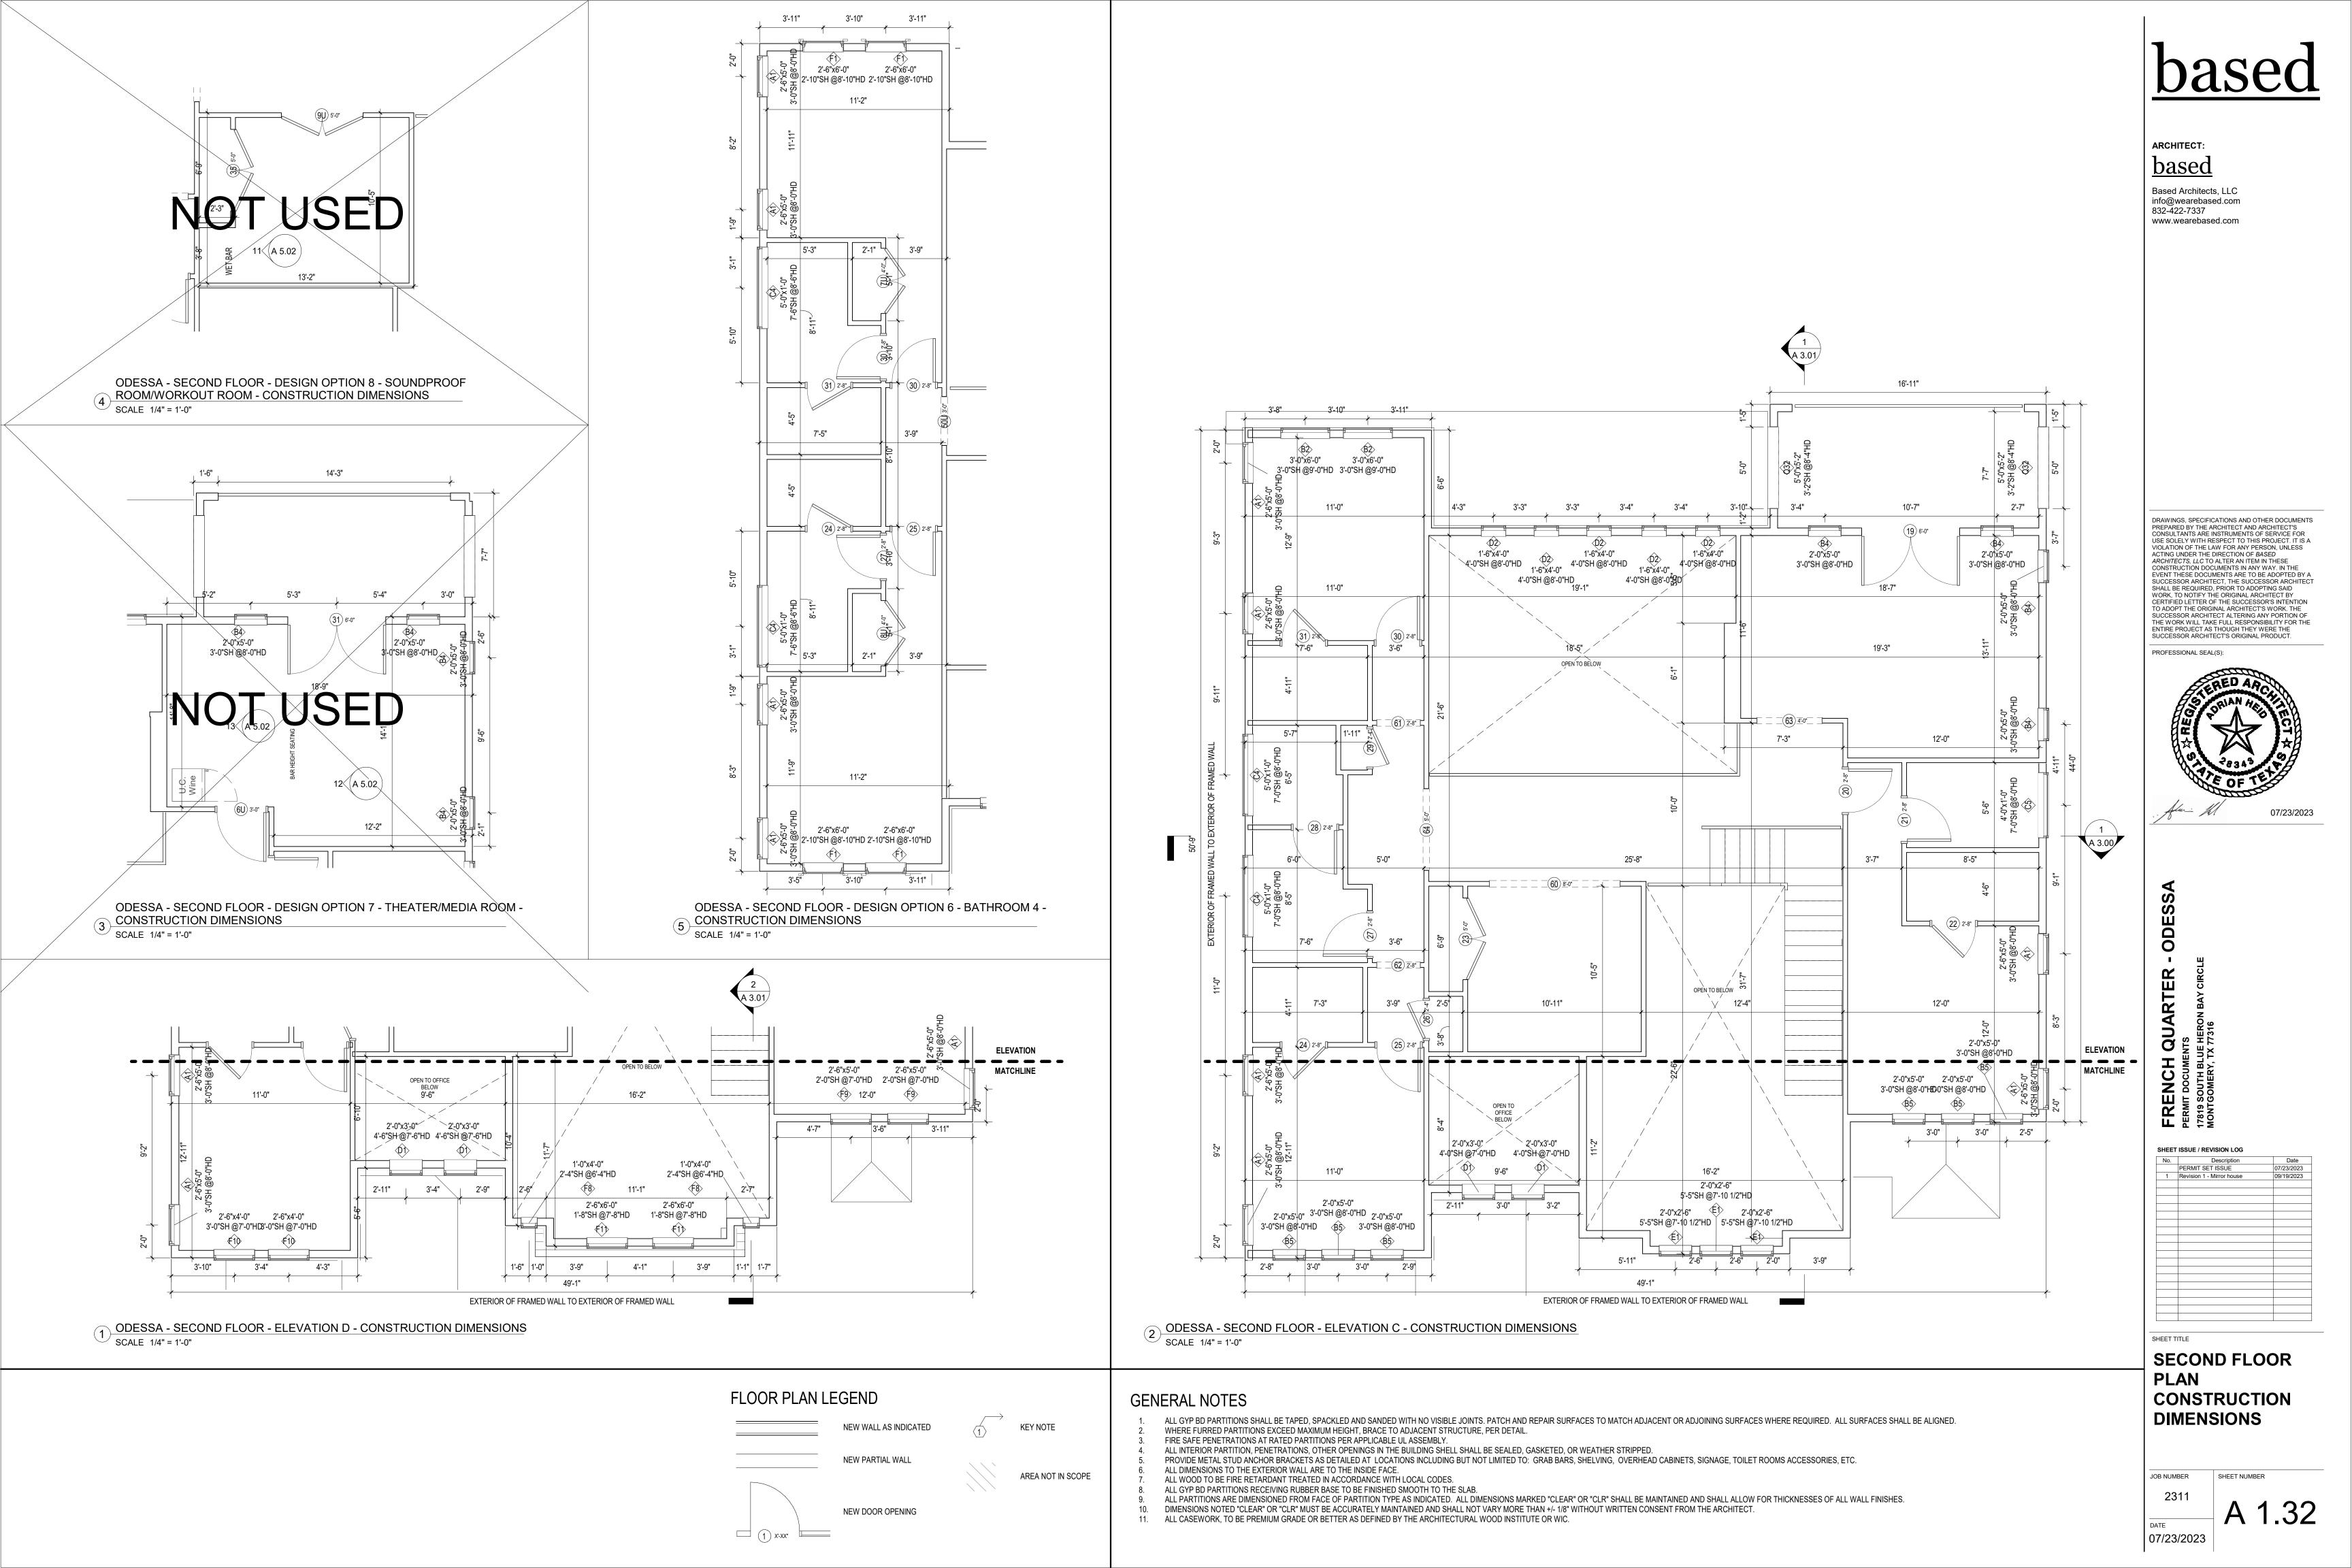


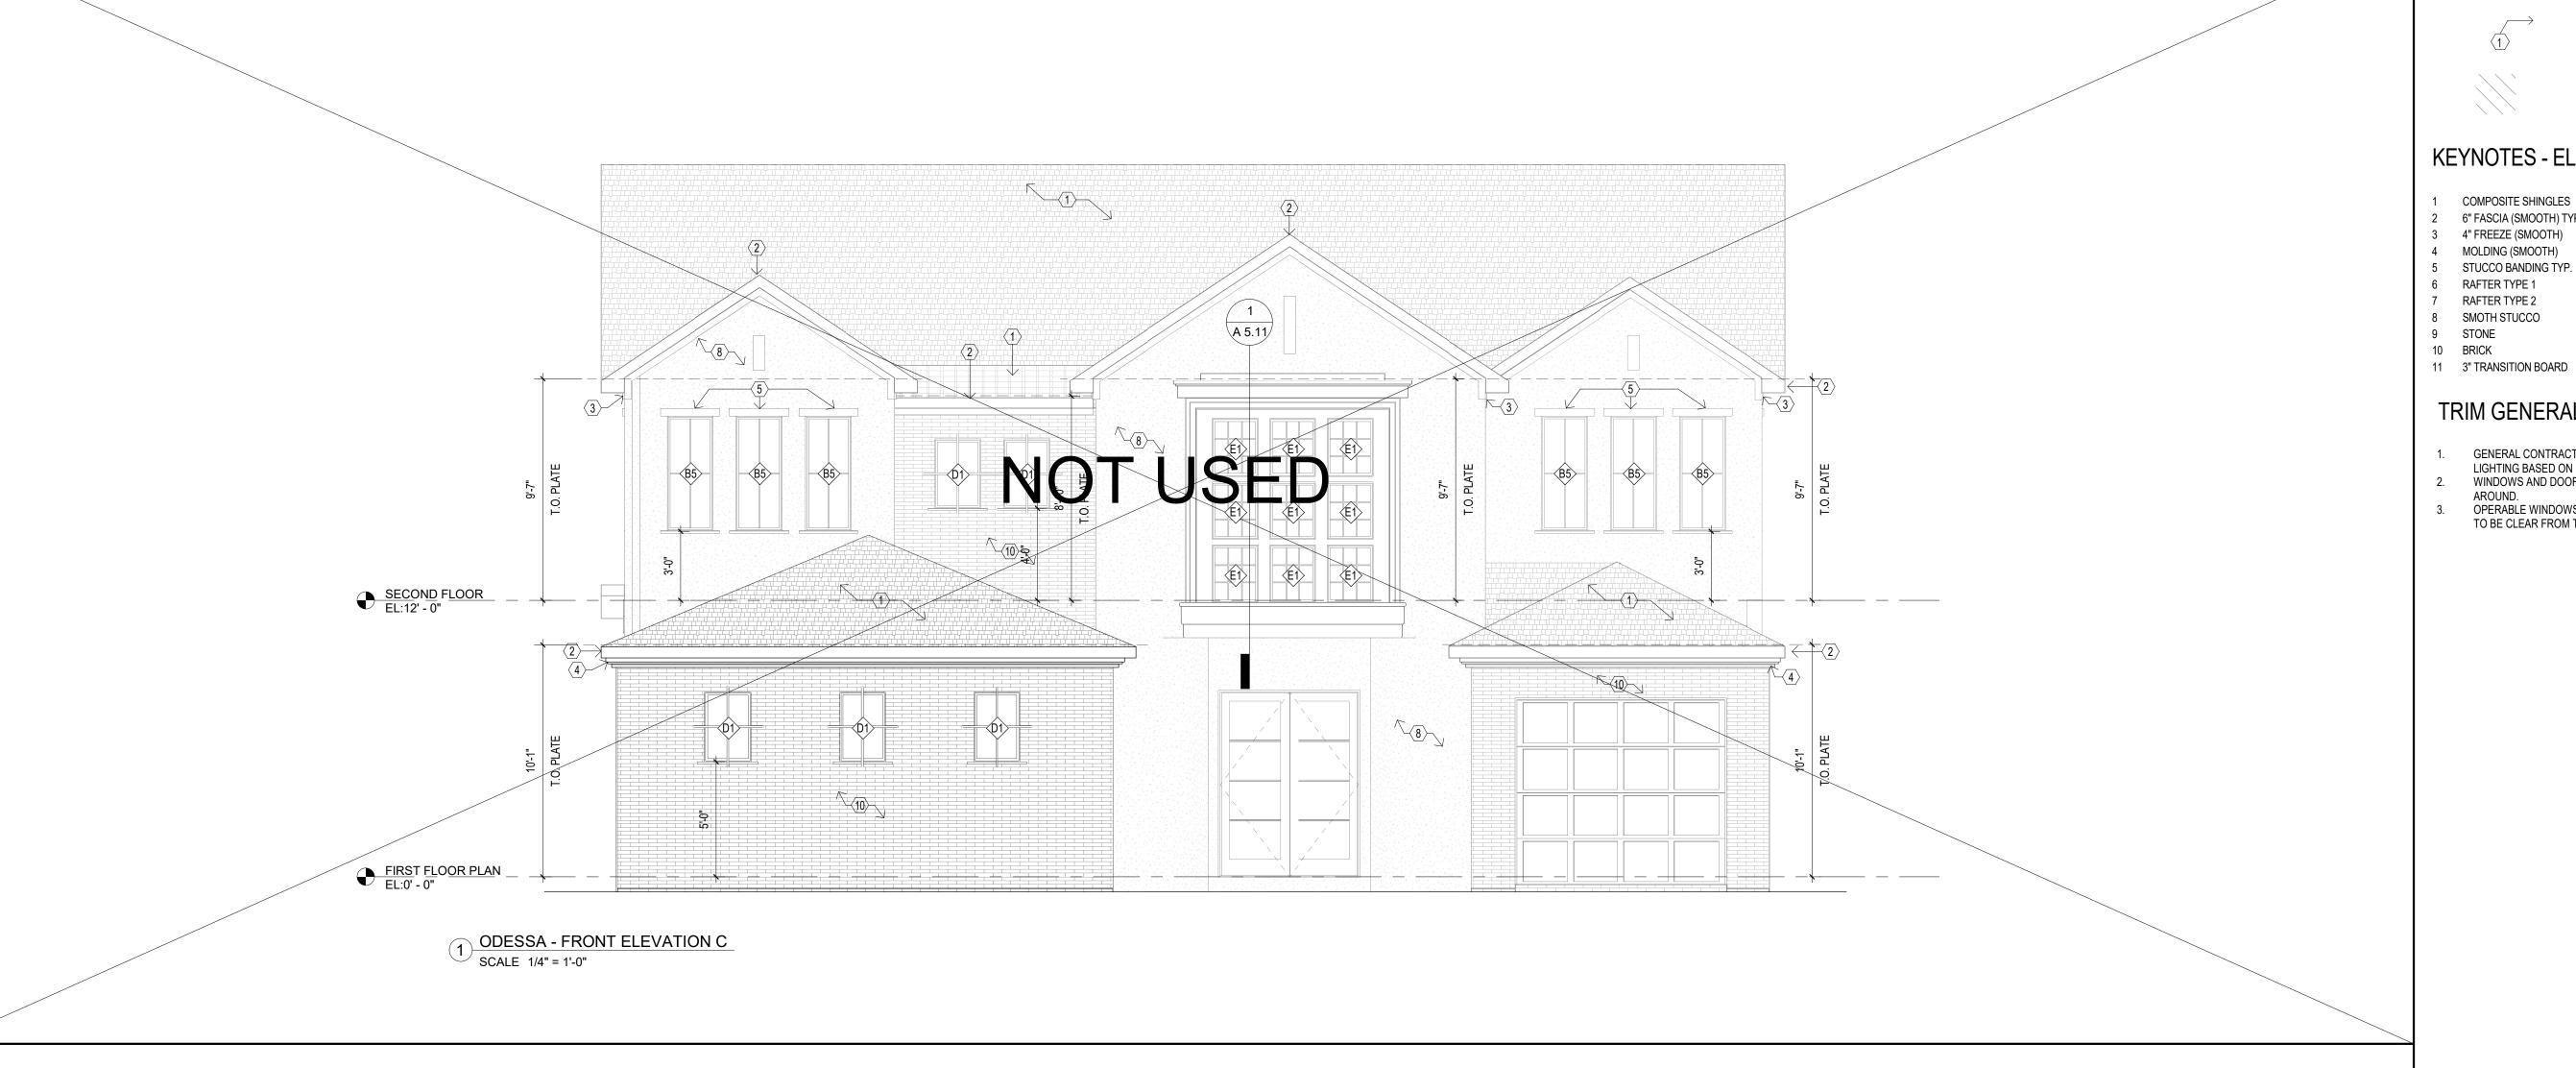

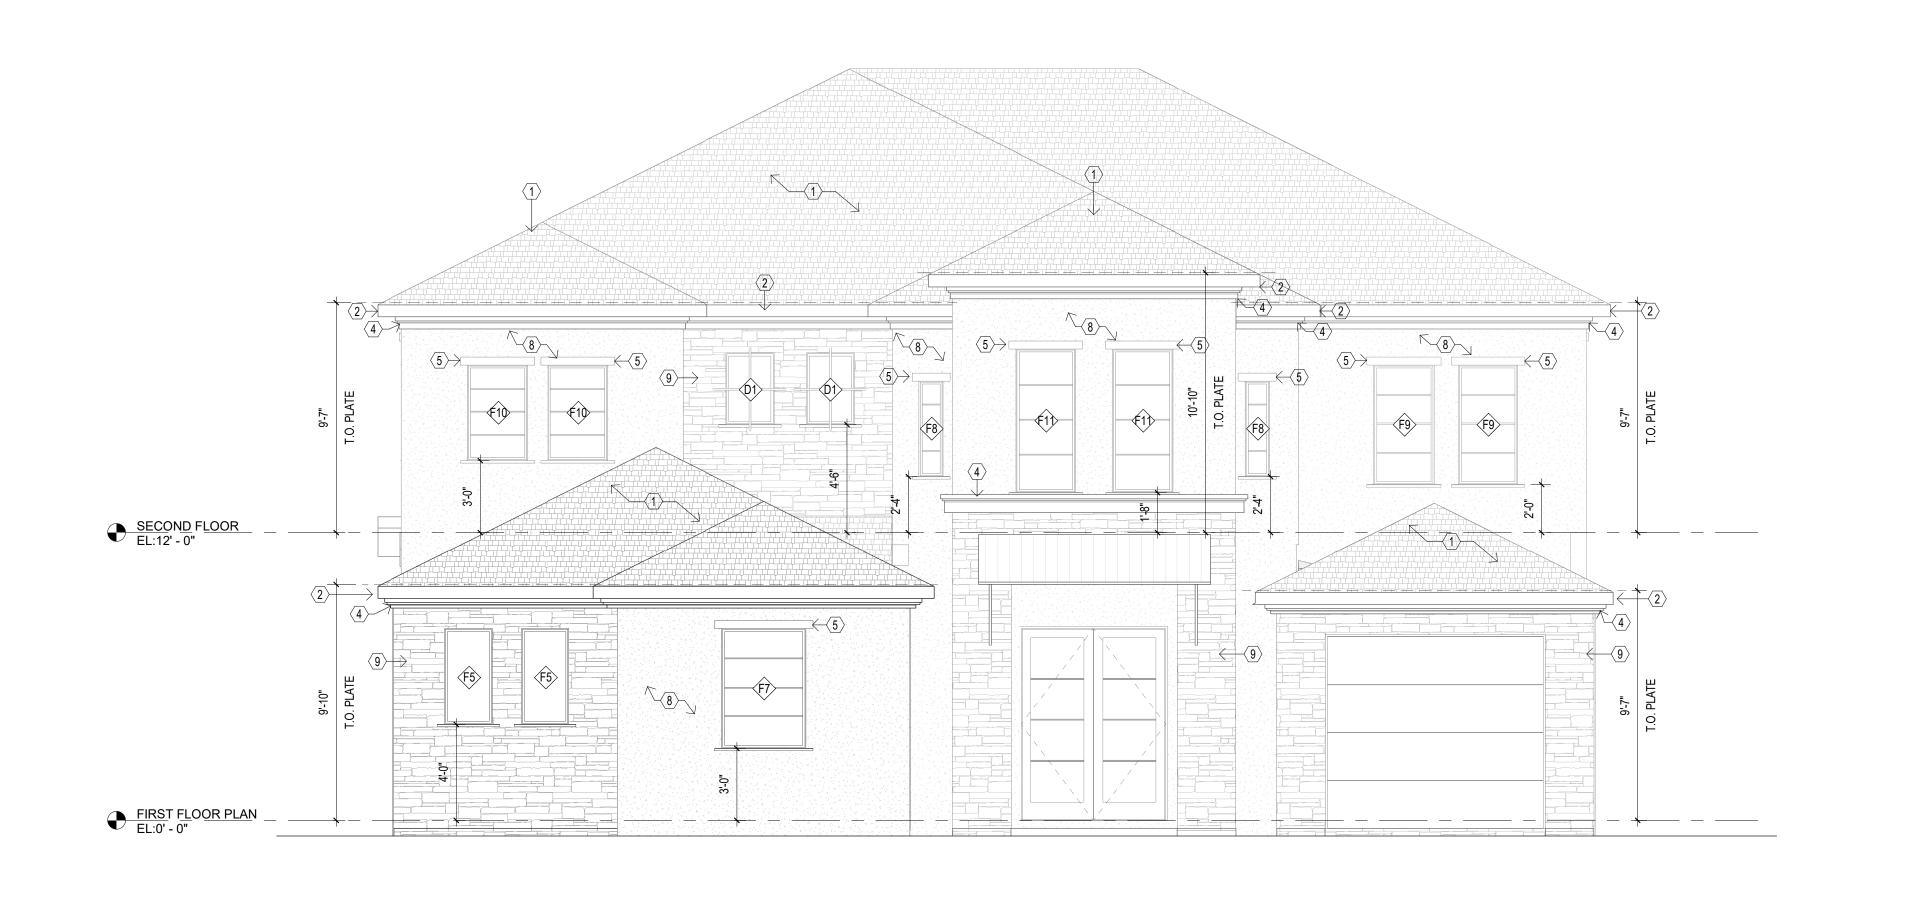


2 ODESSA - FRONT ELEVATION D
SCALE 1/4" = 1'-0"

LEGEND

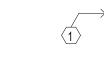



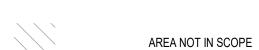

KEYNOTES - ELEVATIONS

- 1 COMPOSITE SHINGLES
- 2 6" FASCIA (SMOOTH) TYP. 3 4" FREEZE (SMOOTH)
- 4 MOLDING (SMOOTH) 5 STUCCO BANDING TYP.
- 6 RAFTER TYPE 1 7 RAFTER TYPE 2
- 8 SMOTH STUCCO
- 9 STONE 10 BRICK

TRIM GENERAL NOTES

- GENERAL CONTRACTOR TO COORDINATE ARCHITECTURAL, MECHANICAL, ELECTRICAL, AND
- LIGHTING BASED ON FIELD CONDITIONS. CONSULT ARCHITECT OF ANY DISCREPANCIES. WINDOWS AND DOORS INSTALLED OVER ANY TYPE OF SIDING TO RECEIVE A 3" SMOOTH TRIM ALL
- OPERABLE WINDOWS TO RECEIVE A SLOPED SILL. ALL WEEP HOLES IN THE WINDOW ASSEMBLY TO BE CLEAR FROM THE SILL.

ARCHITECT: <u>based</u>


Based Architects, LLC info@wearebased.com 832-422-7337 www.wearebased.com

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PROFESSIONAL SEAL(S):




ODESSA FRENCH QUARTER PERMIT DOCUMENTS
17819 SOUTH BLUE HERON BAY CIRCLE
MONTGOMERY, TX 77316

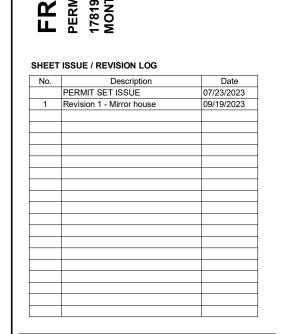

EXTERIOR ELEVATIONS

JOB NUMBER SHEET NUMBER

DATE 07/23/2023

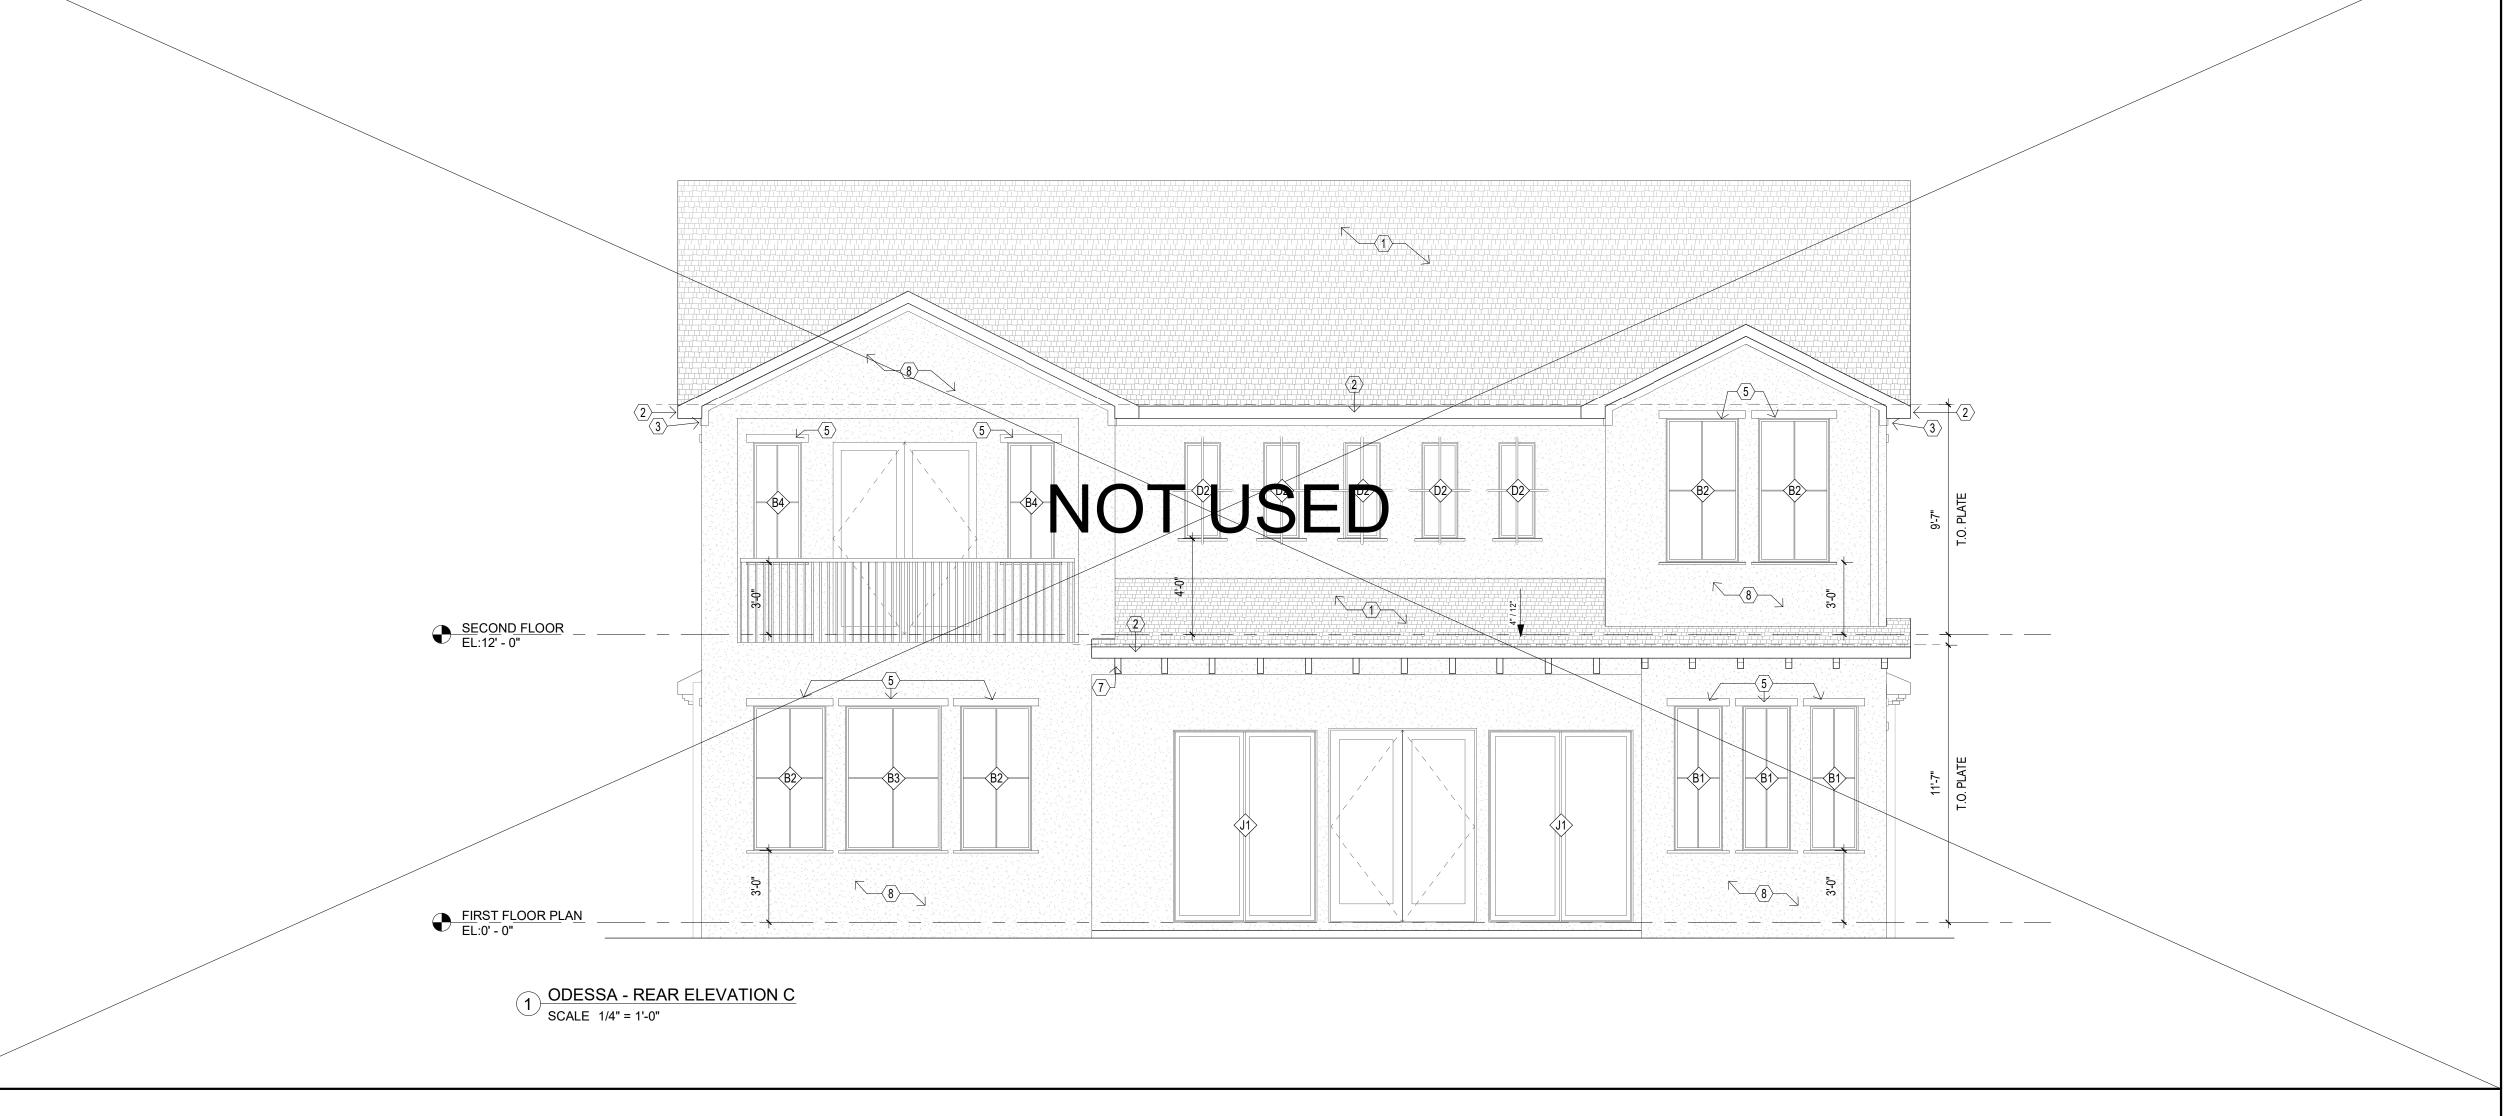




LEGEND





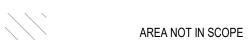

KEYNOTES - ELEVATIONS

- COMPOSITE SHINGLES
 6" FASCIA (SMOOTH) TYP.
- 2 6" FASCIA (SMOOTH) T 3 4" FREEZE (SMOOTH)
- 4 MOLDING (SMOOTH)
 5 STUCCO BANDING TYP.
- 6 RAFTER TYPE 1 7 RAFTER TYPE 2
- 8 SMOTH STUCCO9 STONE
- 10 BRICK11 3" TRANSITION BOARD

TRIM GENERAL NOTES

- 1. GENERAL CONTRACTOR TO COORDINATE ARCHITECTURAL, MECHANICAL, ELECTRICAL, AND
- LIGHTING BASED ON FIELD CONDITIONS. CONSULT ARCHITECT OF ANY DISCREPANCIES.

 2. WINDOWS AND DOORS INSTALLED OVER ANY TYPE OF SIDING TO RECEIVE A 3" SMOOTH TRIM ALL
- OPERABLE WINDOWS TO RECEIVE A SLOPED SILL. ALL WEEP HOLES IN THE WINDOW ASSEMBLY TO BE CLEAR FROM THE SILL.



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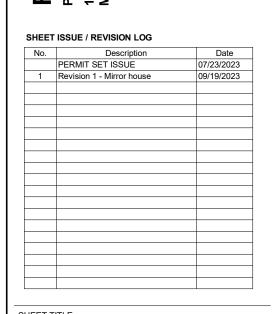
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PROFESSIONAL SEAL(S):



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17819 SOUTH BLUE HERON BAY CIRCLE
MONTGOMERY, TX 77316



EXTERIOR ELEVATIONS


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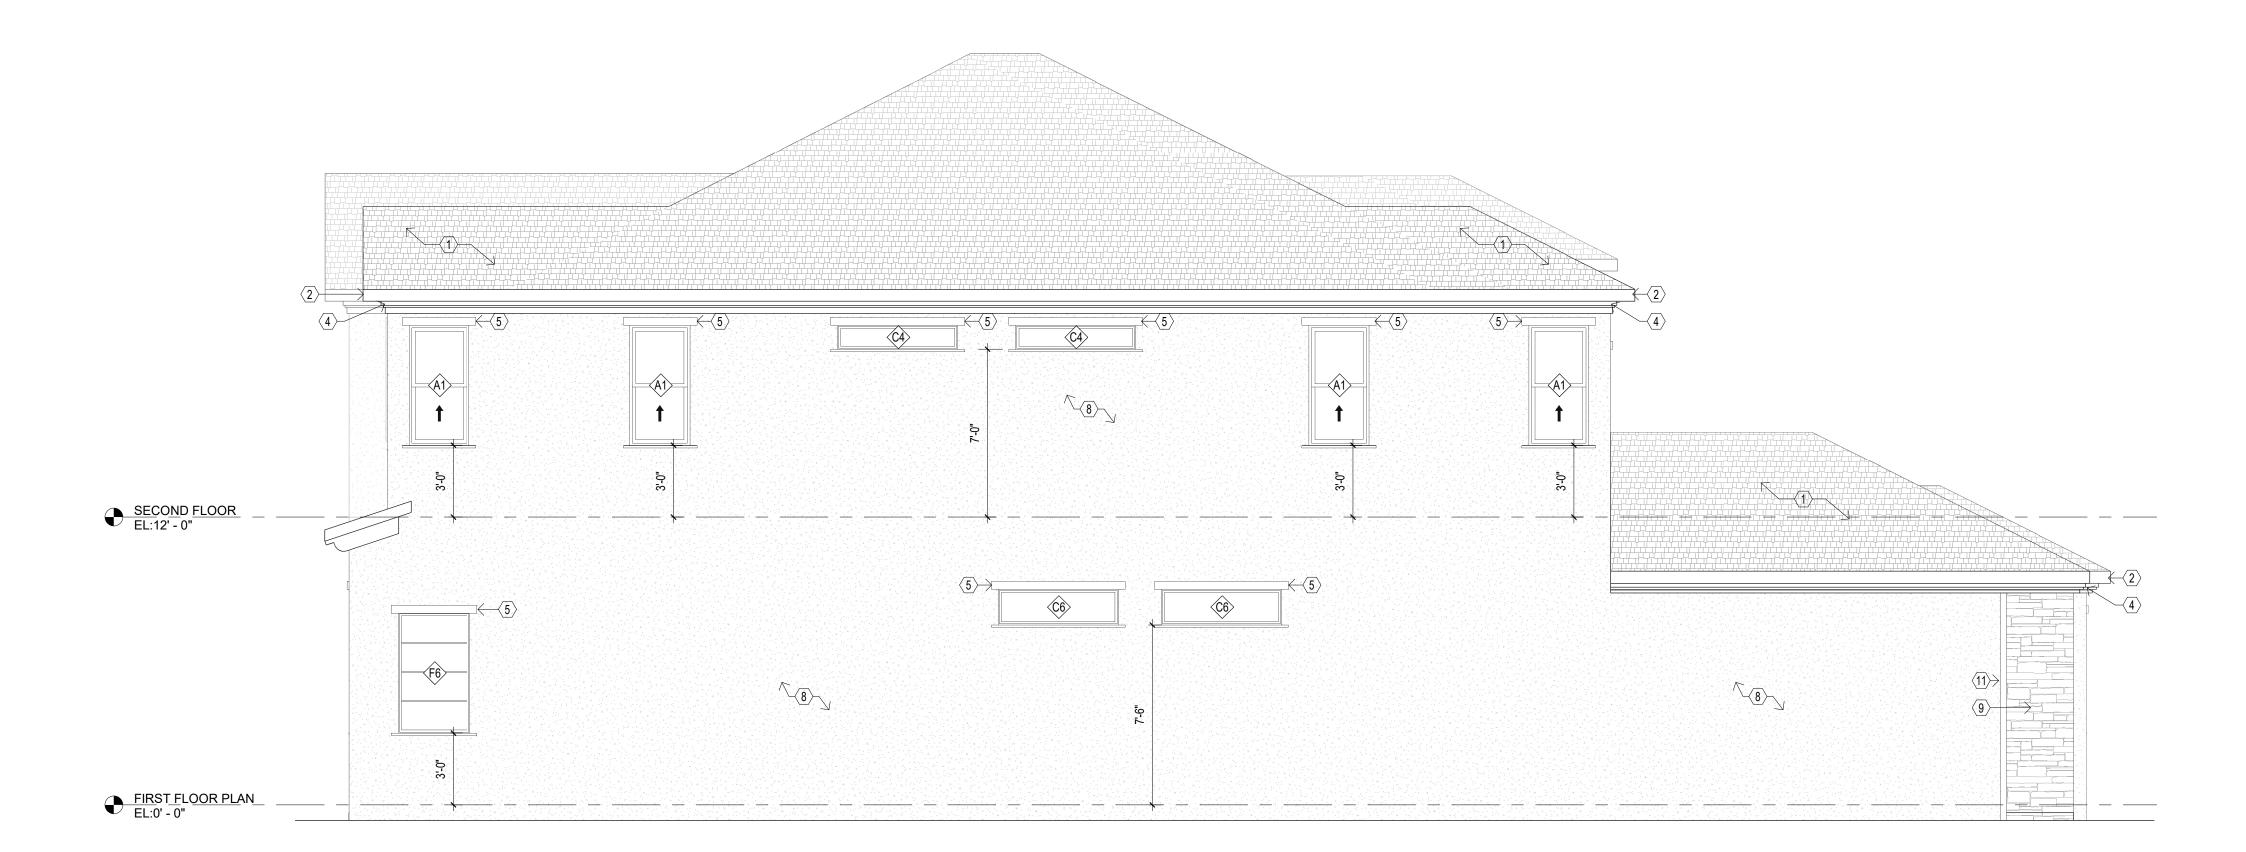
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DATE
07/23/2023

SHEET NUMBER

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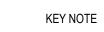




2 ODESSA - ELEVATION D - RIGHT ELEVATION SCALE 1/4" = 1'-0"

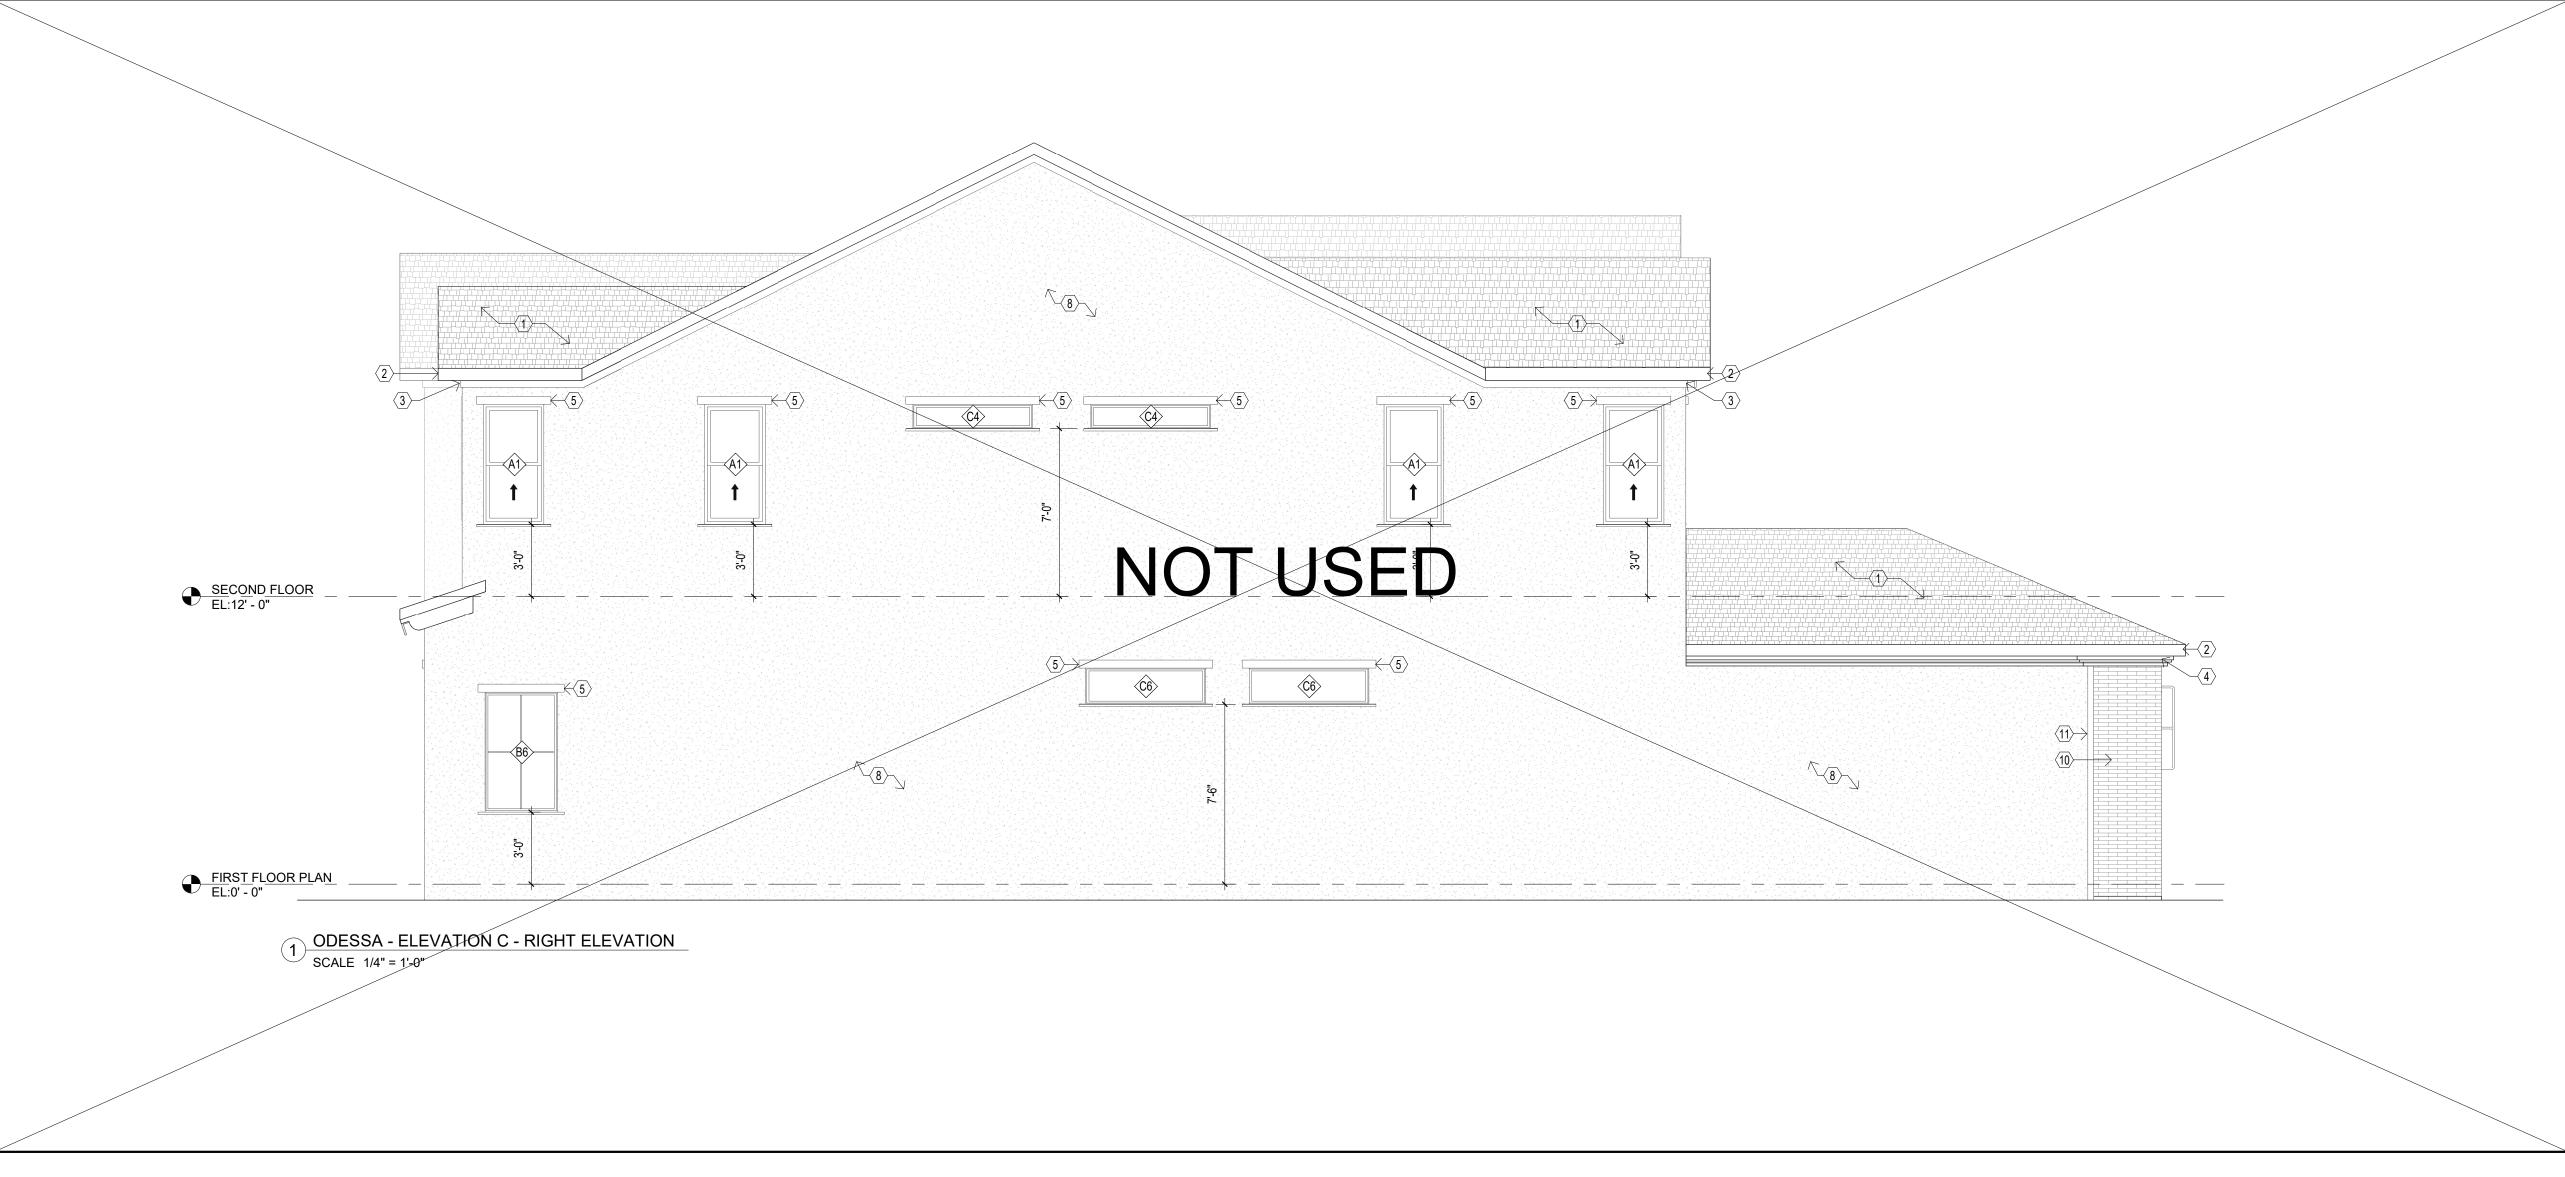LEGEND







KEYNOTES - ELEVATIONS

- 1 COMPOSITE SHINGLES
 2 6" FASCIA (SMOOTH) TYP
- 2 6" FASCIA (SMOOTH) TYP. 3 4" FREEZE (SMOOTH)
- 4 MOLDING (SMOOTH)5 STUCCO BANDING TYP.
- 6 RAFTER TYPE 1 7 RAFTER TYPE 2
- 8 SMOTH STUCCO 9 STONE
- 10 BRICK11 3" TRANSITION BOARD

TRIM GENERAL NOTES

- 1. GENERAL CONTRACTOR TO COORDINATE ARCHITECTURAL, MECHANICAL, ELECTRICAL, AND LIGHTING BASED ON FIELD CONDITIONS. CONSULT ARCHITECT OF ANY DISCREPANCIES.
- 2. WINDOWS AND DOORS INSTALLED OVER ANY TYPE OF SIDING TO RECEIVE A 3" SMOOTH TRIM ALL
- 3. OPERABLE WINDOWS TO RECEIVE A SLOPED SILL. ALL WEEP HOLES IN THE WINDOW ASSEMBLY TO BE CLEAR FROM THE SILL.



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MONTGOMERY, TX 77316

No.	Description	Date
	PERMIT SET ISSUE	07/23/2023
1	Revision 1 - Mirror house	09/19/2023


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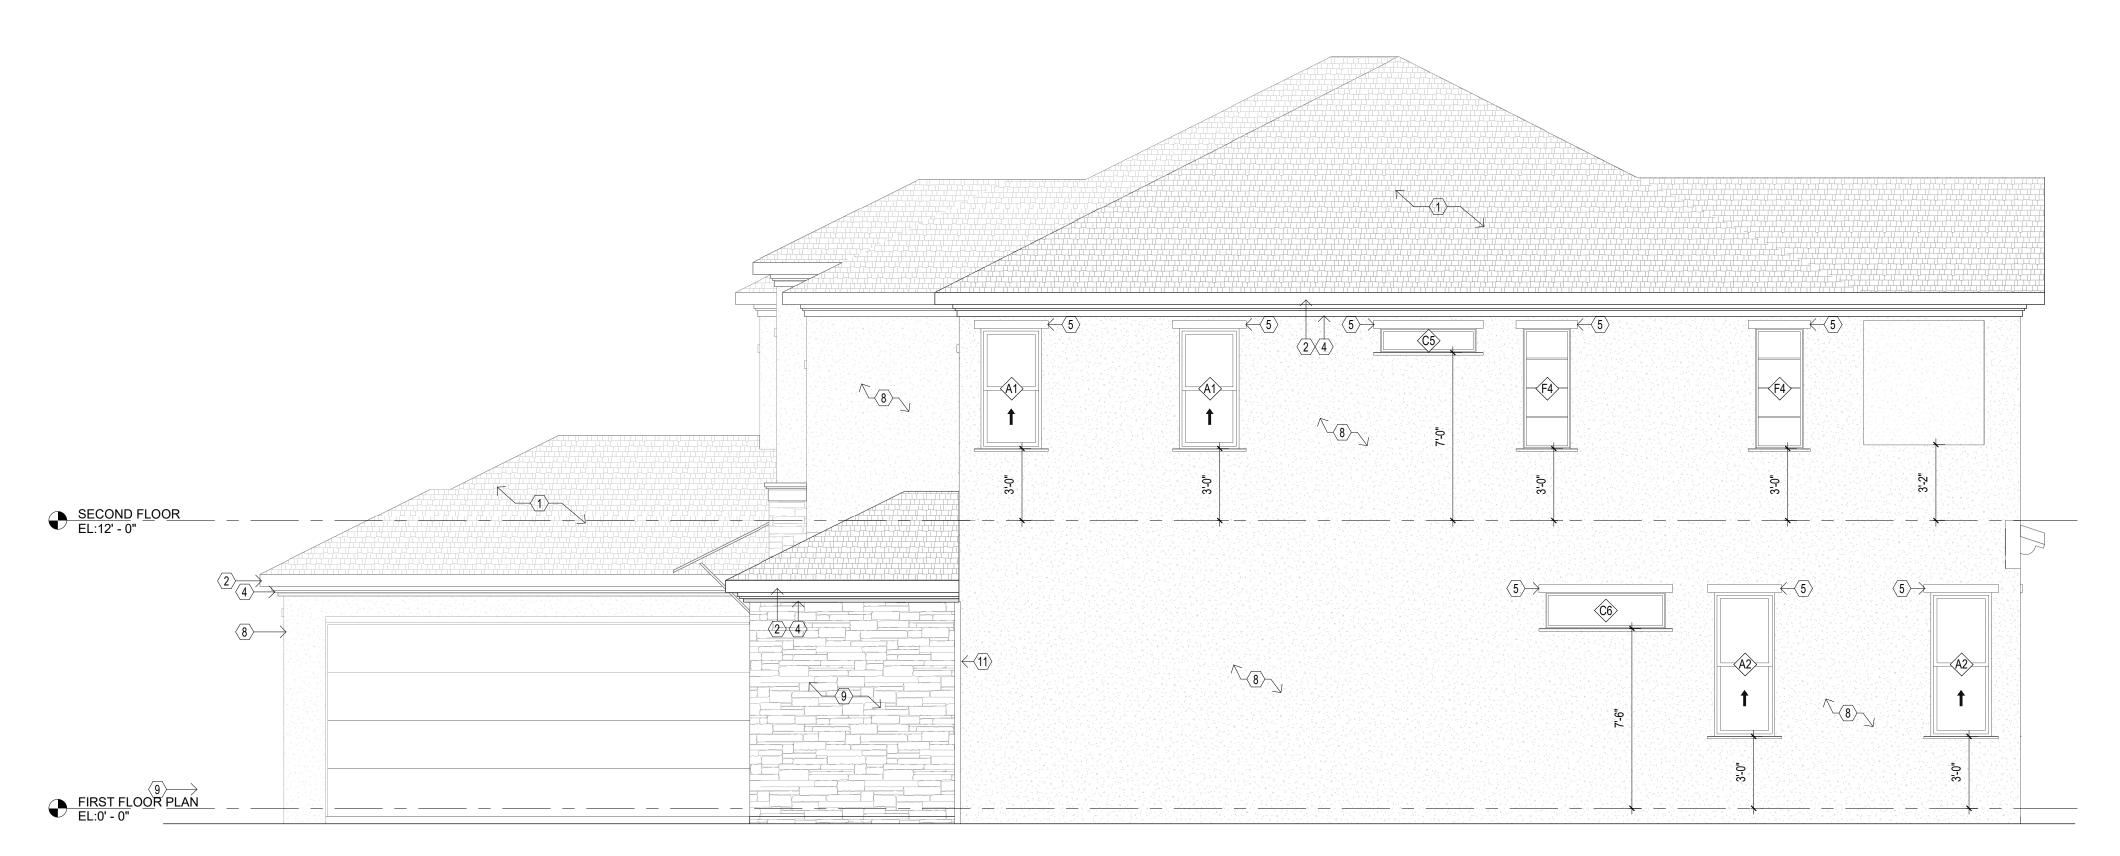
JOB NUMBER SHEET NUMBER

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DATE A 2.0





ODESSA - ELEVATION D - LEFT ELEVATION

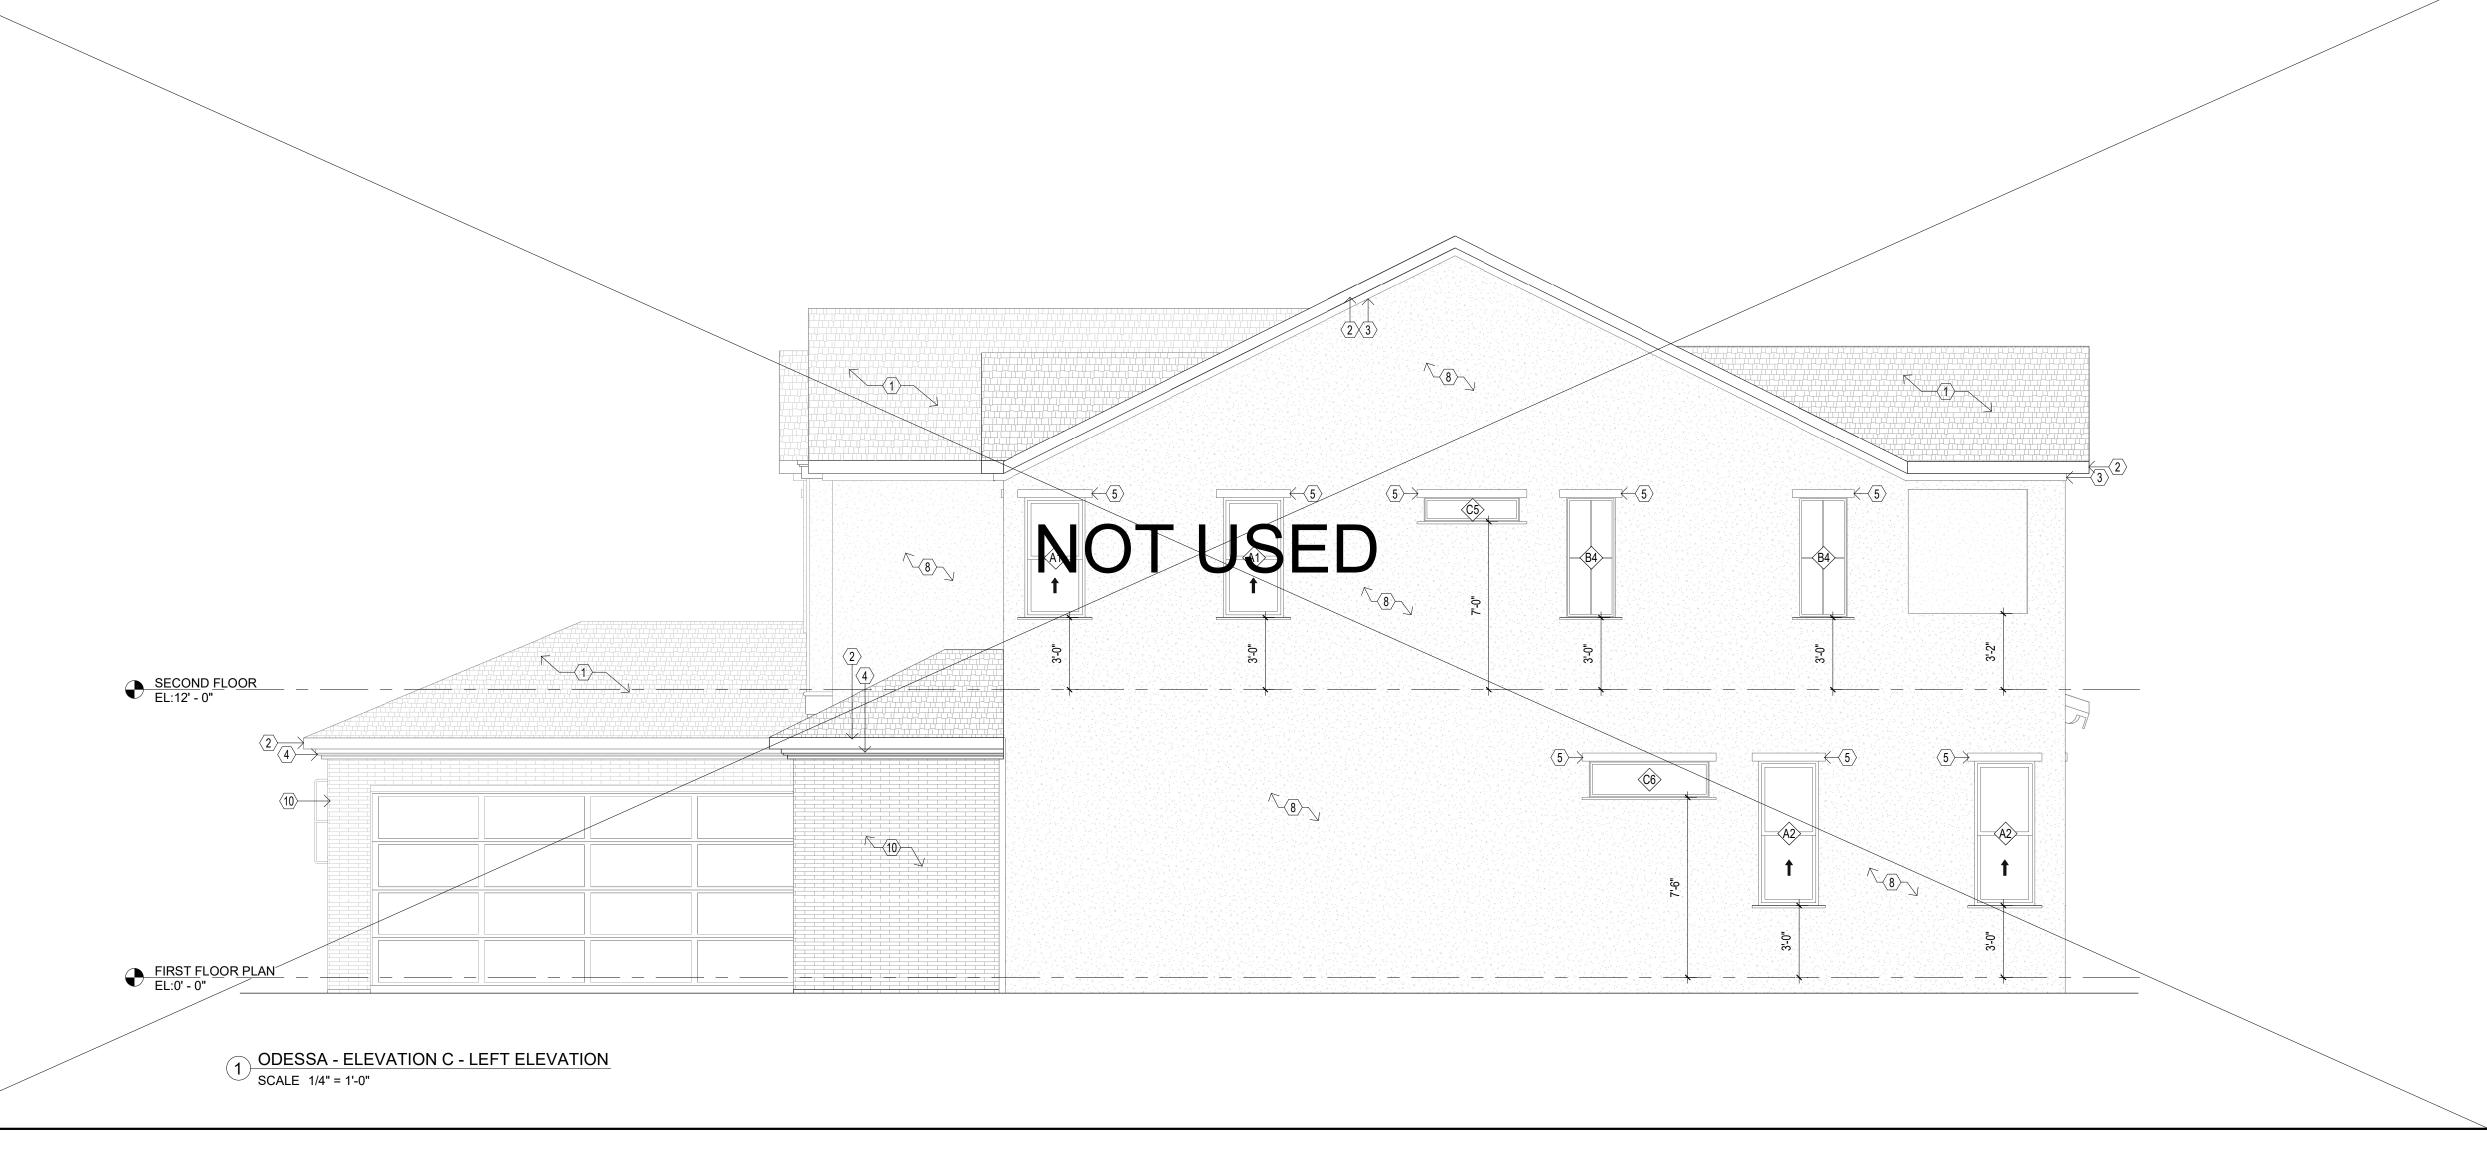SCALE 1/4" = 1'-0"

LEGEND







KEYNOTES - ELEVATIONS

- 1 COMPOSITE SHINGLES
- 2 6" FASCIA (SMOOTH) TYP. 3 4" FREEZE (SMOOTH)
- 4 MOLDING (SMOOTH) 5 STUCCO BANDING TYP.
- 6 RAFTER TYPE 1
- 7 RAFTER TYPE 2 8 SMOTH STUCCO
- 9 STONE 10 BRICK
- 11 3" TRANSITION BOARD

TRIM GENERAL NOTES

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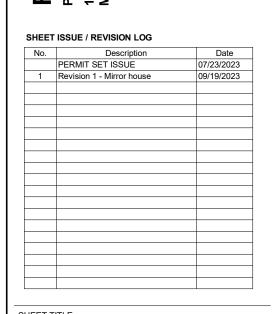
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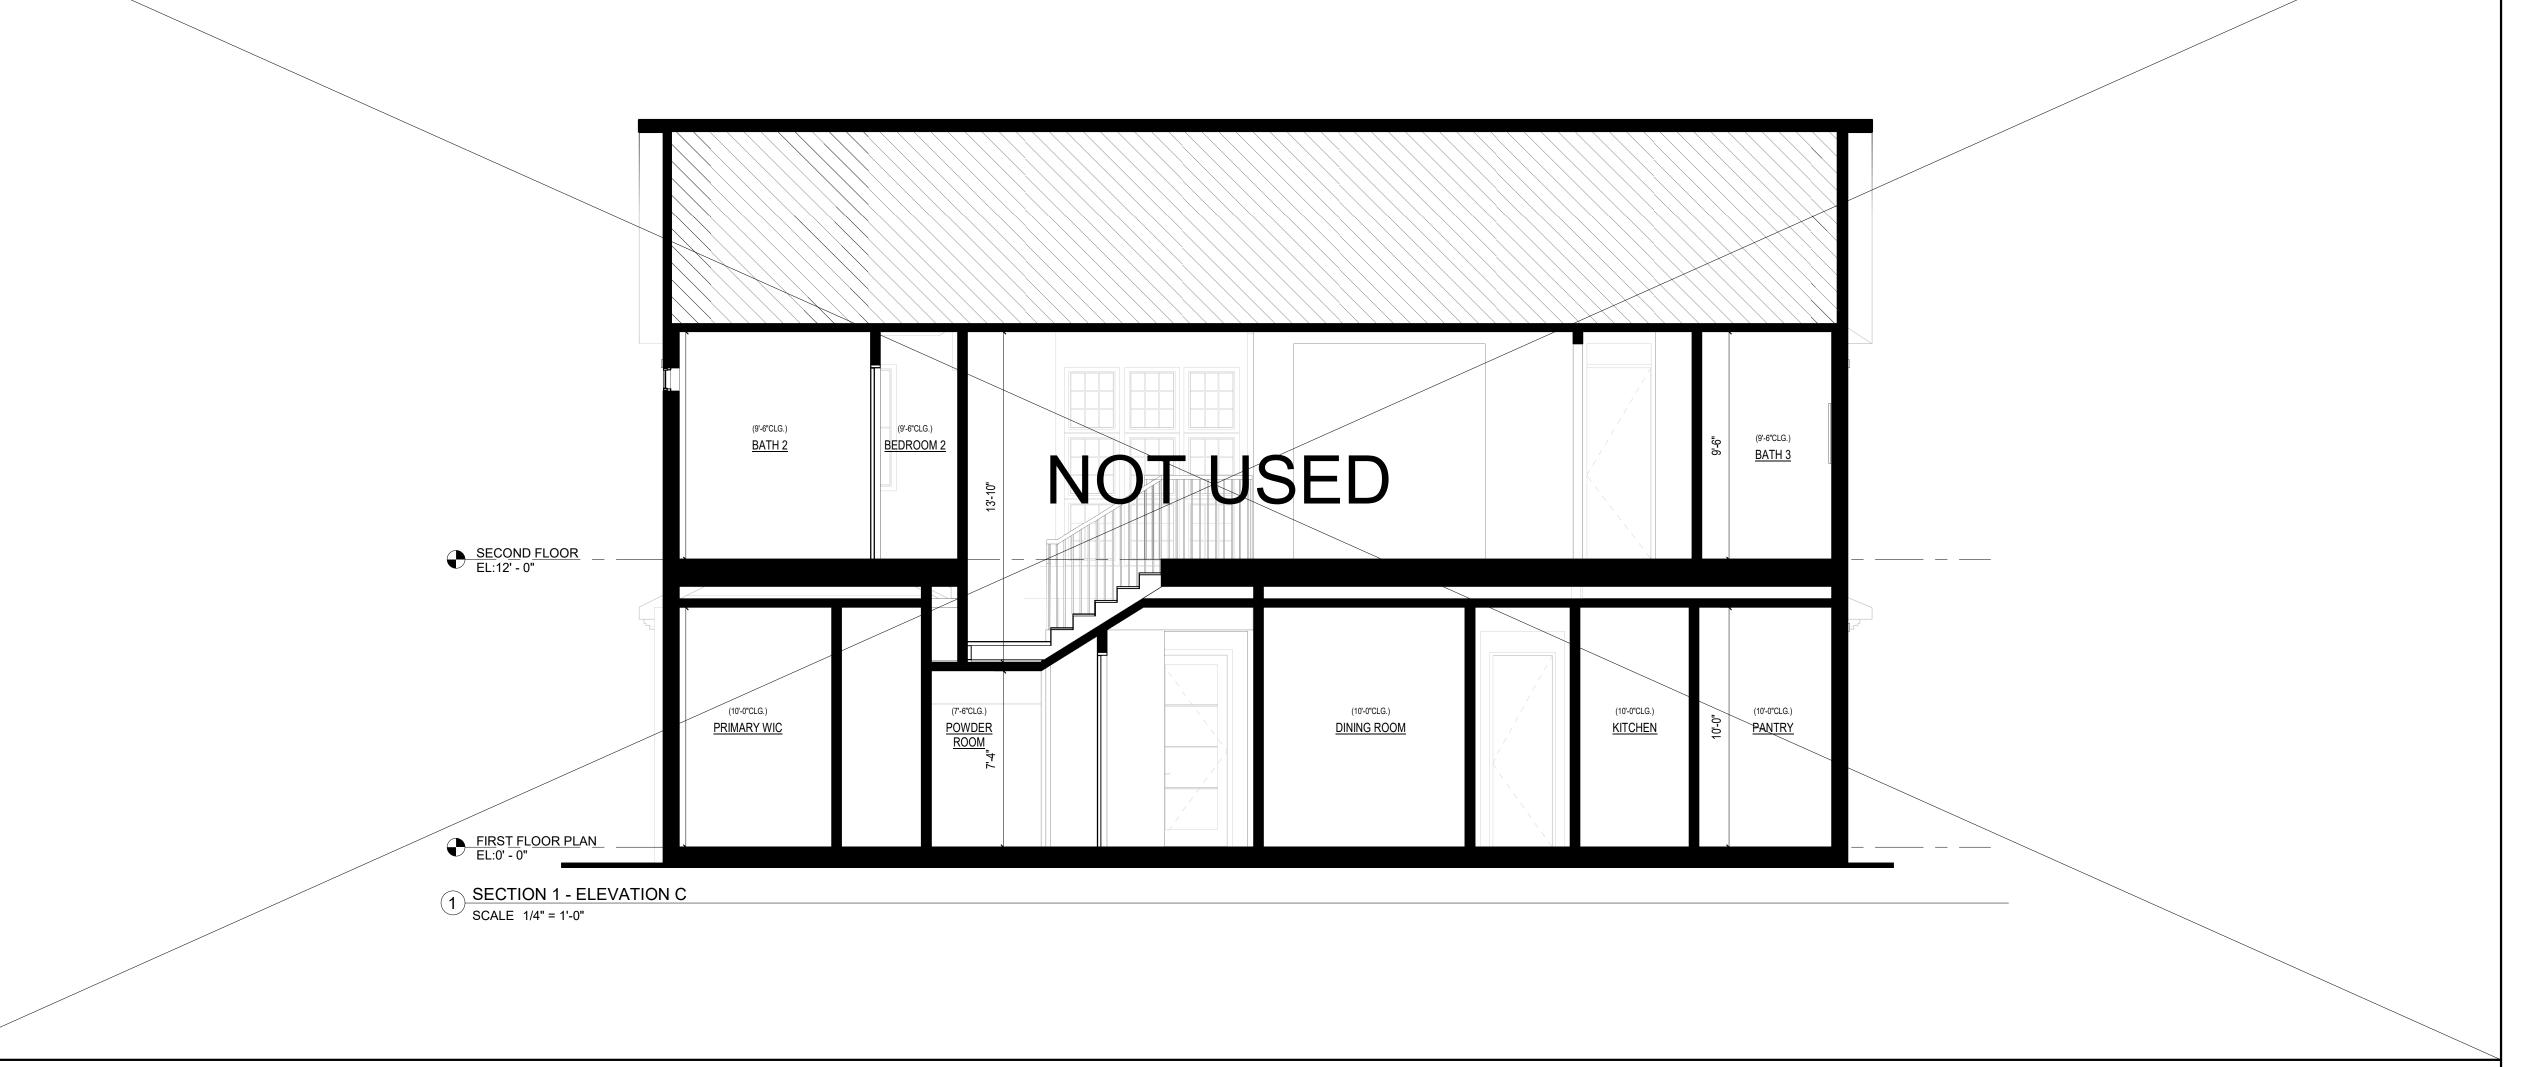



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MONTGOMERY, TX 77316




EXTERIOR ELEVATIONS

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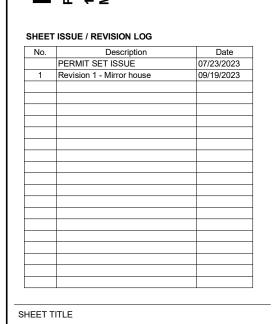
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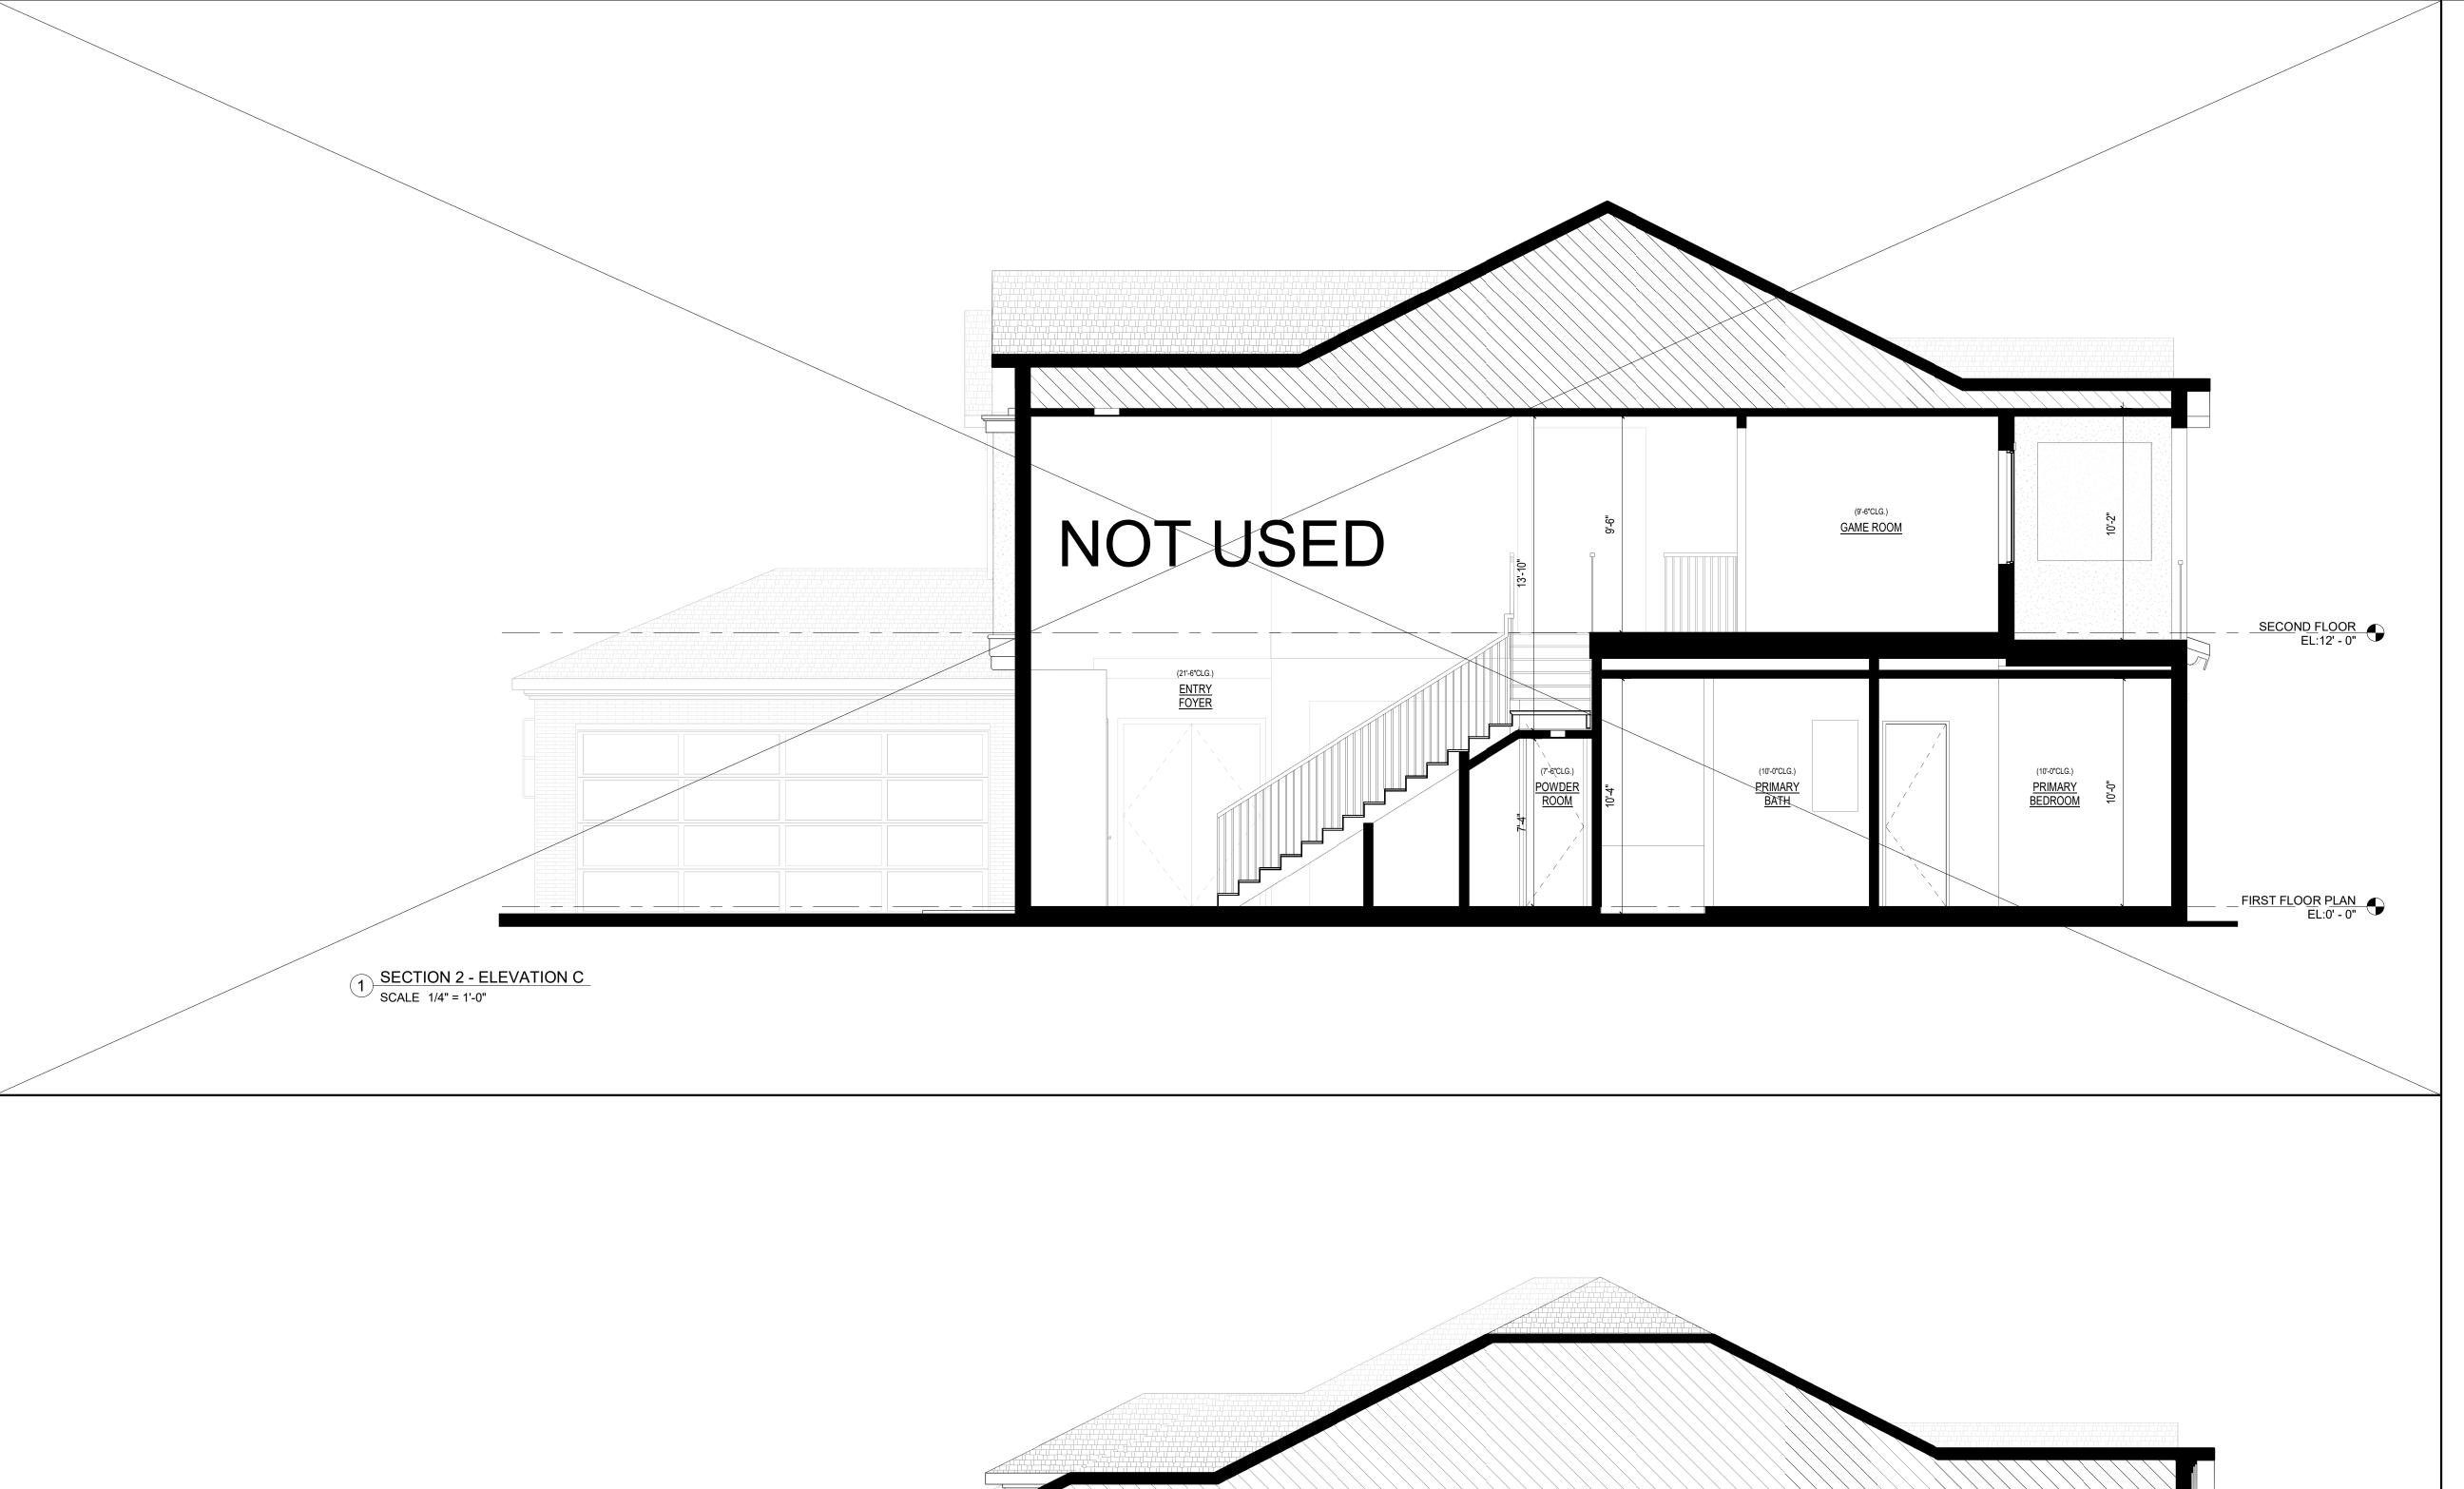



BUILDING SECTIONS

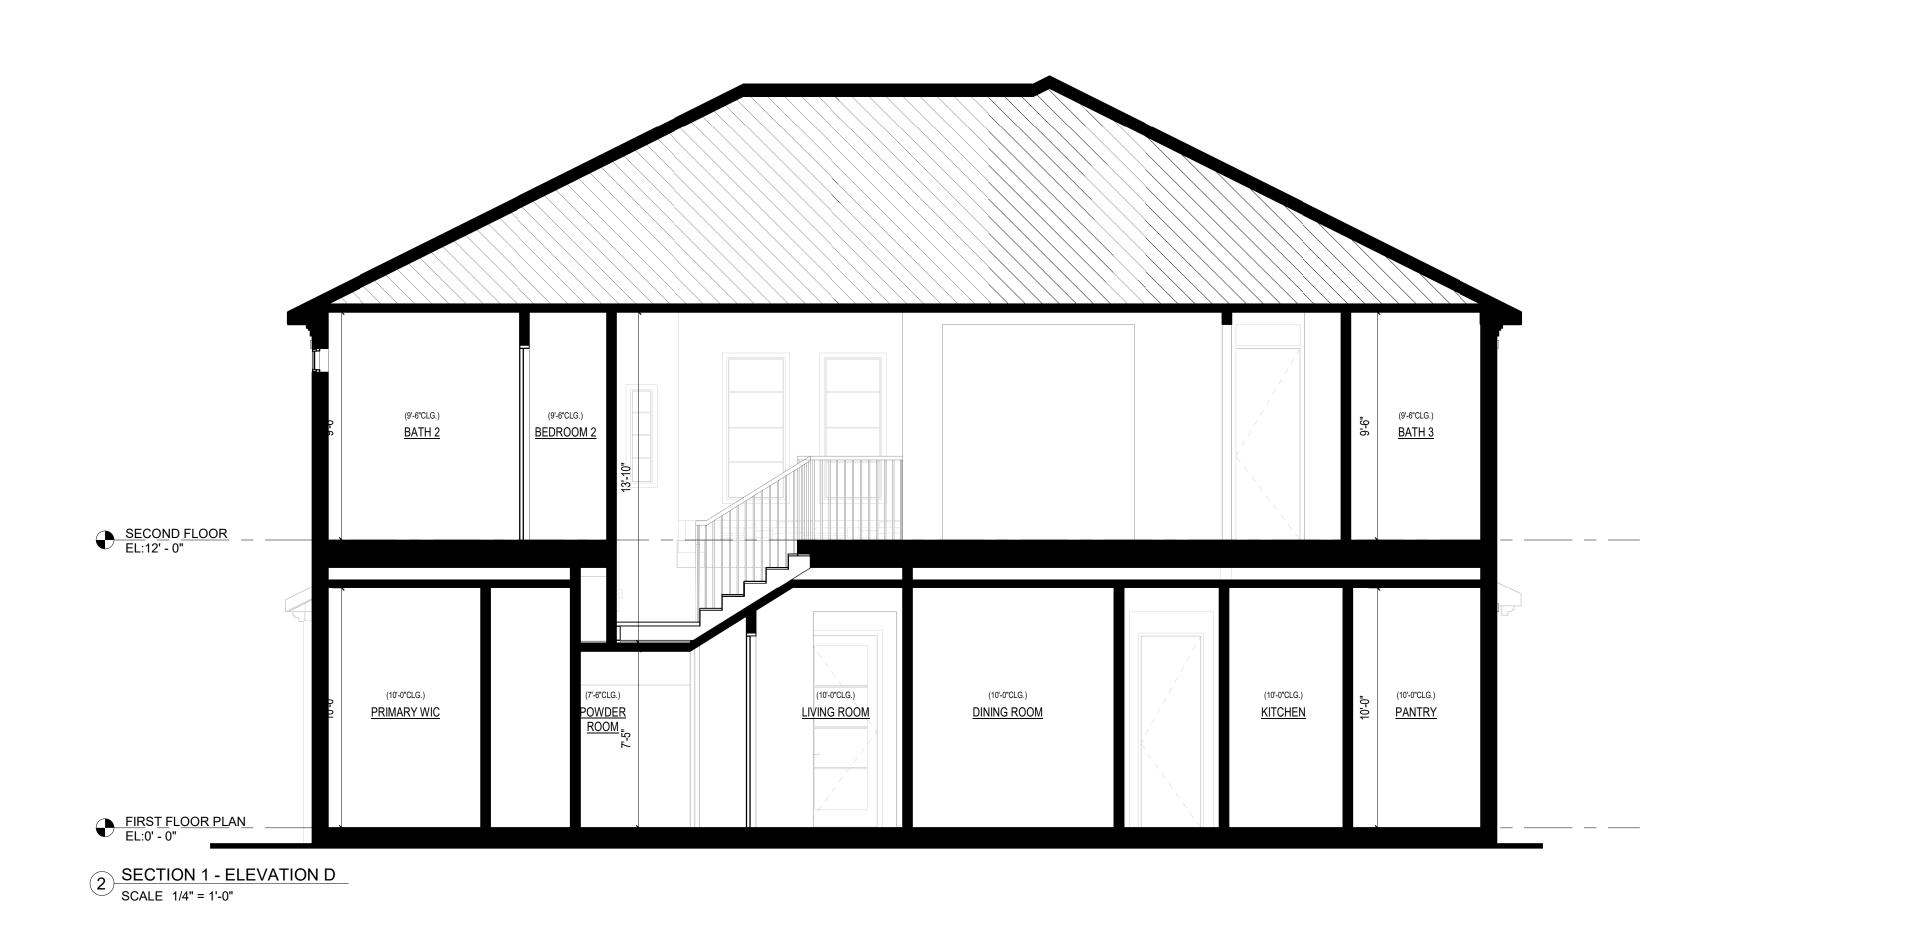 JOB NUMBER
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LEGEND **KEY NOTE**

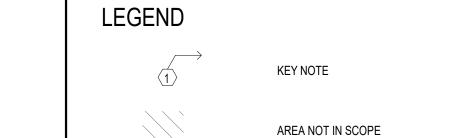AREA NOT IN SCOPE

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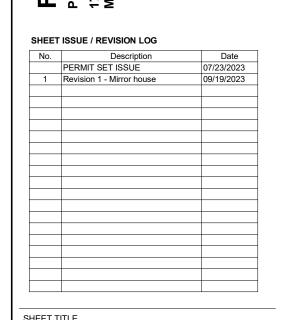
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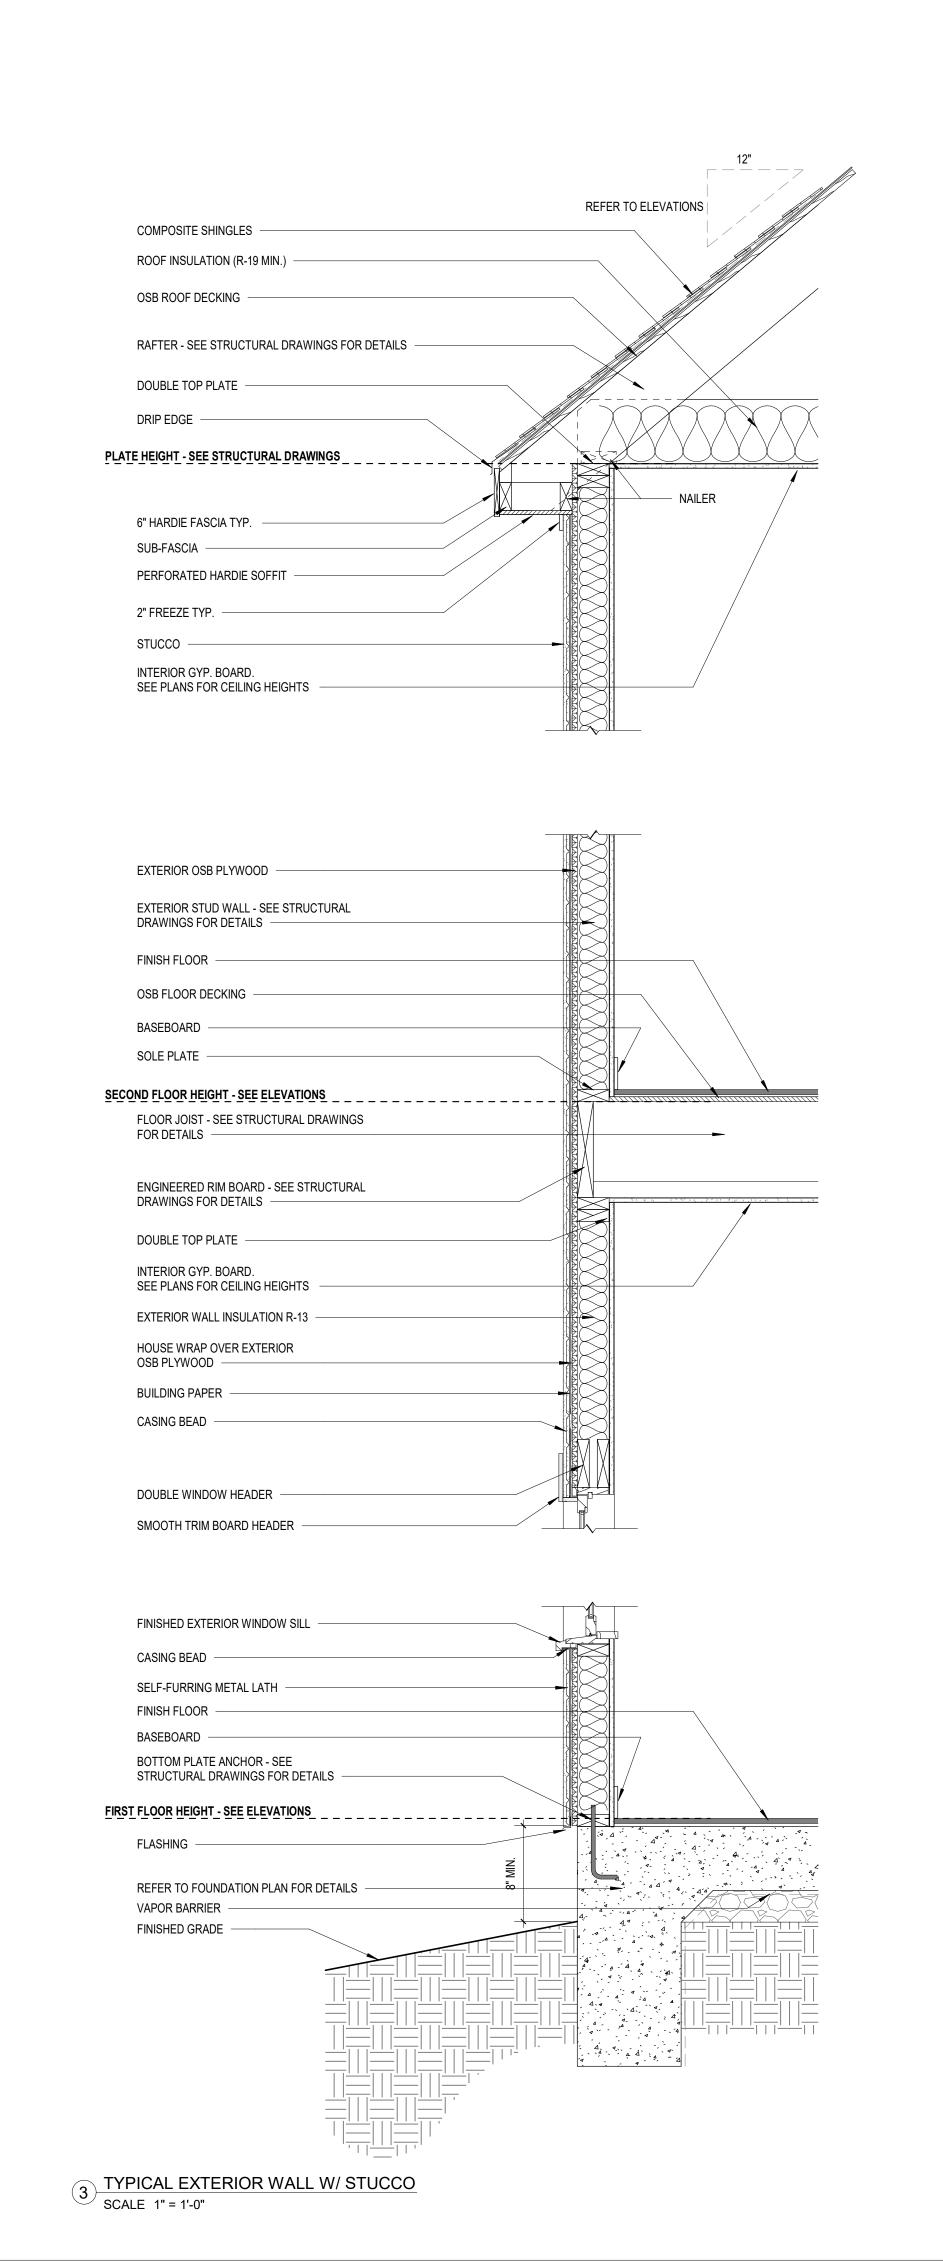
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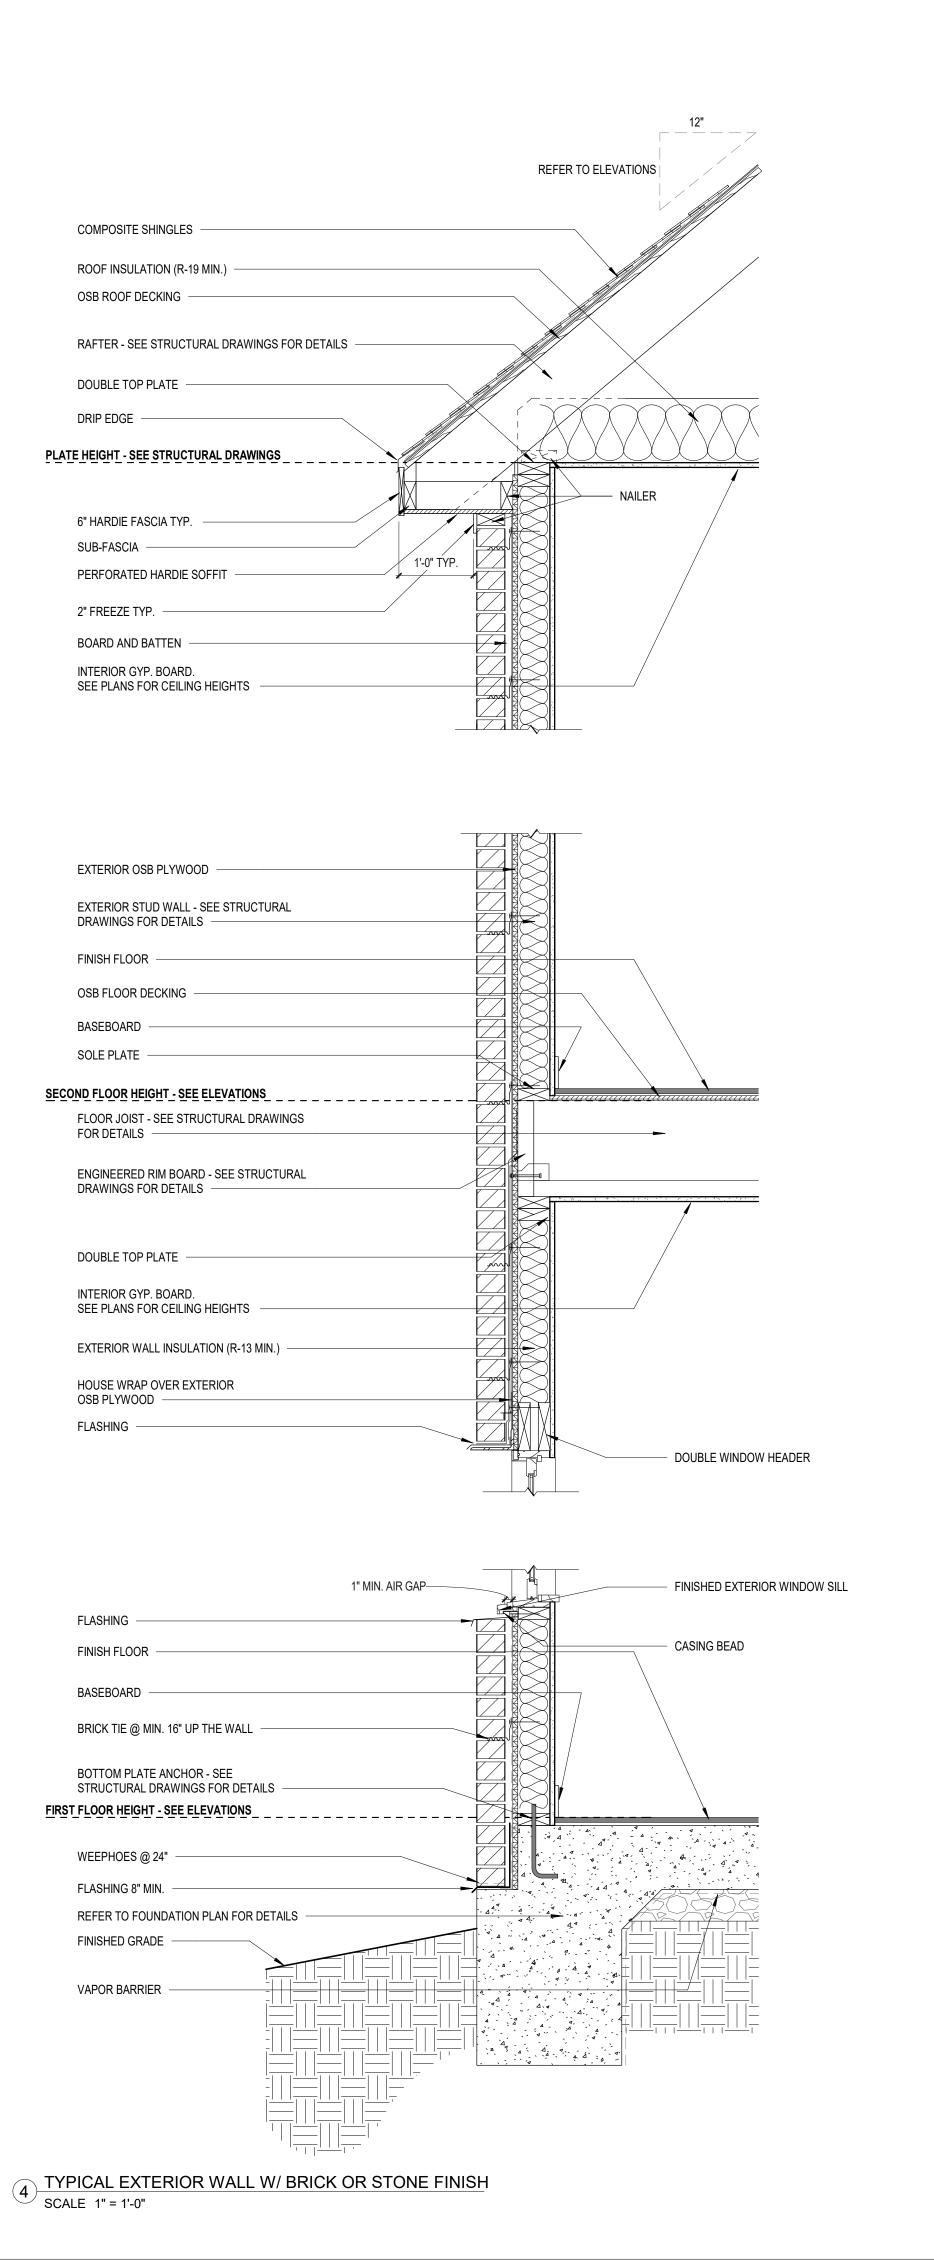


BUILDING SECTIONS

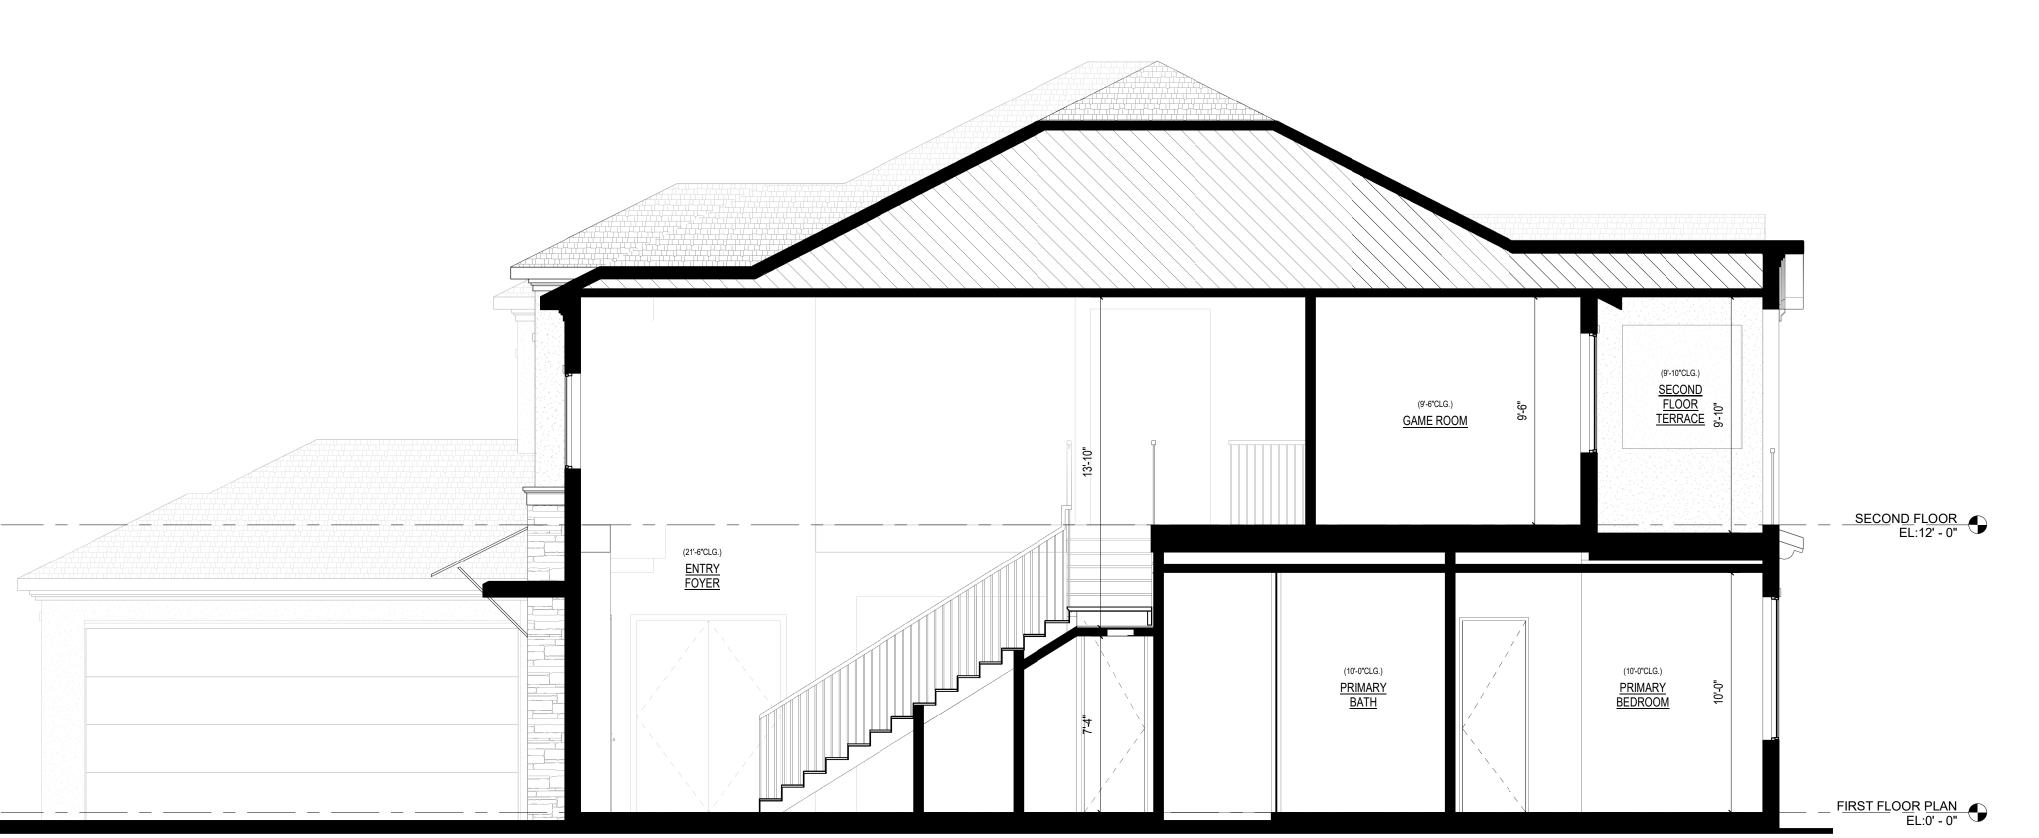SHEET NUMBER JOB NUMBER

A 3.01 DATE 07/23/2023





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MONTGOMERY, TX 77316

No.	Description	Date
	PERMIT SET ISSUE	07/23/2023


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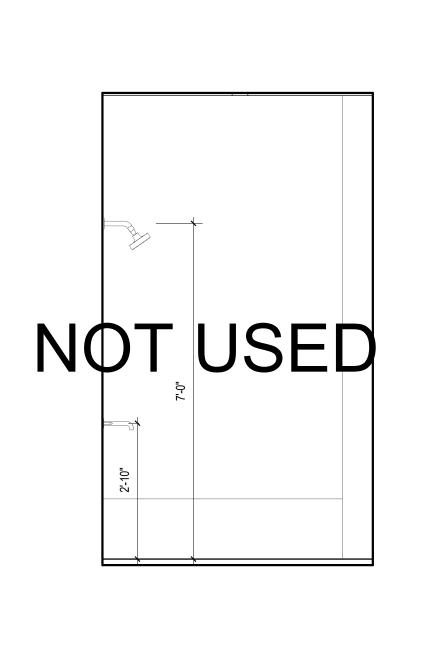
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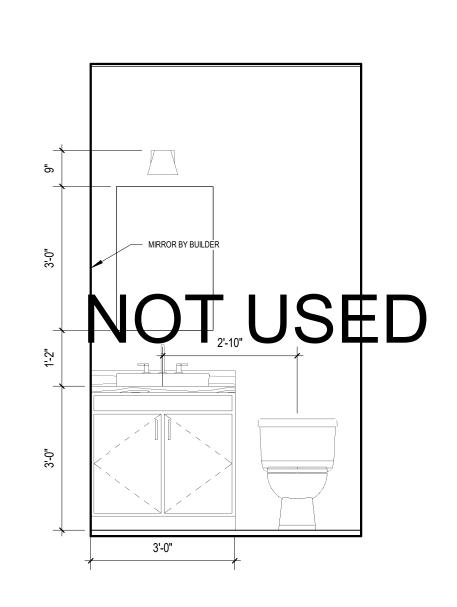
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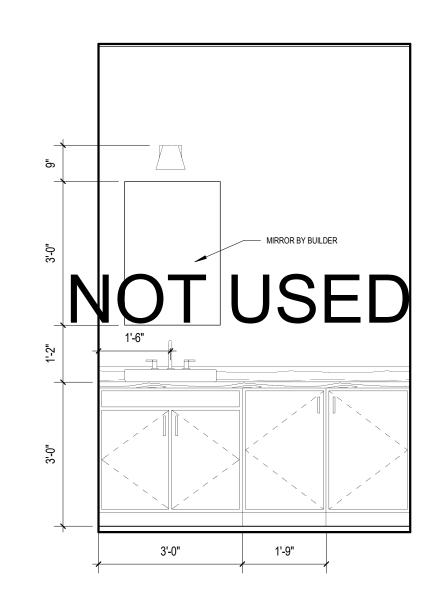




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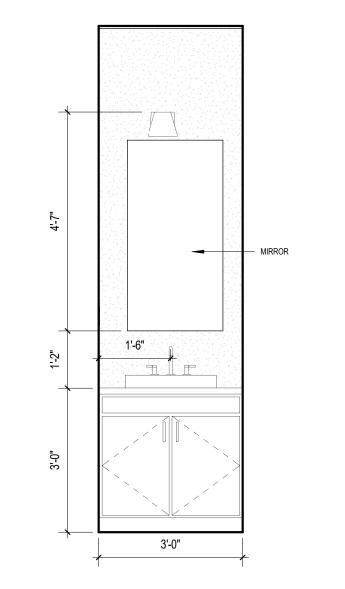


ODESSA - DESIGN OPTION 5 -BEDROOM 5 AND BATH 5 ELEVATION

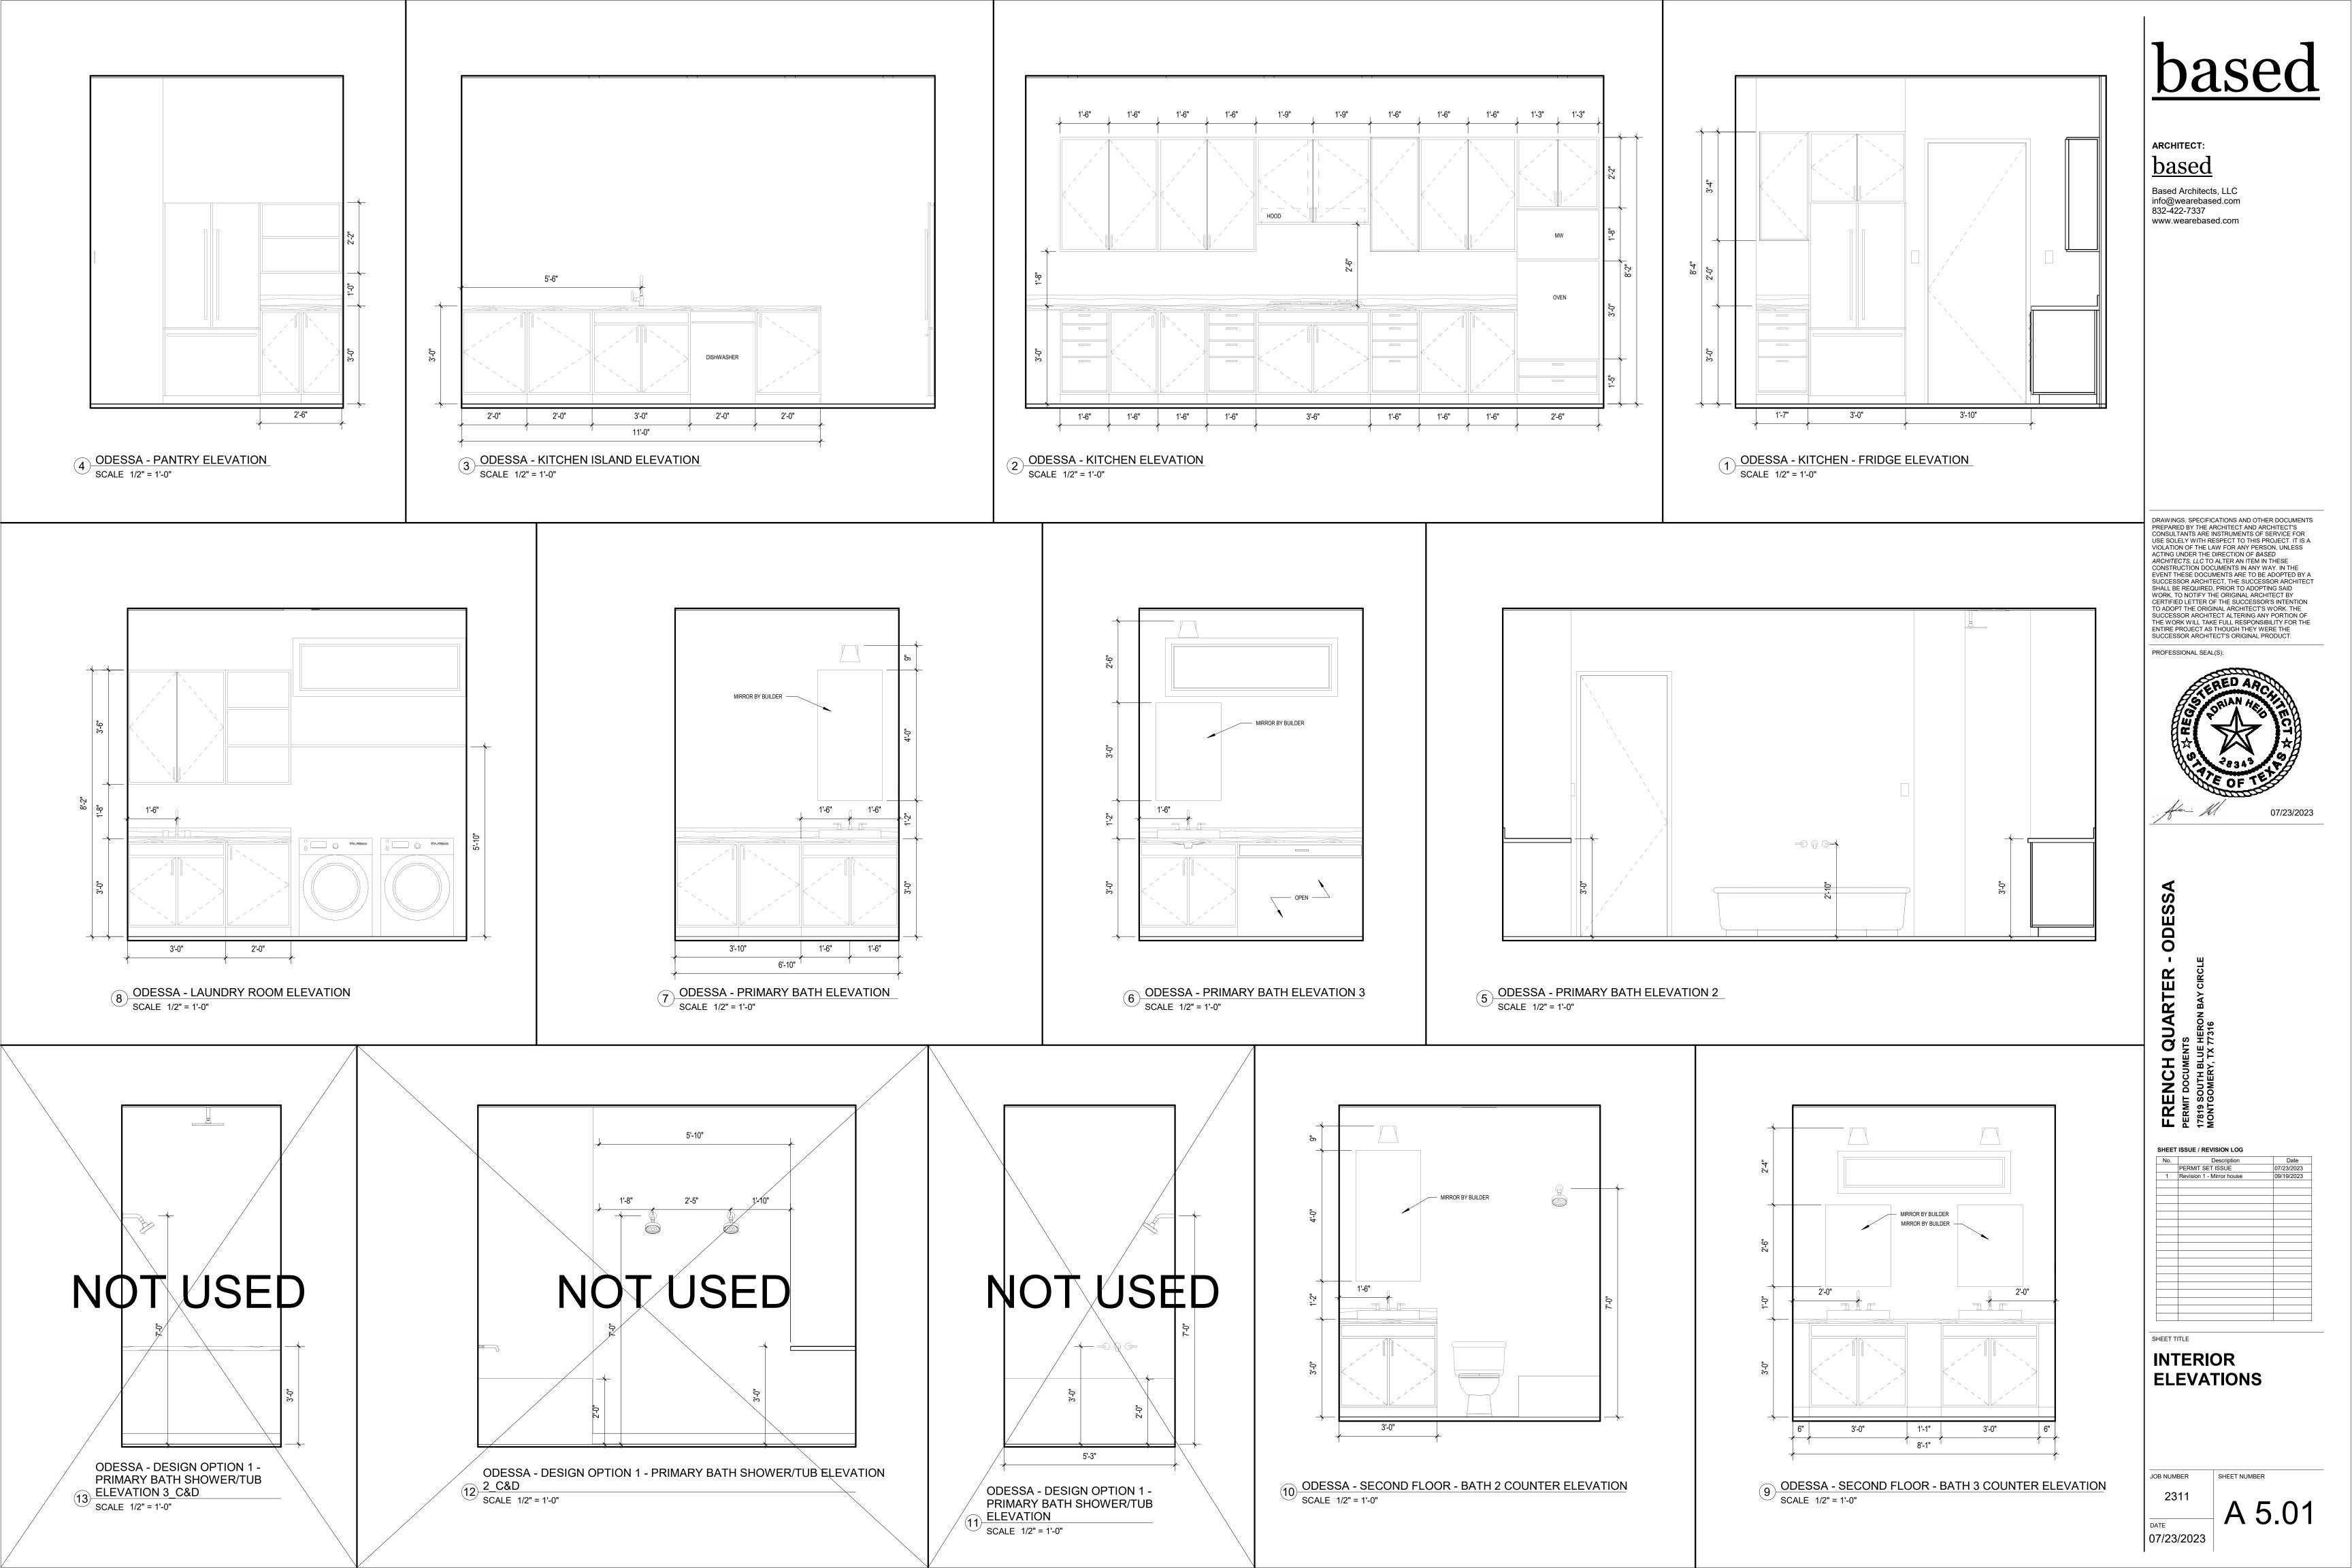

ODESSA - DESIGN OPTION 1 -PRIMARY BATH SHOWER/TUB 2 ELEVATION 5 BATH ELEVATION

SCALE 1/2" = 1'-0" SCALE 1/2" = 1'-0"



ODESSA - DESIGN OPTION 2 - POOL




RAWINGS, SPECIFICATIONS AND OTHER DOCUMENTS

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ODESSA - DESIGN OPTION 1 - PRIMARY BATH SHOWER/TUB ELEVATION 4


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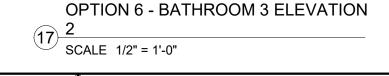



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SCALE 1/2" = 1'-0"

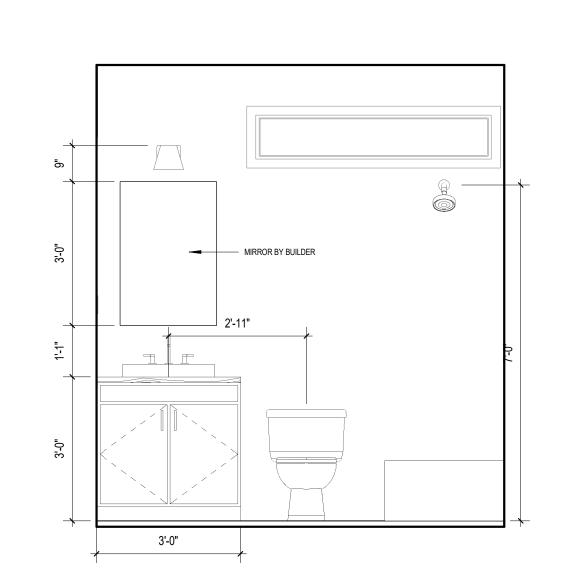


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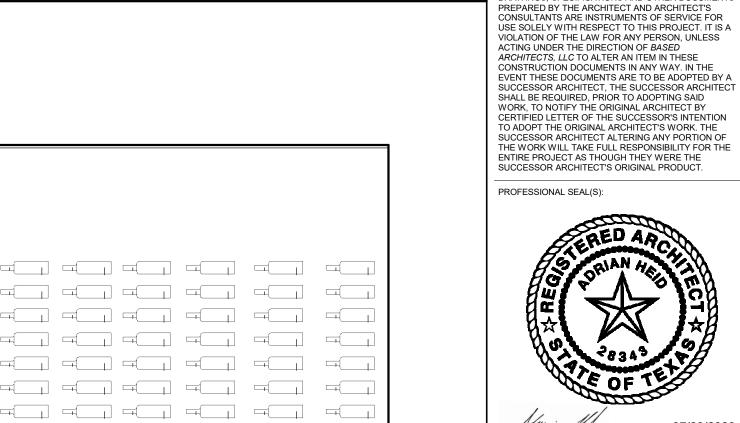


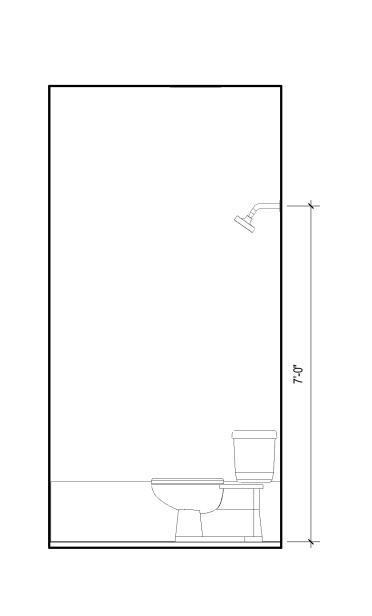


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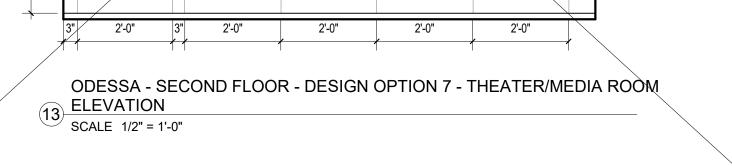


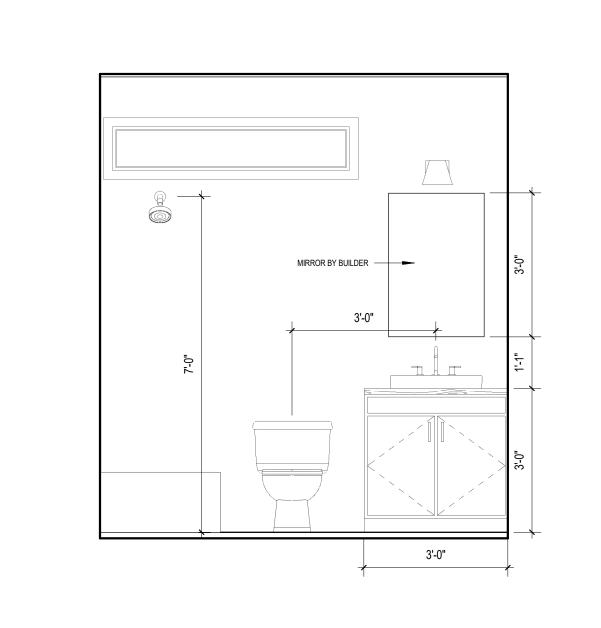00 ODESSA - MUD ROOM ELEVATION
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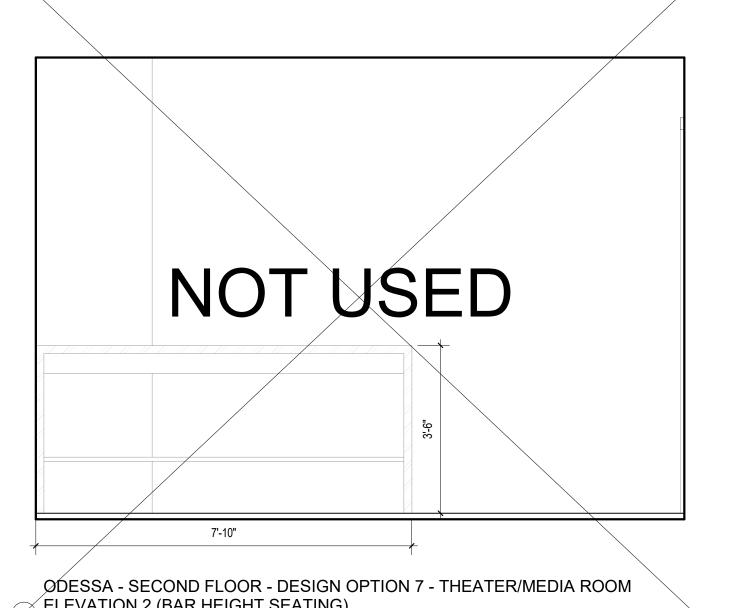


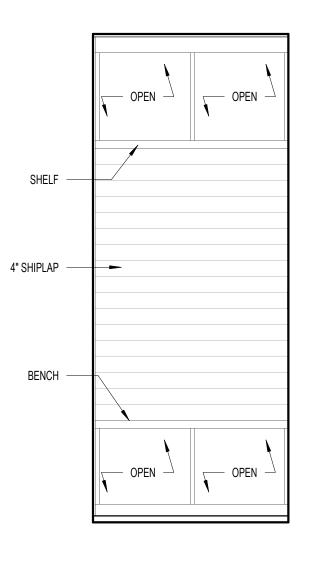9 ODESSA - DESIGN OPTION 3 - WINE RACK ELEVATION SCALE 1/2" = 1'-0"



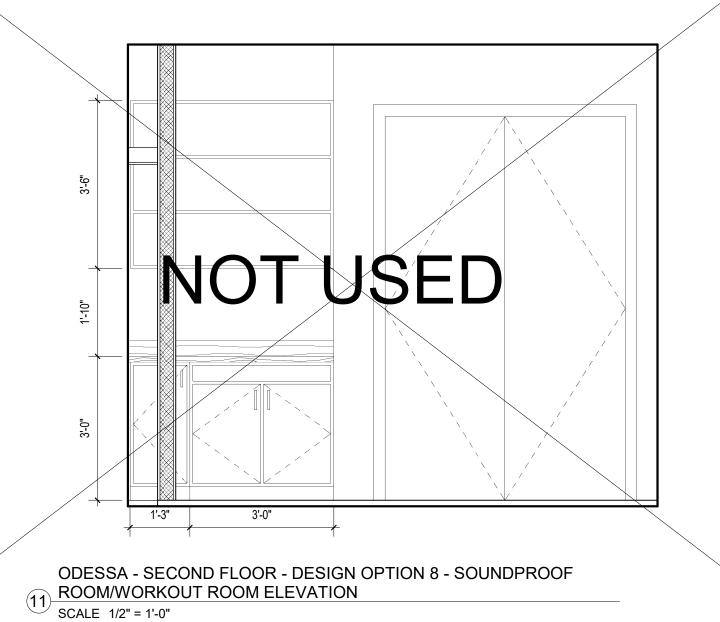


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ELEVATION 2 (BAR HEIGHT SEATING)

SCALE 1/2" = 1'-0"



ODESSA - SECOND FLOOR - DESIGN OPTION 6 - BATHROOM 4 ELEVATION 14 4 SCALE 1/2" = 1'-0"

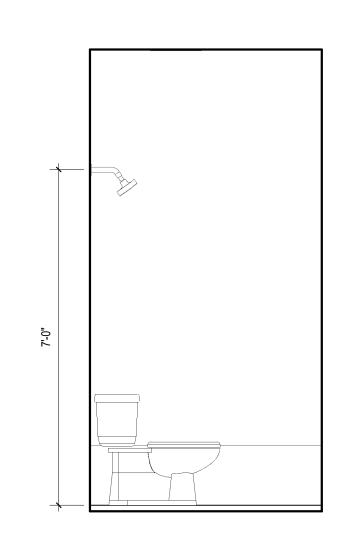ODESSA


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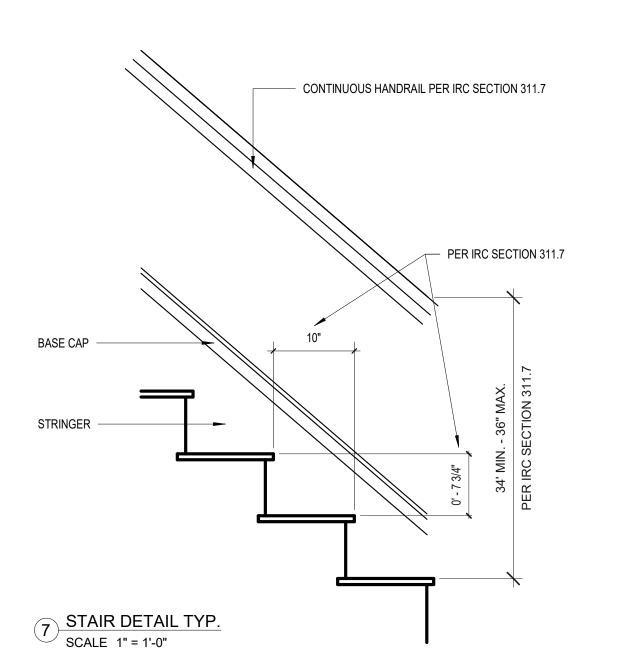
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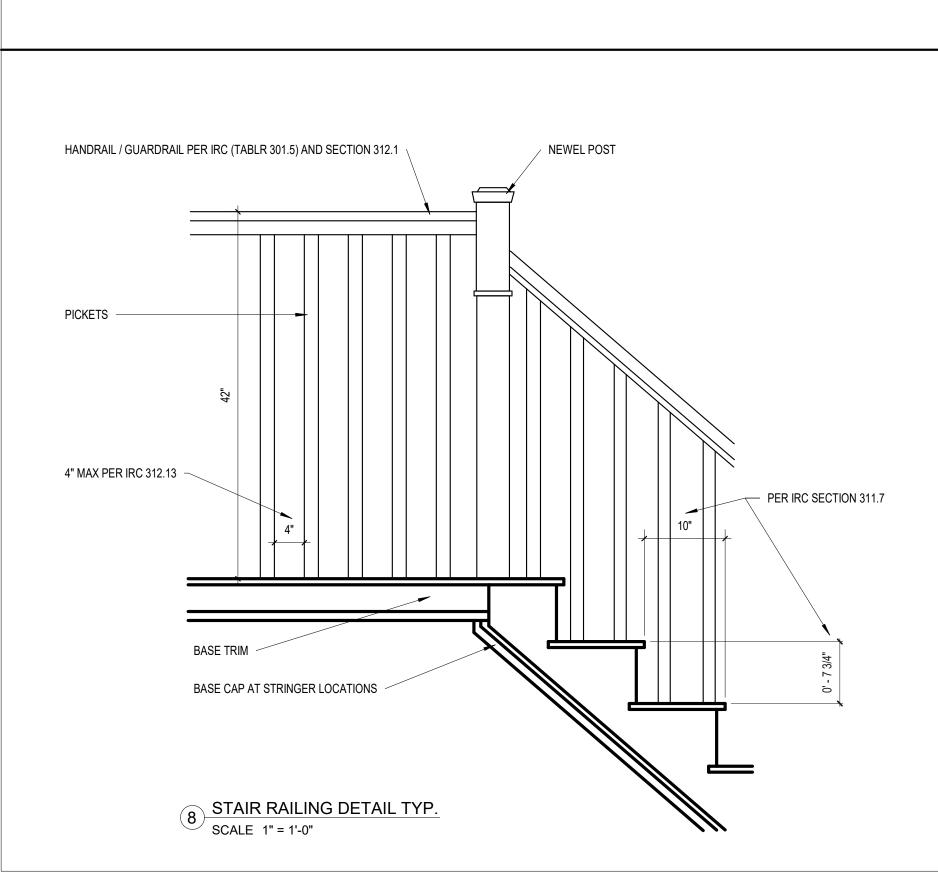
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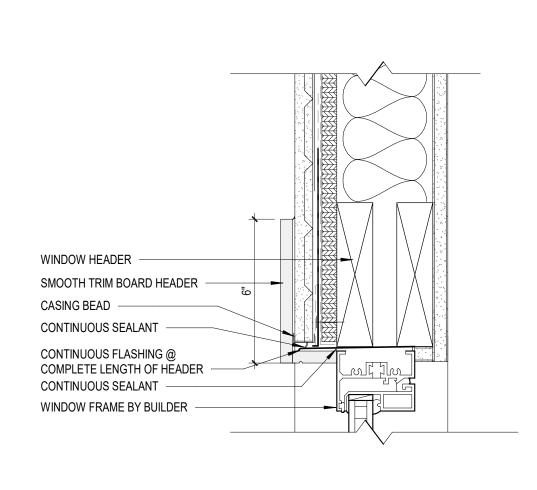
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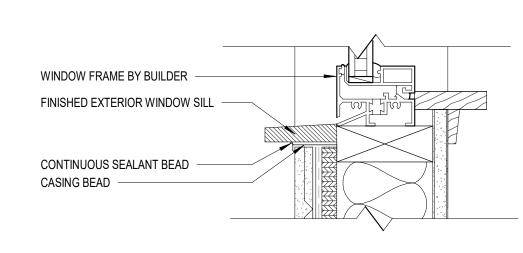
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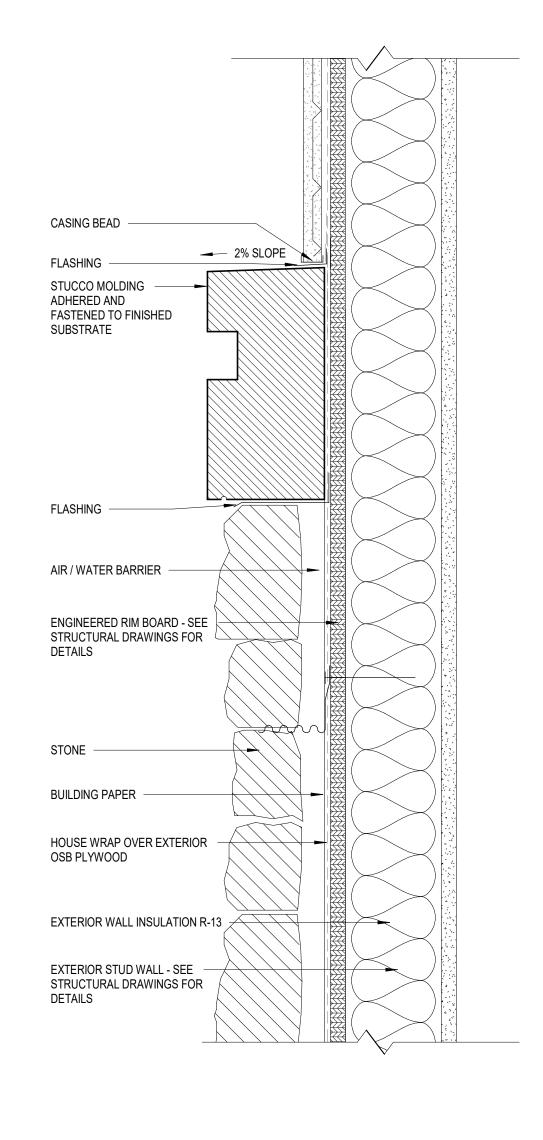












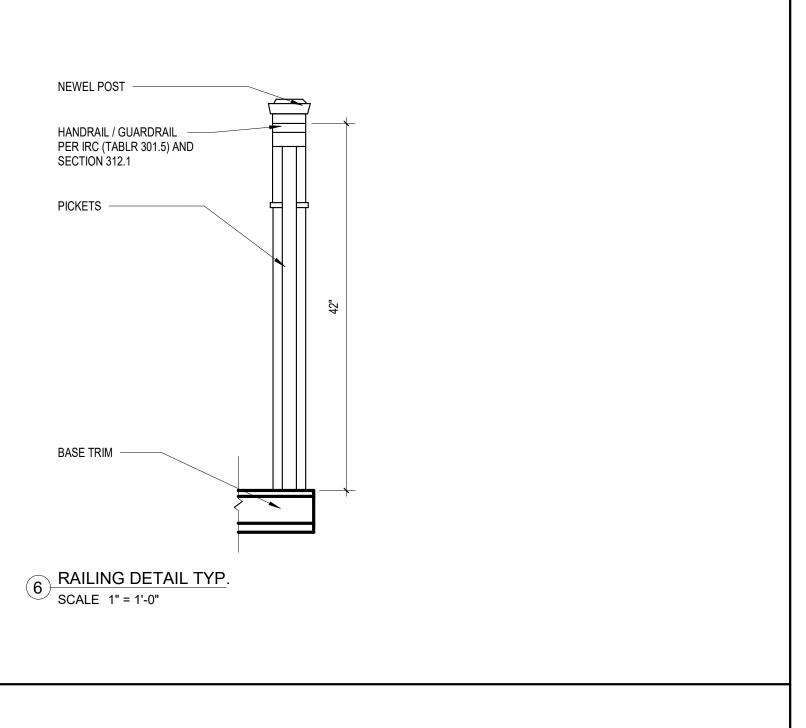

2 TRANSITION DETAIL - STUCCO TERRACE PARAPET SCALE 3" = 1'-0"

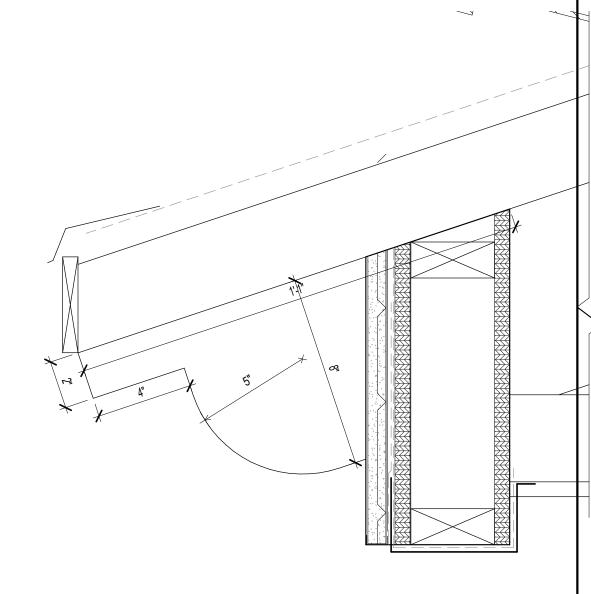


RAFTER TYP. 2 PROFILE DETAIL SCALE 3" = 1'-0"

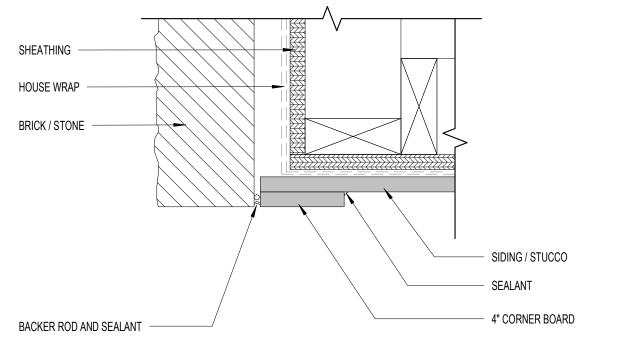


TRANSITION DETAIL - BRICK/STONE TO SIDING / STUCCO CORNER


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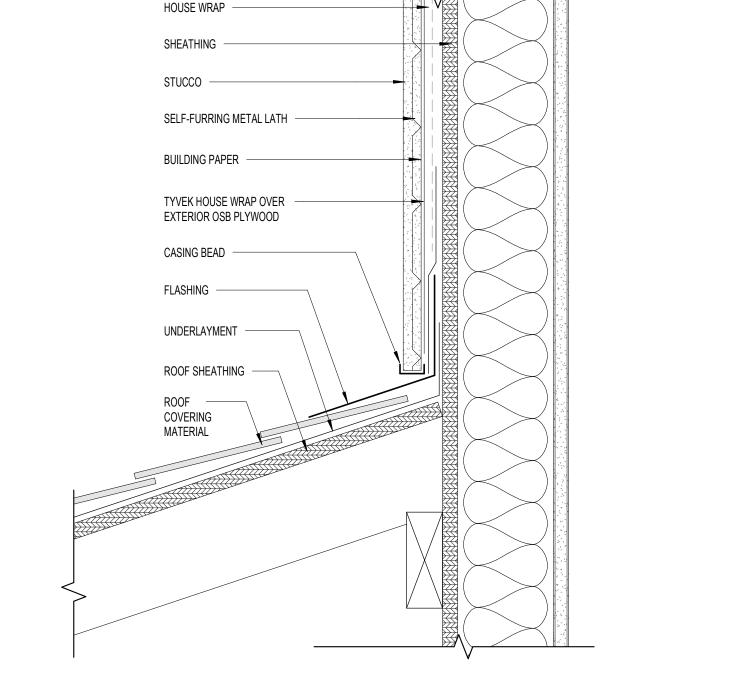


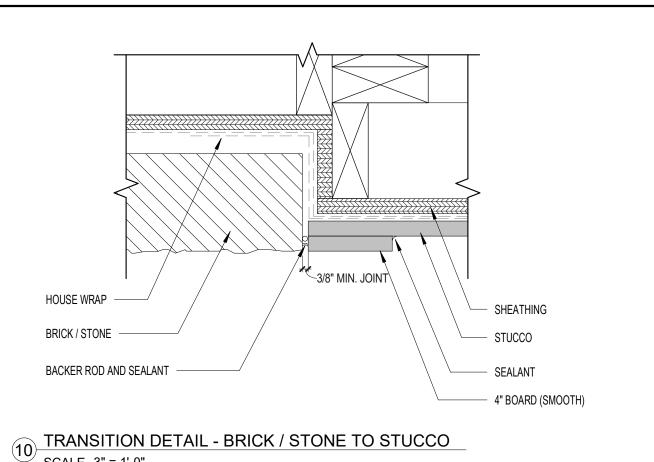10 TRANSITION DETAIL - BRICK / STONE TO STUCCO
SCALE 3" = 1'-0"

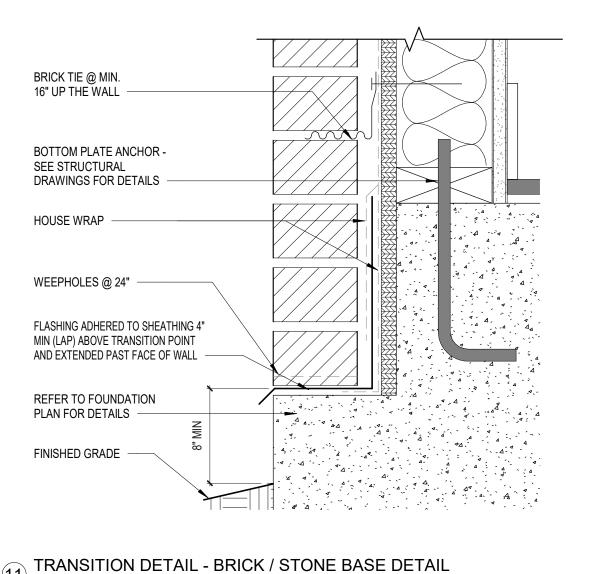


TRANSITION DETAIL - BRICK / STONE BASE DETAIL SCALE 3" = 1'-0"



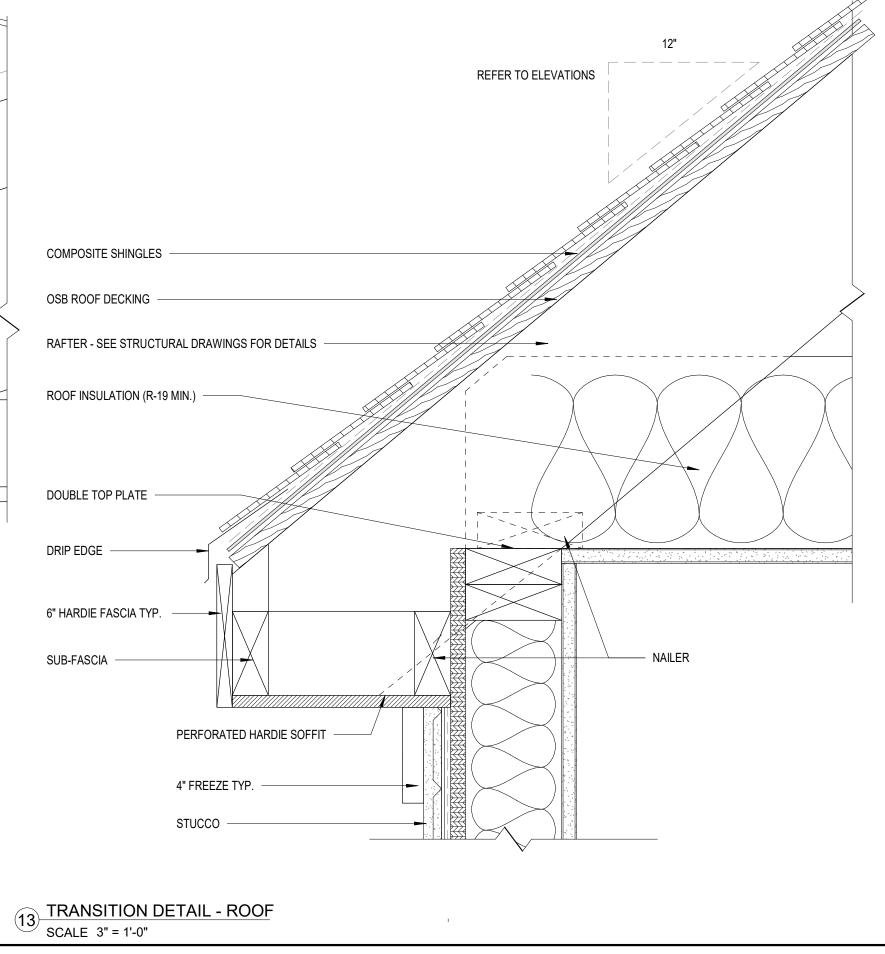


5 TRANSITION DETAIL - HEADWALL ROOF DETAIL - STUCCO SCALE 3" = 1'-0"

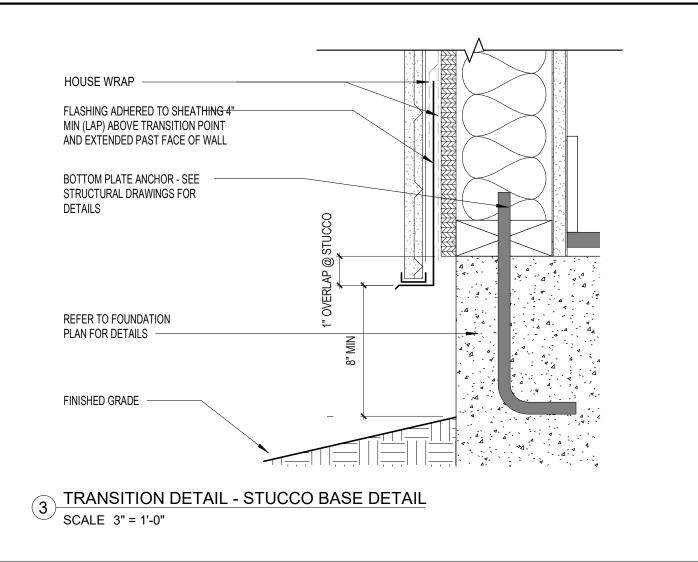


ARCHITECT: <u>based</u>

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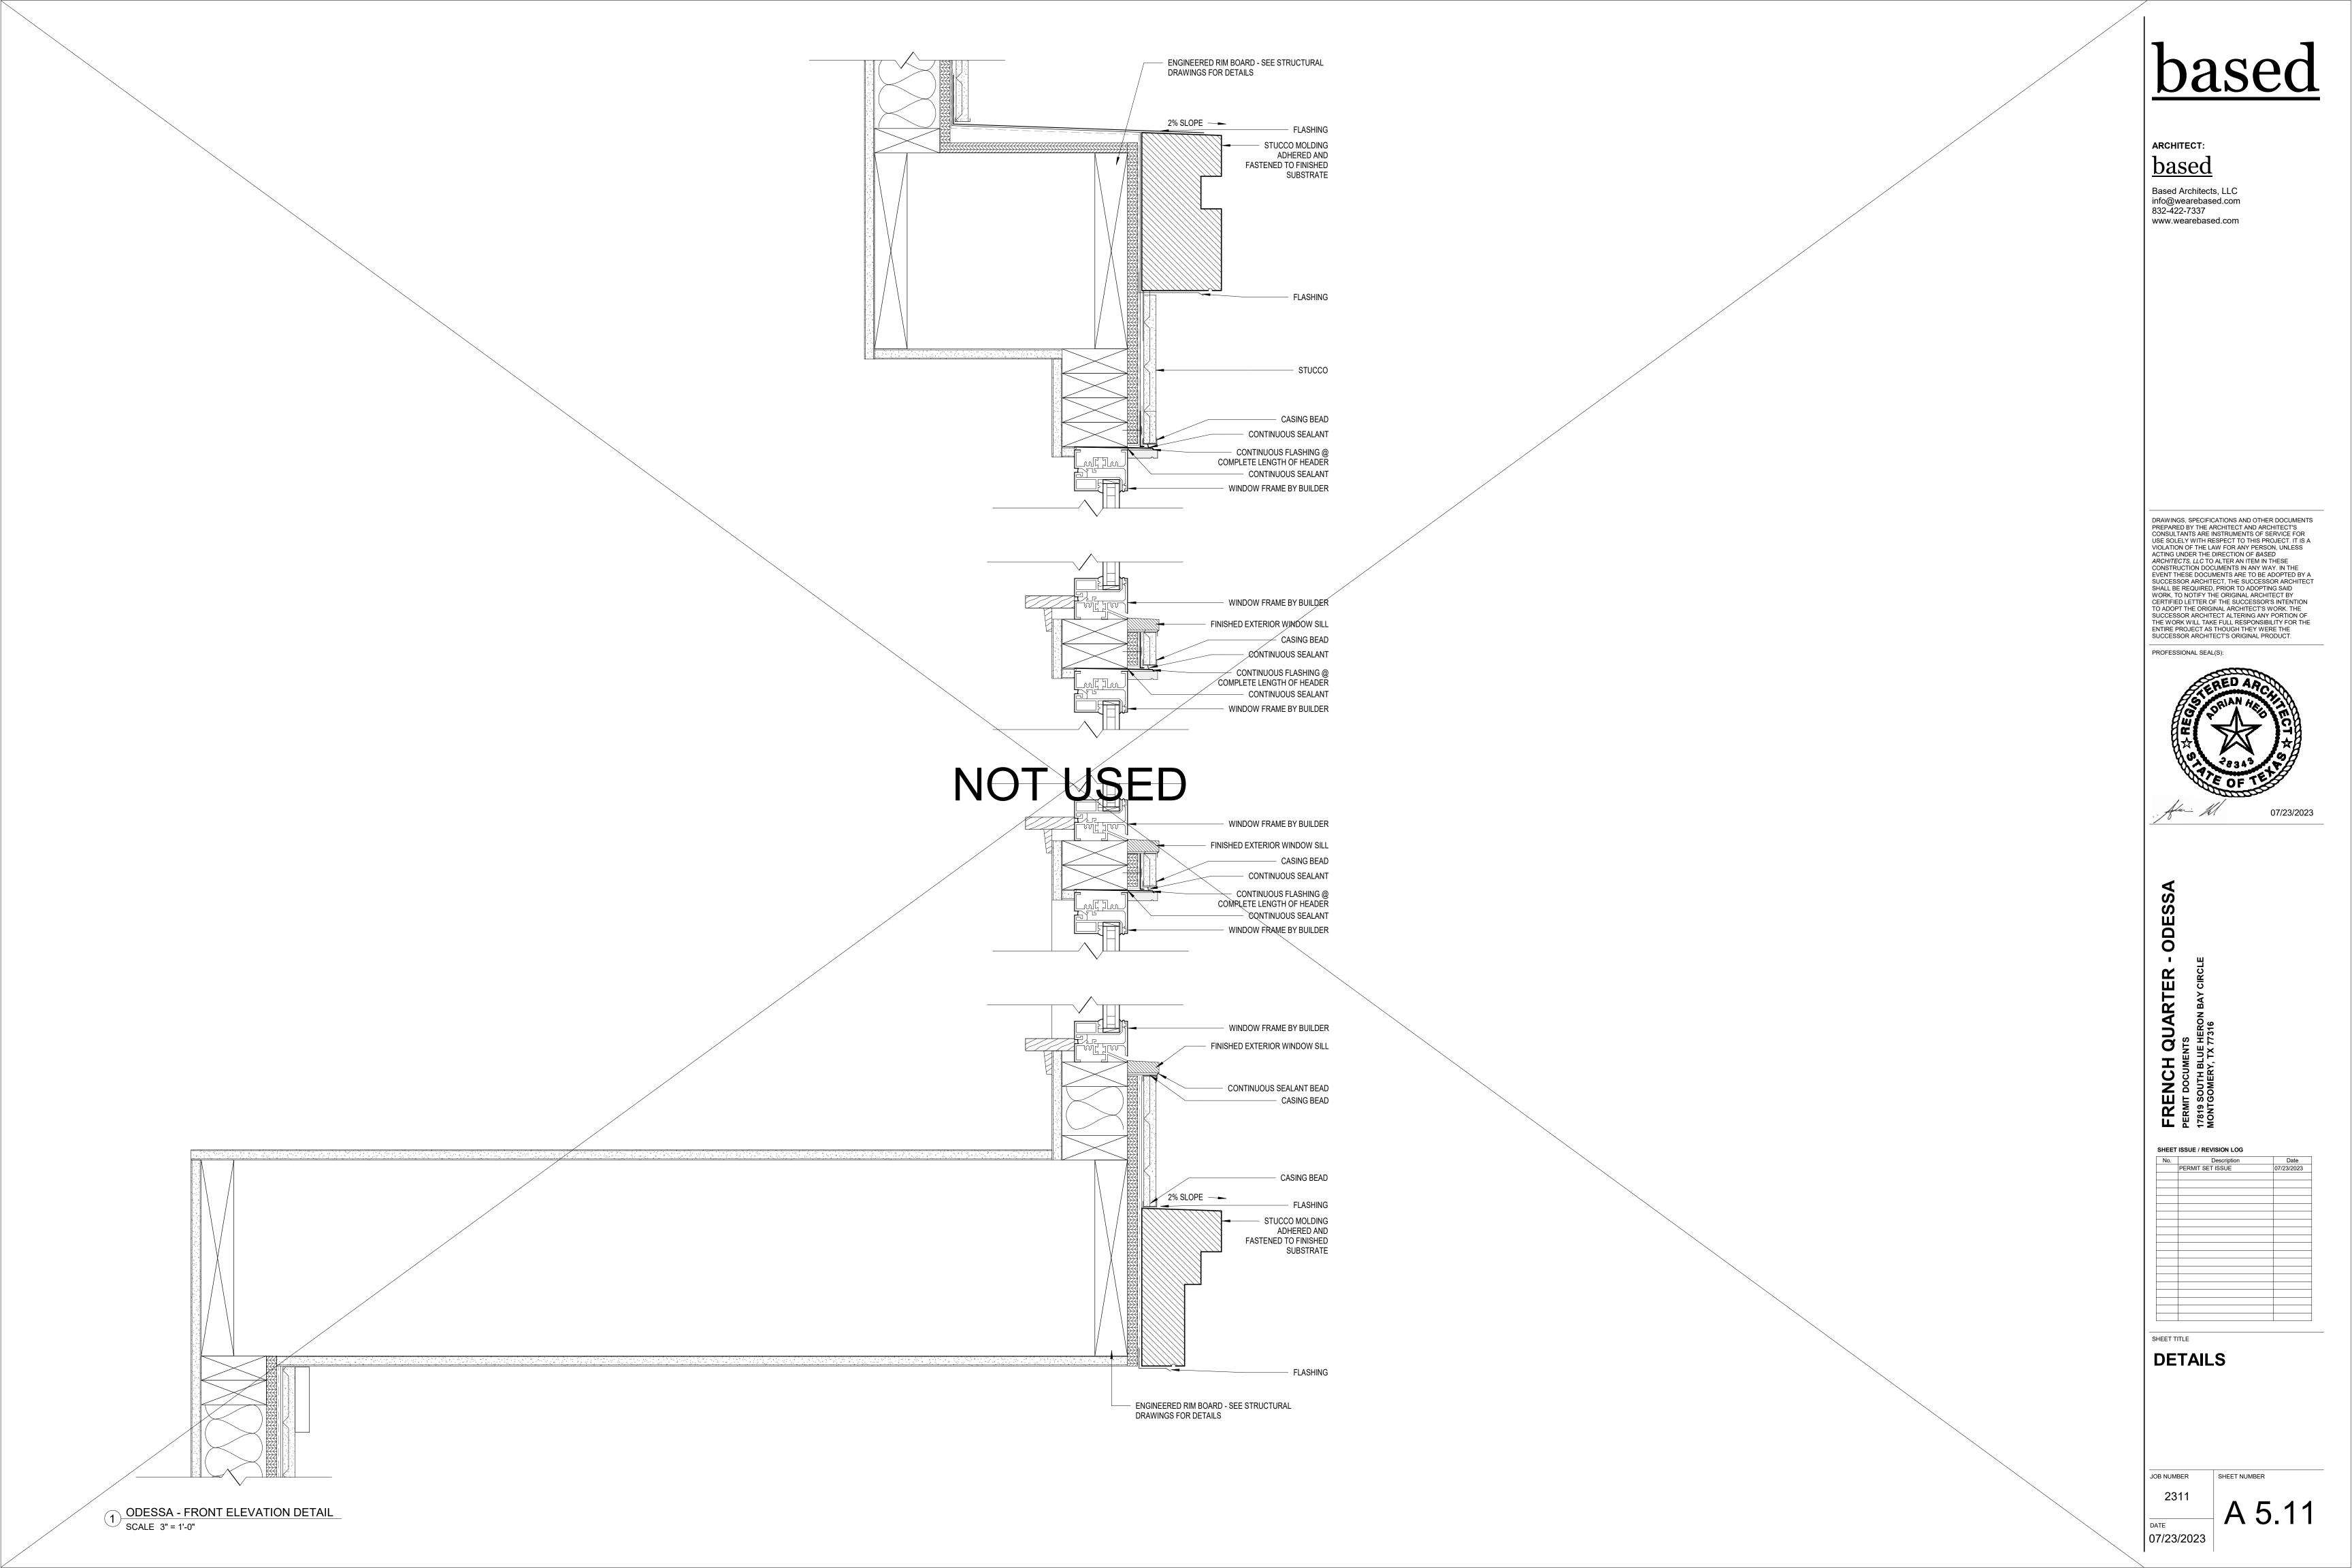


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SHEET TITLE **DETAILS**

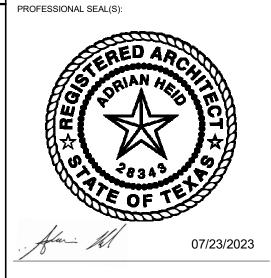SHEET NUMBER JOB NUMBER 07/23/2023

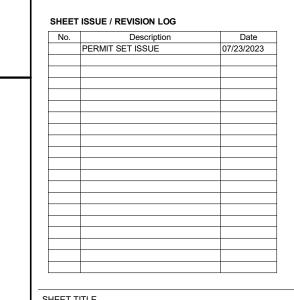

ODESSA - DOOR SCHEDULE - GENERAL - ELEVATION C&D DOOR SIZE DOOR	ODESSA - DOOR SCHEDULE - UPGRADES DOOR SIZE DOOR SIZE DOOR SIZE DOOR SIZE	DESCRIPTION COMMENTS
MARK TYPE WIDTH HEIGHT THICKNESS DOOR FINISH DESCRIPTION COMMENTS FIRST FLOOR PLAN	MARK TYPE WIDTH HEIGHT THICKNESS DOOR FINISH FIRST FLOOR PLAN	DESCRIPTION COMMENTS
1 HH 6' - 0" 8' - 0" 0' - 1 3/4" DOUBLE FRENCH DOOR 2 A 3' - 0" 8' - 0" 0' - 1 3/4" SWING DOOR 1HR RATED 3 HH 6' - 0" 8' - 0" 0' - 1 3/4" DOUBLE SWING DOOR	1U W 16' - 0" 9' - 0" 0' - 0 3/4" 2U E 2' - 8" 8' - 0" 0' - 1 3/4" NOT USED 3U B 2' - 8" 8' - 0" 0' - 1 3/4"	MULTI-SLIDE BYPASS 4-PANEL DESIGN OPTION 4 FRENCH DOOR DESIGN OPTION 2 SWING DOOR DESIGN OPTION 5
4 B 2' - 6" 8' - 0" 0' - 1 3/4" SWING DOOR 5 B 2' - 0" 8' - 0" 0' - 1 3/4" SWING DOOR 6 B 2' - 8" 8' - 0" 0' - 1 3/4" SWING DOOR	NOT USED 4U B 2' - 4" 8' - 0" 0' - 1 3/4" NOT USED 5U B 2' - 0" 8' - 0" 0' - 1 3/4" SECOND FLOOR	SWING DOOR DESIGN OPTION 5 SWING DOOR DESIGN OPTION 5
7 BB 5' - 0" 8' - 0" 0' - 1 3/4" DOUBLE SWING DOOR 8 B 2' - 6" 8' - 0" 0' - 1 3/4" SWING DOOR 9 B 2' - 8" 8' - 0" 0' - 1 3/4" SWING DOOR	NOT USED 6U A 3' - 0" 8' - 0" 0' - 1 3/4" 7U AA 4' - 0" 8' - 0" 0' - 1 3/4" 8U AA 4' - 0" 8' - 0" 0' - 1 3/4"	SWING DOOR DESIGN OPTION 7 DOUBLE FRENCH DOOR DESIGN OPTION 6 DOUBLE FRENCH DOOR DESIGN OPTION 6
10 B 2' - 8" 8' - 0" 0' - 1 3/4" SWING DOOR 11 A 3' - 0" 8' - 0" 0' - 1 3/4" SWING DOOR 12 A 3' - 0" 8' - 0" 0' - 1 3/4" SWING DOOR	NOT USED 9U BB 5' - 0" 8' - 0" 0' - 1 3/4" 50U F 3' - 0" 9' - 0" 0' - 0"	DOUBLE SWING DOOR DESIGN OPTION 8 OPENING DESIGN OPTION 6
13 B 2' - 6" 8' - 0" 0' - 1 3/4" SWING DOOR 14 B 2' - 4" 8' - 0" 0' - 1 3/4" SWING DOOR 15 A 3' - 0" 8' - 0" 0' - 1 3/4" SWING DOOR 1HR RATED		
16 HH 6' - 0" 8' - 0" 0' - 1 3/4" DOUBLE FRENCH DOOR 50 F 3' - 0" 9' - 0" O' - 0" OPENING 51 F 5' - 0" 9' - 0" O' - 0" OPENING		
52 F 8' - 0" 9' - 0" 0' - 0" OPENING 53 F 3' - 6" 9' - 0" 0' - 0" OPENING 54 F 3' - 6" 9' - 0" 0' - 0" OPENING		
55 F 3' - 6" 9' - 0" 0' - 0" OPENING 56 F 3' - 6" 9' - 0" 0' - 0" OPENING 57 F 3' - 6" 9' - 0" 0' - 0" OPENING		
58 F 3' - 0" 9' - 0" 0' - 0" OPENING 59 F 6' - 6" 9' - 0" 0' - 0" OPENING 100 R 9' - 0" 8' - 0" 0' - 1 1/2" SECTIONAL GARAGE DOOR		
101 R 18' - 0" 8' - 0" 0' - 1 1/2" SECTIONAL GARAGE DOOR SECOND FLOOR SECOND FLOOR SECTIONAL GARAGE DOOR SECOND FLOOR SECTIONAL GARAGE DOOR SECT		
20 B 2' - 8" 8' - 0" 0' - 1 3/4" SWING DOOR 21 B 2' - 8" 8' - 0" 0' - 1 3/4" SWING DOOR 22 B 2' - 8" 8' - 0" 0' - 1 3/4" SWING DOOR		
23 BB 5'-0" 8'-0" 0'-13/4" DOUBLE SWING DOOR 24 B 2'-8" 8'-0" 0'-13/4" SWING DOOR 25 B 2'-8" 8'-0" 0'-13/4" SWING DOOR		
26 B 2' - 4" 8' - 0" 0' - 1 3/4" SWING DOOR 27 B 2' - 8" 8' - 0" 0' - 1 3/4" SWING DOOR 28 B 2' - 8" 8' - 0" 0' - 1 3/4" SWING DOOR		
29 B 2' - 4" 8' - 0" 0' - 1 3/4" SWING DOOR 30 B 2' - 8" 8' - 0" 0' - 1 3/4" SWING DOOR 31 B 2' - 8" 8' - 0" 0' - 1 3/4" SWING DOOR		
60 F 8' - 0" 9' - 0" 0' - 0" OPENING 61 F 2' - 8" 9' - 0" 0' - 0" OPENING 62 F 2' - 8" 9' - 0" 0' - 0" OPENING		
63 F 4' - 0" 9' - 0" 0' - 0" OPENING 64 F 5' - 0" 9' - 0" 0' - 0" OPENING		
DOOR TYPES SIDE LITE WHERE OCCURS AND		
OVERALL DOOR WIDTH OVERALL DOOR WIDTH OVERALL DOOR WIDTH AS NOTED IN THE SCHEDULE IN SCHEDULE	OVERALL WIDTH IN SCHEDULE	GENERAL NOTES
		1. VERIFY ALL DIMENSIONS IN FIELD PRIOR TO PRODUCTION 2. CONTRACTOR SHALL VERIFY WITH WINDOW AND DOOR MANUFACTURER THE ROUGH OPENING DIMENSIONS PRIOR TO ORDERING MANUFACTURING OR INSTALLING DOORS AND WINDOWS.
HEDULE HEDULE SCHEDULE SCHEDUL		 ALL UNIT FRAMES SHALL BE FINISHED WITH A COATING FINISH SELECTED BY ARCHITECT. STRUCTURAL MEMBERS SHOWN ARE NOT PROVIDED IN APERTURE PACKAGE AND CONTRACTOR SHALL COORDINATE WITH STRUCTURAL DRAWINGS. ALL NEW WINDOWS AND DOORS UNDER SEPARATE PERMIT.
VERALL DOOR HEIGH IN SCHEDULE		 GLASS AREA IN WINDOWS 42" A.F.F. THAT ARE LOCATED ABOVE GRADE DROPS > 30" SHALL PASS ANSI TEST: Z91.1 1984. WINDOW WITH SILL HEIGHT LESS THAN 36" AND WITH A DROP MORE THAN 4' ON THE FAR SIDE SHALL BE PROVIDED WITH SAFEGUARDS. ALL GLAZING TO MEET MINIMUM REQUIREMENTS FOR COMPLIANCE: SHGC = < .25 AND U-FACTOR = < .75 GENERAL CONTRACTOR TO SUBMIT SHOP DRAWINGS TO ARCHITECT FOR REVIEW AND APPROVAL.
		S. CEMENTE CONTINUE TO COMMITTED TO MINOR TO MINOR TO MINOR THE CONTINUE TO MINOR THE CO
TYPE A TYPE B TYPES BB, EE TYPE HH TYPE F (SOLID CORE (HOLLOW CORE (PAIR) (FRENCH DOUBLE (OPENING)	TYPE R SECTIONAL GARAGE DOOR	
WOOD FLUSH) DOOR)		
	CHEDULE - ELEVATION D	
	AME SIZE HEIGHT TYPE MATERIAL GLASS COUNT	
A1 A 2' - 6" 5' - 0" SINGLE HUNG BY BUILDER LOW-E CLEAR 6 A2 A 2' - 6" 6' - 0" SINGLE HUNG BY BUILDER LOW-E CLEAR 2 B1 B 2' - 0" 6' - 0" FIXED BY BUILDER LOW-E CLEAR 3	5' - 0" SINGLE HUNG BY BUILDER LOW-E CLEAR 6 6' - 0" SINGLE HUNG BY BUILDER LOW-E CLEAR 2 1' - 0" FIXED BY BUILDER LOW-E CLEAR 2	
B2 B 3'-0" 6'-0" FIXED BY BUILDER LOW-E CLEAR 4 B3 B 4'-0" 6'-0" FIXED BY BUILDER LOW-E CLEAR 1 B4 B 2'-0" 5'-0" FIXED BY BUILDER LOW-E CLEAR 4 D1 D 2'-0"	1'-0" FIXED BY BUILDER LOW-E CLEAR 1 1'-6" FIXED BY BUILDER LOW-E CLEAR 3 3'-0" FIXED BY BUILDER LOW-E CLEAR 2	
B5 B 2'-0" 5'-1" IXED BY BUILLER LOW-E CLEAR 6 B6 B 3'-0" 5'-0 IXED BY BUILLER LOW-E CLEAR 1 C4 C 5'-0" 4'-0" AVEC BY BUILLER LOW-E CLEAR 2	1	
C5 C 4'-0" 1'-0" FIXED BY BUILDER LOW-E CLEAR 1 F3 F4 F4 F5 F5 F5 F5 F5 F5	6' - 0" FIXED BY BUILDER LOW-E CLEAR 1 5' - 0" FIXED BY BUILDER LOW-E CLEAR 4 4' - 0" FIXED BY BUILDER LOW-E CLEAR 2	
D2 D 1'-6" 4'-0" FIXED BY BUILDER LOW-E CLEAR 5 E1 E 2'-0" 2'-6" FIXED BY BUILDER LOW-E CLEAR 9 J1 J 6'-0" 8'-0" FIXED BY BUILDER LOW-E CLEAR 2	5' - 0" FIXED BY BUILDER LOW-E CLEAR 1 5' - 0" FIXED BY BUILDER LOW-E CLEAR 1	
TO TO TO TO TO TO TO TO	5' - 0" FIXED BY BUILDER LOW-E CLEAR 2 4' - 0" FIXED BY BUILDER LOW-E CLEAR 2	
NOT USED J1 F 2 - 6" 6' - 0"	6' - 0" FIXED BY BUILDER LOW-E CLEAR 2	
WINDOW TYPES	SEE SCHEDULE	
SEE SCHEDULE		
SE SCHEDNIE RESCHEDNIE	HEDDLE SHEDLE	EGRESS WINDOWS
SEE ELEVATIONS	SEE SC	WINDOW SHALL BE OPERABLE FROM THE INSIDE WITHOUT THE USE OF TOOLS AND PROVIDE A CLEAR OPENING OF NOT LESS THAN 20" IN WIDTH, 24" IN HEIGHT AND 5.7 SQ. FT. IN AREA. THE BOTTOM OF THE WINDOW OPENING SHALL NOT BE MORE THAN 44" OFF THE FLOOR. NO PART OF THE OPERATING MECHANISM SHALL BE HIGHER THAN 54" OFF THE FLOOR.
S E FOR MUNTIN LOCATIONS		TAIL OF THE OF ENATING MEGINATION OF MEETING HER THAIR OF OUT THE LEVOIS.
TYPE A TYPE B TYPE C TYPE D TYPE E TYPE F (SINGLE HUNG (FIXED (FIXED (FIXED WINDOW) (FIXED WINDOW) (FIXED WINDOW) WINDOW) WINDOW) WINDOW)	TYPE J (2-FIXED WINDOW)	

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WINDOW AND DOOR SCHEDULES

A 6.00 DATE 07/23/2023